ANCHORAGE SCHOOL DISTRICT

Spring Hill Elementary School Roof Replacement

Abbott Rd ←

Unite Church

→ ↓ ↑ Abbott Rd

Abbott Rd

Spring Hill Elementary

PROJECT LOCATION: SPRING HILL ELEMENTARY

LEGAL DESCRIPTION:

TRACT B-1, SECTION 16,

T12N, R3W, S.M., ALASKA

9911 LAKE OTIS PARKWAY ANCHORAGE, ALASKA 99507

SCHOOL SITE

9911 Lake Otis Pkwy, Anchorage, AK 99507

100% BID DOCUMENTS

← Abbott Rd ← Abbott Rd

Fred Meyer Pharmacy

Coinstar Kiosk

Independence Park Manor I & II Fred Meyer Fuel Center

The Loft Hair Design

Mo's Deli and Catering 📊

Real Estate Solutions of Alaska

3D VIEW

LOCATION MAP


bbott Rd →

AT&T Store Cell phone store

PERMIT STAMP

02/14/2024

PROJECT DESCRIPTION

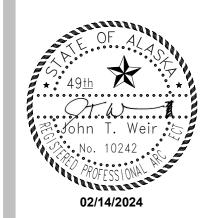

ALTERNATES

NOTIFICATIONS

ASBESTOS, LEAD AND OTHER POTENTIALLY HAZARDOUS MATERIALS ARE PRESENT IN THE BUILDING THAT MAY IMPACT THE WORK OF ALL TRADES. REGULATED AIR CONTAMINANTS, AND ON ARCHITECTURAL, STRUCTURAL, MECHANICAL AND ELECTRICAL COMPONENTS OR SYSTEMS THROUGHOUT THE BUILDING. ALL TRADES SHALL COORDINATE WITH OTHER TRADES AND CONDUCT THEIR WORK TO PREVENT WORKER EXPOSURE OR SITE CONTAMINATION. REFER TO SPECIFICATION DIVISIONS 0, 1 AND 2 FOR SPECIFIC INFORMATION CONCERNING DISTURBING, REMOVING AND DISPOSING OF THESE MATERIALS AND THE INSTALLATION OF NEW MATERIALS OR COMPONENTS. THIS NOTIFICATION IS PROVIDED IN ACCORDANCE WITH EPA AND

NOTIFICATION OF CHILD OCCUPIED FACILITY

PORTIONS OF THIS BUILDING ARE CLASSIFIED AS A CHILD OCCUPIED FACILITY IN ACCORDANCE WITH 40 CFR 745 AND LEAD-BASED PAINTS MAY BE PRESENT ON COMPONENTS TO BE DISTURBED IN THOSE AREAS. PERSONNEL PERFORMING WORK IN THESE AREAS MUST COMPLY WITH THE REQUIREMENTS OF 40 CFR 745. INCLUDING TRAINING. WORK PRACTICES AND CLEANING OF THE WORK AREA. REFER TO SPECIFICATION DIVISIONS 0, 1 AND 2 FOR SPECIFIC INFORMATION CONCERNING DISTURBING. REMOVING AND DISPOSING OF LEAD MATERIALS AND THE INSTALLATION OF NEW MATERIALS OR COMPONENTS. THIS NOTIFICATION IS PROVIDED IN ACCORDANCE WITH EPA AND OSHA REQUIREMENTS.

PROJECT TEAM

ARCHITECTURAL: MCG EXPLORE DESIGN, JOHN WEIR, 907-563-8474

HAZARDS ABATEMENT: HTRW LLC, CHRIS OTTOSEN, 907-917-3801

STRUCTURAL:

MECHANICAL: RSA ENGINEERING, INC, MATT MALECHA, 907-276-0521

ELECTRICAL: RSA ENGINEERING, INC, FRANK SILBERER, 907-276-0521

PRICING

SUBMITTAL

FOR:

COVER SHEET



421 W. 1st Avenue, Suite 300 Anchorage, Alaska 99501 907.563.8474 > exploredesign.com

DEVISE ENGINEERING, JESSE GOBELI, 907-382-4471

SHEET NO.


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SUBMITTAL PRICING


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STANDARD ABBREVIATIONS






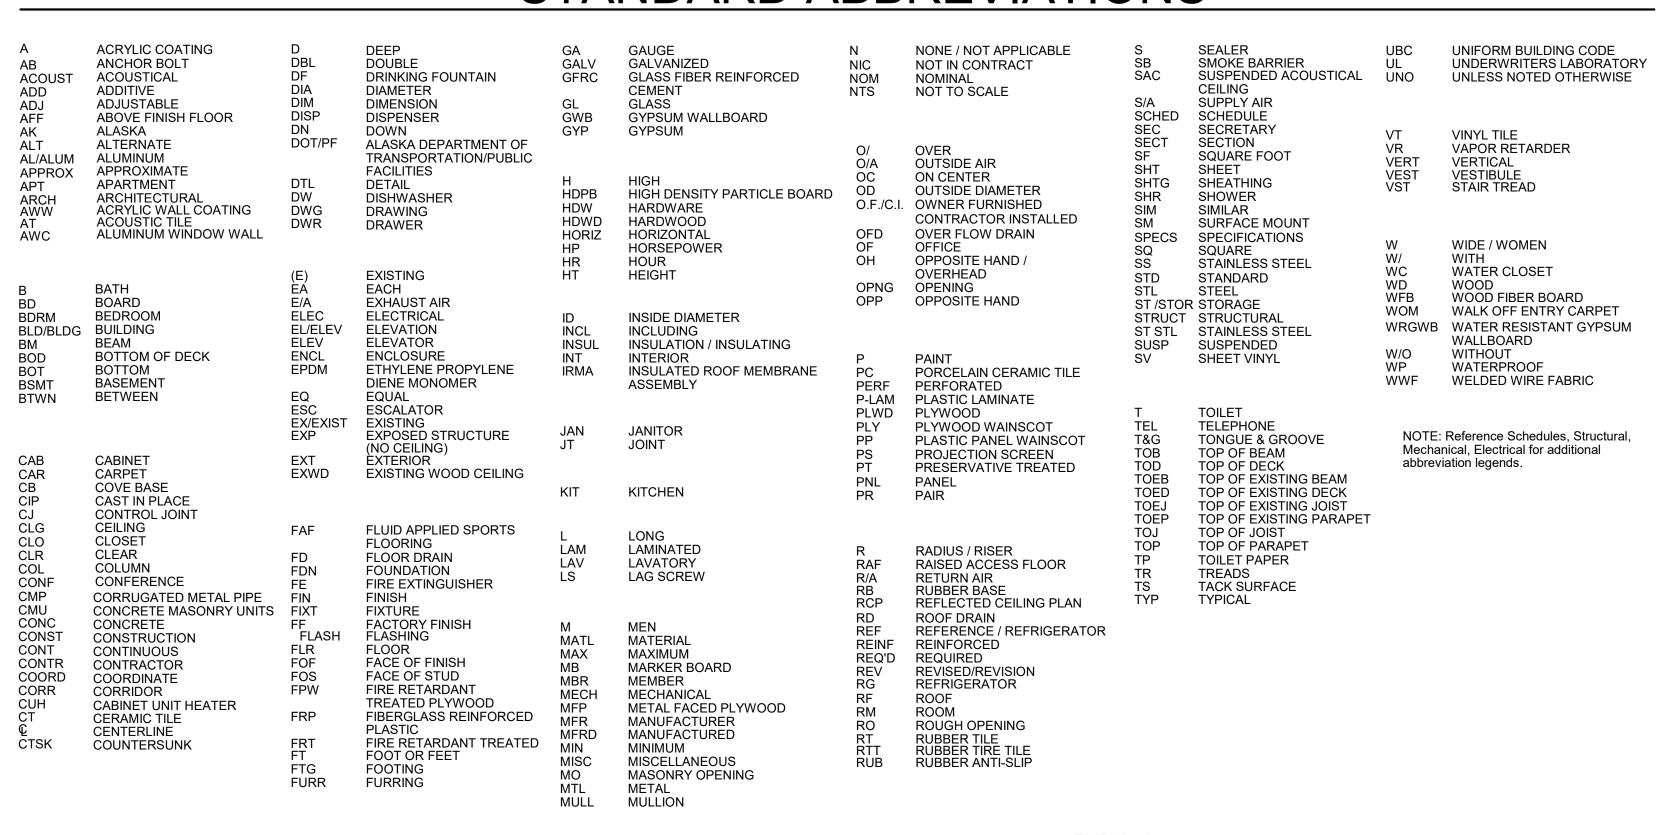



DETAIL SYMBOL

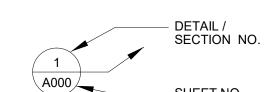WALL SECTION SYMBOL



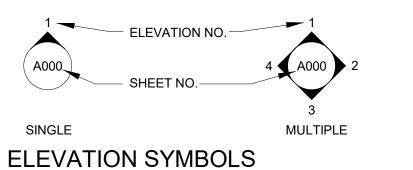


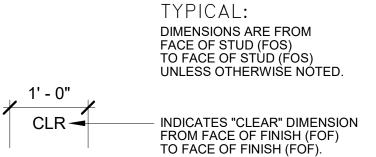

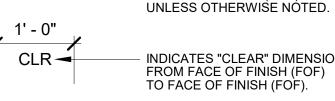





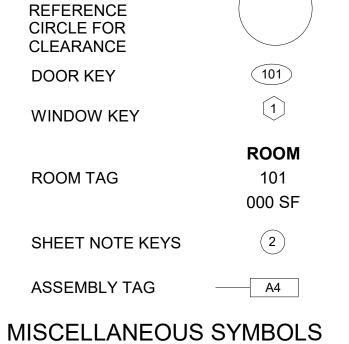

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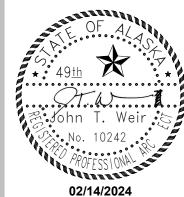
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VIDEO SYSTEM ONE-LINE DIAGRAM

VIDEO SYSTEM DETAILS VIDEO SYSTEM ZONE PLAN

ELECTRICAL REMODEL PLAN - FIRST FLOOR ADD ALT #1 VIDEO SYSTEM REMODEL PLAN

MCG EXPLORE **DESIGN** 421 West 1st Avenue, Suite 300 Anchorage, Alaska 99501 907.563.8474 | F 907.563.4572 exploredesign.com



ANCHORAGE SCHOOL DISTRICT

Spring Hill Elementary **School Roof** Replacement

9911 Lake Otis Pkwy,

Anchorage, AK 99507

100% BID DOCUMENTS

REVISIONS:

JOB NO.	2023017
DATE:	02/14/2024
PROJ. MGR.:	JTW
DRAWN BY:	DD
REVIEWED BY:	-

ABBREVIATIONS AND SHEET INDEX

SHEET NO.

G002


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ANCHORAGE SCHOOL DISTRICT

Spring Hill Elementary School Roof Replacement


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REVIEWED BY:	-
REVISIONS:	

ROOF SCHEDULE PLAN

SHEET NO.

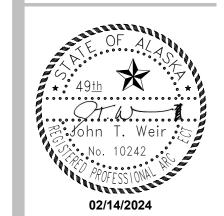

	ROOF SECTION SCHED	ULE																									
ROOF SECTION NAME	ROOF ABOVE ROOM NAMES / NUMBERS	YEAR REPLACED / BUILT	AREA SF (FLAT)	AREA SF (STRUCT SLOPE)	ROOF SYSTEM	X PLY/ MIL	COVER BOARD	STRUCTURE DECKING / FRAMING	INSULATION TYPE	OVER ALL R VALUE	STRUCT DECK SLOPE (PER FT)	STRUCT DECK YEAR	BASE BOARD	VAPOR RETARDER (MIL)	STRUCT DECKING / FRAMING	VAPOR RETARDER (MIL)	CEILING BOARD	WIND LOAD	ROOF ELEV = +/-	PARAPET ELEV = +/- (ROOF TOP TO P TOP)	PARAPET LENGTH (FEET)	ROOF CLERESTORY / LOUVER	ROOF DRAINS (TOTAL RD / ORD / SCUPPER)	DRAIN SIZE DIA (RD / RL-V / RL-H)	RAIN LEADER DOWN SPOUTS	ROOF TOP UTILITY	ROOF SECTION NAME
A	GYM 138, IMC 144, STAFF LOUNGE 156, NURSE 152, CR'S 162-172 (DOUBLE # ONLY), CORR 100-300, ENTRY 300A	2024	19,962	21,282	INSULATED METAL PANEL (SLOPED HOT ROOF)	-	-	1 1/2" METAL DECK	FIBERGLASS BATT INSUL	>40	2:12	1985	5/8" DENS DECK	-	STEEL BEAM FRAMING	20	SUSPENDED GYPSUM BOARD CEILING	100	13'-2" ~ 29-8"	-	-	6_INSUL ALUMN CS / 4_LOUVERS	-	-	-	2_ ANTENNAS	Α
С	OUTDOOR MECHANICAL AREA	2014	1,473	1,577	EPDM - REINFORCED - FULLY ADHERED	100	1/2" DENS DECK MECH ATTACHED	-	TAPERED RIGID INSULATION	-	1/2:12	2014	5/8" DENS DECK	10	1 1/2" METAL DECK	-	-	80	16'-9" ~ 17'-2"	6"	85	-	2/0/2	4" / 4" / 4"	1_4" RL, 30" HT, WITH HEAT TRACE	-	С
D	CORR 100-400, ENTRY 100A-400A, COMPUTER LAB 163, CR'S 163-171 (ODD # ONLY)	2024	6,417	6,382	INSULATED METAL PANEL (SLOPED HOT ROOF)	-	-	1 1/2" METAL DECK	FIBERGLASS BATT INSUL	>40	3:12	1985	-	-	STEEL BEAM FRAMING	20	SUSPENDED GYPSUM BOARD CEILING	100	25'-8" ~ 28-4"	-	-	-	-	-	-	1_ ANTENNA	D
E	CR'S 102-116 (DOUBLE # ONLY), CORR 400, ENTRY 400A	2024	8,735	8,730	INSULATED METAL PANEL (SLOPED HOT ROOF)	-	-	1 1/2" METAL DECK	FIBERGLASS BATT INSUL	>40	2:12	1985	-	-	STEEL BEAM FRAMING	20	SUSPENDED GYPSUM BOARD CEILING	100	14'-11" ~ 27-9"	-	-	6_INSUL ALUMN CS / 2_LOUVERS	-	-	-	-	E
F	CR'S 101-111 (ODD # ONLY), BOILER 117, GEI 127, ELEC 128, KITCHEN 129, MPR 130, STAG 132, BOOK/IT EQ/COM 133, ART 145, MAIN OF 148, CORR 100-300-400, ENTRY 100A-400A	= 2024	19,874	20,722	INSULATED METAL PANEL (SLOPED HOT ROOF)	-	-	1 1/2" METAL DECK	FIBERGLASS BATT INSUL	>40	3:12	1985	-	-	STEEL BEAM FRAMING	20	SUSPENDED GYPSUM BOARD CEILING	100	14'-5" ~ 33-11"	-	-	-	-	-	-	1_ ANTENNA	F

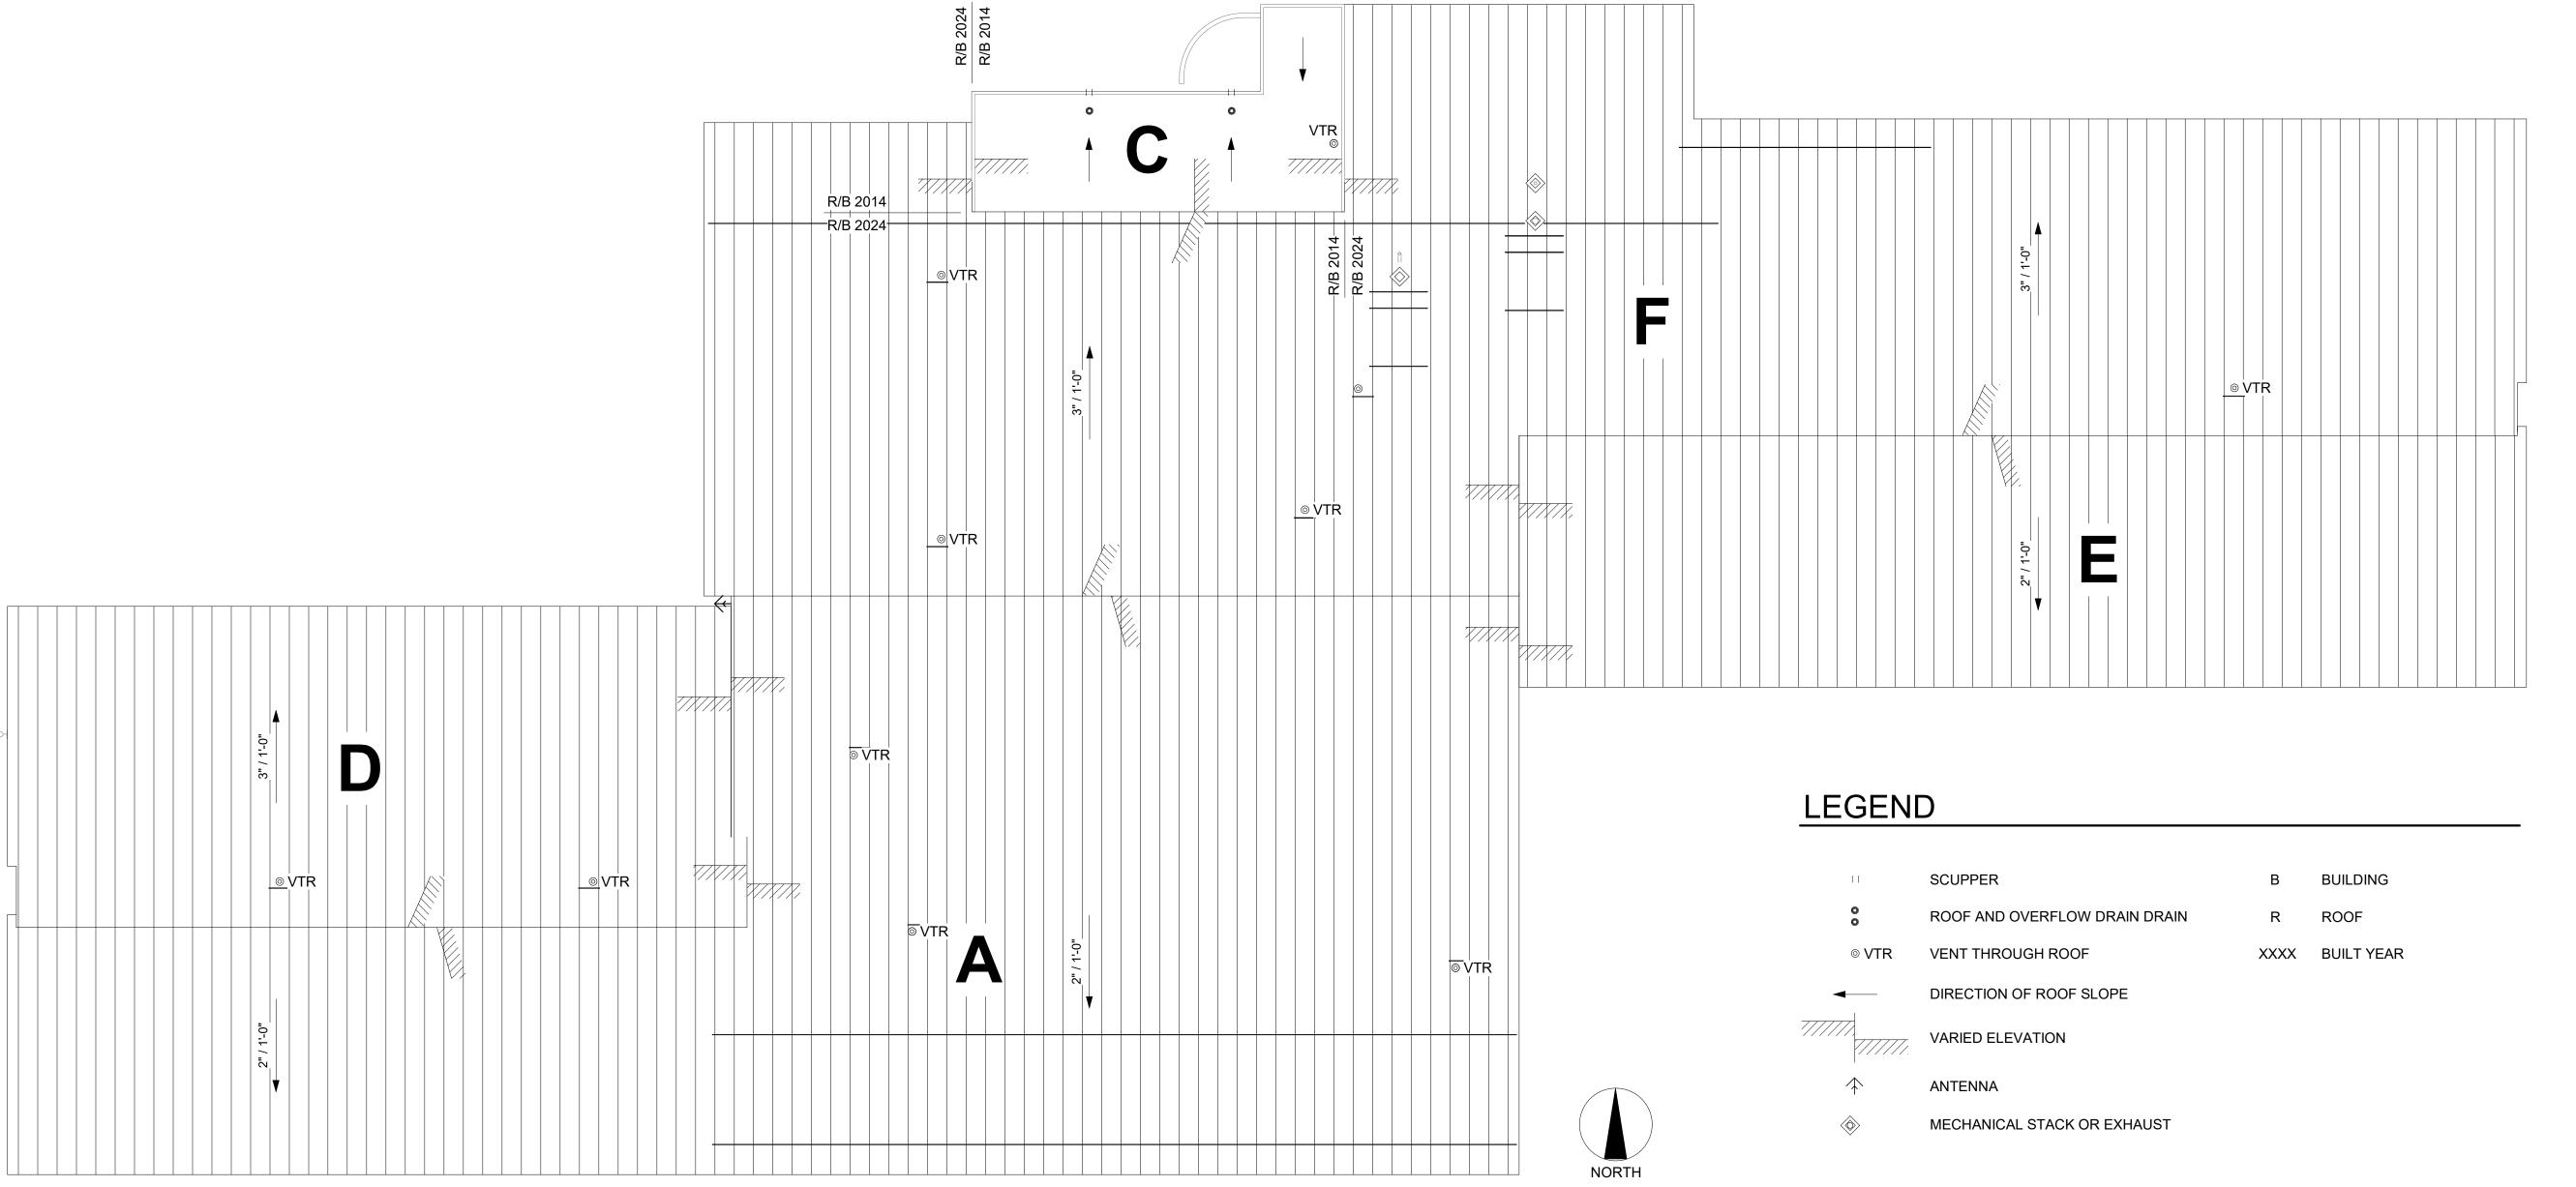GENERAL NOTES

- 1. THE WORK OF THE SPRING HILL ROOF REPLACEMENT PROJECT IS SCHEDULED TO DISTURB "COMMON HAZARDOUS BUILDING MATERIALS". "COMMON HAZARDOUS BUILDING MATERIALS" IS INTENDED TO INCLUDE ACM MATERIALS (ACM), LEAD-CONTAINING MATERIALS, MERCURY-CONTAINING MATERIALS, PCB-CONTAINING LIGHT BALLASTS, OZONE DEPLETING SUBSTANCES (ODS), HEAT TRANSFER FLUIDS, AND MATERIALS WITH RADIOACTIVE COMPONENTS. OTHER HEALTH, SAFETY, AND ENVIRONMENTAL HAZARDS MAY BE PRESENT AT THIS SITE AND ARE ADDRESSED ELSEWHERE IN THE CONTRACT DOCUMENTS. THE PRIMARY INTENT OF THE HAZARDS ABATEMENT PORTION OF THE WORK IS TO SATISFY THE HEALTH, SAFETY, AND ENVIRONMENTAL REQUIREMENTS OF AUTHORITIES HAVING JURISDICTION, HOWEVER, THE HAZARDS ABATEMENT DRAWINGS AND SPECIFICATIONS MAY INCLUDE MORE STRINGENT REQUIREMENTS.
- 2. THE HAZARDS ABATEMENT DRAWINGS ARE INTENDED TO PROVIDE INFORMATION ON WHICH "COMMON HAZARDOUS BUILDING MATERIALS" WILL BE DISTURBED, WHERE THOSE MATERIALS ARE LOCATED, AND THE ESTIMATED QUANTITIES OF THOSE MATERIALS TO BE REMOVED. THE EXACT EXTENT OF THE HAZARDS ABATEMENT PORTION OF THE WORK MAY VARY ON THE CONTRACTOR'S CHOICE OF MEANS AND METHODS TO COMPLETE THE WORK, HOWEVER, IF ADDITIONAL QUANTITIES OF MATERIALS REQUIRE REMOVAL DUE TO THE CONTRACTOR'S CHOICE OF MEANS AND METHODS, THAT WORK SHALL COME AT NO ADDITIONAL COST TO THE OWNER. THE CONTENT OF THE HAZARDS ABATEMENT DRAWINGS AND SPECIFICATIONS ARE INTENDED TO BE A BASELINE FOR BIDDING PURPOSES ONLY, AND IT IS THE CONTRACTOR'S RESPONSIBILITY TO CONDUCT ALL HAZARDS ABATEMENT WORK IN ACCORDANCE WITH THE CONTRACT DOCUMENTS AND LAWS OF THE AUTHORITY HAVING JURISDICTION.
- 3. ALL CONTRACTORS AND SUBCONTRACTORS WORKING AT THIS SITE MUST REVIEW THE HAZARDOUS MATERIALS ASSESSMENT AND HAZARDS ABATEMENT DRAWINGS AND SPECIFICATIONS TO FAMILIARIZE THEMSELVES WITH THE "COMMON HAZARDOUS BUILDING MATERIALS" PRESENT AT THE SITE AND HOW THOSE MATERIALS MAY AFFECT THEIR WORK. IT IS THE RESPONSIBILITY OF ALL TRADES TO COORDINATE THE WORK OF THIS PROJECT ACROSS ALL DISCIPLINES AND TO CONDUCT THEIR WORK WITHOUT DISTURBING THE VARIOUS "COMMON HAZARDOUS BUILDING MATERIALS" UNLESS THOSE PERSONNEL ARE QUALIFIED TO PERFORM SUCH WORK. IF ELEMENTS OF THE WORK CAN BE CONDUCTED WITHOUT DISTURBING THE VARIOUS "COMMON HAZARDOUS BUILDING MATERIALS", AND IF THAT WORK WOULD NOT RESULT IN ADDITIONAL COSTS TO THE OWNER TO AVOID THOSE "COMMON HAZARDOUS BUILDING MATERIALS", THEN THOSE MATERIALS MUST BE AVOIDED. DUE TO THE POTENTIAL TO CONTACT ACM THROUGHOUT THIS SITE, ALL PERSONNEL PERFORMING WORK AT THIS SITE ARE REQUIRED TO HAVE A MINIMUM OF "TWO-HOUR ASBESTOS AWARENESS" TRAINING IN ACCORDANCE WITH 29 CFR 1926.1101 AND 40 CFR 763. ONLY PERSONNEL WHO ARE TRAINED AND STATE-ACCREDITED AS AN EPA WORKER OR EPA CONTRACTOR/SUPERVISOR ARE PERMITTED TO DISTURB ACM.
- 4. THE HAZARDS ABATEMENT DRAWINGS DO NOT DEPICT NON-HAZARDOUS BUILDING MATERIALS-RELATED SCOPES OF WORK. THE LOCATIONS OF MATERIALS DEPICTED BY THE HAZARDS ABATEMENT DRAWINGS ARE SCHEMATIC REPRESENTATIONS ONLY, AND NOT ALL "COMMON HAZARDOUS BUILDING MATERIALS" ARE SHOWN BY THE HAZARDS ABATEMENT DRAWINGS. ALTHOUGH EVERY EFFORT WAS MADE TO IDENTIFY THE "COMMON HAZARDOUS BUILDING MATERIALS" IN THE PROJECT AREAS, SOME MATERIALS MAY NOT HAVE BEEN IDENTIFIED.
- 5. LEAD-CONTAINING MATERIALS ARE PRESENT THROUGHOUT THE SITE, INCLUDING ON ALL PAINTED SURFACES, GLAZED CERAMIC TILES OR FIXTURES, IN METALLIC FORM SUCH AS IN SOLDER, AND IN OTHER MISCELLANEOUS MATERIALS. THE LOCATIONS OF THESE MATERIALS ARE GENERALLY NOT SHOWN BY THE HAZARDS ABATEMENT DRAWINGS. DISTURBANCE OF LEAD-CONTAINING MATERIALS ARE SUBJECT TO REGULATION BY 29 CFR 1926.62, AND IT IS THE CONTRACTOR'S RESPONSIBILITY TO REVIEW THE "TRIGGER TASKS" AND OTHER REQUIREMENTS OF 29 CFR 1926.62 TO DETERMINE WHICH PORTIONS APPLY, IF ANY, TO EACH UNIQUE WORK TASK REQUIRED BY THIS PROJECT. SIMILARLY, ALL LEAD-CONTAINING WASTE STREAMS MUST BE TCLP TESTED IN ACCORDANCE WITH 40 CFR 261 TO DETERMINE DISPOSAL REQUIREMENTS. ALTERNATIVELY, THE CONTRACTOR MAY ELECT TO HAVE THEIR DESIGNATED PROFESSIONAL INDUSTRIAL HYGIENIST COLLECT BULK SAMPLES OF EACH AFFECTED PAINT TO DETERMINE IF "DETECTABLE LEVELS OF LEAD" ARE PRESENT IN THE PAINTS. ANY RESULTS WHICH INDICATE LEAD ABOVE THE LIMITS OF DETECTION MUST BE CONSIDERED AS HAVING "DETECTABLE LEVELS OF LEAD" AND THEREFORE SUBJECT TO BOTH THE MONITORING AND TESTING REQUIREMENTS OF THIS CONTRACT. THE MAXIMUM ALLOWABLE LIMIT OF DETECTION IS 60 PPM FOR THE PURPOSES OF DETERMINING IF "DETECTABLE LEVELS OF LEAD" ARE PRESENT.
- 6. DUSTS THROUGHOUT THE BUILDING ARE ASSUMED TO CONTAIN MEASURABLE CONCENTRATIONS OF VARIOUS REGULATED AIR CONTAMINANTS, SUCH AS THOSE FOUND IN 29 CFR 1910.1000, AND IT IS THE CONTRACTOR'S RESPONSIBILITY TO ASSESS EACH WORK AREA TO DETERMINE WHETHER ADDITIONAL WORKER OR SITE PROTECTION IS NEEDED TO ENSURE COMPLIANCE WITH THE REGULATIONS OF THE AUTHORITY HAVING JURISDICTION AND OTHER PERFORMANCE REQUIREMENTS OF THE CONTRACT.
- 7. ALL FINAL VISUAL INSPECTIONS AND MONITORING ARE TO BE PERFORMED BY THE INDEPENDENT INDUSTRIAL HYGIENE TECHNICIAN IN ACCORDANCE WITH THE SPECIFICATIONS.
- 8. THE CONTRACTOR'S PROFESSIONAL INDUSTRIAL HYGIENIST MUST PROVIDE ALL OTHER INSPECTIONS, TESTING, AND MONITORING-RELATED ELEMENTS OF THE WORK IN ACCORDANCE WITH THE SPECIFICATIONS.
- 9. WHERE ACM MATERIALS HAVE BEEN CONCEALED BY NEWER NON-ACM MATERIALS, AND WHERE THOSE NEWER MATERIALS ARE GLUED OR OTHERWISE SECURED TO THE UNDERLYING ACM MATERIALS IN A WAY WHICH RESULTS IN DISTURBANCE OF THOSE UNDERLYING ACM MATERIALS, THE REMOVAL OF THE NEWER MATERIALS MUST BE PERFORMED AS AN ASBESTOS ABATEMENT OPERATION USING THE SAME OR MORE STRINGENT WORK PRACTICES AS THE REMOVAL OF THE UNDERLYING ACM MATERIALS REQUIRES, AND THOSE NEWER MATERIALS MUST BE DISPOSED OF AS ASBESTOS-CONTAMINATED WASTE. EXAMPLES OF THIS TYPE OF CONDITION INCLUDE, BUT ARE NOT LIMITED TO, REMOVAL OF CARPET THAT HAS BEEN GLUED TO VINYL ASBESTOS TILE, ACM SHEET VINYL, OR ACM MASTICS; REMOVAL OF NON-ACM ACOUSTIC CEILING TILES ADHERED TO THE SUBSTRATE WITH ACM MASTICS; REMOVAL OF NON-ACM COVE BASE AND MASTICS WHICH WERE ADHERED TO AN ACM SUBSTRATE OR MATERIAL, ETC.
- 10. ALL MATERIALS MUST BE SAMPLED PRIOR TO DISTURBANCE UNLESS THOSE MATERIALS HAVE BEEN SHOWN NOT TO CONTAIN ASBESTOS. ALTERNATIVELY, THOSE MATERIALS MAY BE ASSUMED TO CONTAIN ASBESTOS. REFER TO SPECIFICATIONS FOR ADDITIONAL INFORMATION ON THE BULK SAMPLING REQUIREMENTS OF THIS PROJECT.
- 11. THE "COMMON HAZARDOUS BUILDING MATERIALS" AT THIS SITE ARE TYPICALLY IN GOOD CONDITION, HOWEVER, ISOLATED AREAS OF "WEAR AND TEAR" DAMAGE ARE ASSUMED TO BE SCATTERED THROUGHOUT THE SITE.

 ADDITIONALLY, IT IS ASSUMED THAT SOME DEBRIS FROM DAMAGED "COMMON HAZARDOUS BUILDING MATERIALS" MAY BE PRESENT ON TOP OF CEILINGS, ON ABOVE-CEILING COMPONENTS, IN CHASES, IN ENCLOSED OR OTHERWISE CONCEALED OR INACCESSIBLE AREAS, AND OTHER AREAS WHICH ARE NOT ROUTINELY CLEANED. THERE IS NO REQUIREMENT TO REMOVE ALL PRE-EXISTING ACM DUSTS OR DEBRIS FROM THE SITE UNLESS NOTED OTHERWISE AND ELSEWHERE ON THESE DRAWINGS OR IN THE CONTRACT DOCUMENTS, OR IF IT IS NECESSARY TO COMPLETE THE WORK IN ACCORDANCE WITH THE CONTRACT DOCUMENTS, OR BECAUSE THE ASBESTOS ABATEMENT CONTRACTOR.

ASBESTOS, LEAD AND OTHER POTENTIALLY HAZARDOUS MATERIALS ARE PRESENT IN THE BUILDING THAT MAY IMPACT THE WORK OF ALL TRADES. REGULATED AIR CONTAMINANTS, INCLUDING ASBESTOS AND LEAD, ARE ALSO PRESENT IN SETTLED AND CONCEALED DUST IN AND ON ARCHITECTURAL, STRUCTURAL, MECHANICAL AND ELECTRICAL COMPONENTS OR SYSTEMS THROUGHOUT THE BUILDING. ALL TRADES SHALL COORDINATE WITH OTHER TRADES AND CONDUCT THEIR WORK TO PREVENT WORKER EXPOSURE OR SITE CONTAMINATION. REFER TO SPECIFICATION DIVISIONS 0, 1 AND 2 FOR SPECIFIC INFORMATION CONCERNING DISTURBING, REMOVING AND DISPOSING OF THESE MATERIALS AND THE INSTALLATION OF NEW MATERIALS OR COMPONENTS. THIS NOTIFICATION IS PROVIDED IN ACCORDANCE WITH EPA AND OSHA REQUIREMENTS.

ESTIMATED QUANTITIES OF MATERIALS TO BE REMOVED	UNITS	MATERIAL DESCRIPTION
56,000	SF	STANDING SEAM METAL ROOFING WITH ACM GUMMY SEALANTS AT THE STANDING SEAMS AND ALL ASSOCIATED EDGE TRIMS, FLASHINGS, DRIP EDGES, ETC.
20	SFA	ASSUMED ACM ASPHALTIC ROOF TARS, SEALANTS, AND MASTICS FROM AFFECTED ROOFING AND APPURTENANCES AS NECESSARY TO ACCOMMODATE THE WORK
10	LFA	ASSUMED ACM SEALANTS ON THE KITCHEN EXHAUST HOOD DUCTWORK AS NECESSARY TO ACCOMMODATE THE WORK
500	LFA	ACM TAN AND GREY SEALANTS ON AFFECTED HVAC SYSTEMS AS NECESSARY TO ACCOMMODATE THE WORK
50	LFA	OFF-WHITE PUTTIES CONTAINNG <1% ASBESTOS ON HVAC SYSTEM DUCT FLANGES AS NECESSARY TO ACCOMMODATE THE WORK
1	EA	ACM FLANGE GASKET AT THE GENERATOR EXHAUST TO GENERATOR MUFFLER CONNECTION IF NECESSARY TO ACCOMMODATE THE WORK
650	SF	CLERESTORY WINDOWS WITH HARD BLACK WINDOW GASKET AND ASSOCIATED STICKY BLACK WINDOW GLAZING COMPOUNDS THAT BOTH CONTAIN <1% ASBESTOS
350	SFA	OUTSIDE AIR INTAKE AND RELIEF AIR DUCTS AND BIRD SCREENS WITH ACM HARD GREY DUCT SEAM SEALANTS
1	COST	TO COMPLETE A HAZMAT ASSESSMENT OF ROOF AREAS NOT ANTICIPATED TO CONTAIN ACM'S WHICH WERE NOT ACCESSIBLE FOR INSPECTION
200	SFA	ASSUMED ACM BLACK TARRY DAMPROOFING MATERIALS ON FOUNDATIONS WALLS AS NECESSARY TO ACCOMMODATE THE STRUCTURAL UPGRADES WORK
50	SF	EXTERIOR WINDOWS IN ART CLASSROOM WITH ASSUMED ACM WINDOW GLAZING COMPOUNDS
1	COST	TO SAMPLE TERRAZZO FLOORING WHICH IS ASSUMED TO NOT CONTAIN ASBESTOS FOR BIDDING PURPOSES THAT MUST BE SAMPLED PRIOR TO DISTURBANCE

ABBREVIATION	DESCRIPTION
ACM	ASBESTOS-CONTAINING MATERIAL
ADEC	ALASKA DEPARTMENT OF ENVIRONMENTAL CONSERVATION
AHAP	ASBESTOS HAZARD ABATEMENT PLAN
BUR	BUILT-UP ROOF
CF	CUBIC FEET
CFA	CUBIC FOOT ALLOWANCE
CFR	CODE OF FEDERAL REGULATIONS
CPIH	CONTRACTOR'S PROFESSIONAL INDUSTRIAL HYGIENIST
DOT	UNITED STATES DEPARTMENT OF TRANSPORTATION
EA	EACH
EAA	EACH ALLOWANCE
EPA	UNITED STATES ENVIRONMENTAL PROTECTION AGENCY
EPDM	ETHYLENE PROPYLENE DIENE MONOMER RUBBER
GWB	GYPSUM WALL BOARD
HEPA	HIGH EFFICIENCY PARTICULATE AIR
LCM	LEAD-CONTAINING MATERIAL
LF	LINEAR FEET
LFA	LINEAR FOOT ALLOWANCE
NESHAP	NATIONAL EMISSION STANDARDS FOR HAZARDOUS AIR POLLUTANTS
NRC	NUCLEAR REGULATORY COMMISSION
ODS	OZONE DEPLETING SUBSTANCE
OSHA	UNITED STATES OCCUPATIONAL SAFETY AND HEALTH ADMINISTRATION
PCB	POLYCHLORINATED BIPHENYL
PEL	PERMISSIBLE EXPOSURE LIMIT
PLM	POLARIZED LIGHT MICROSCOPY
PPE	PERSONAL PROTECTIVE EQUIPMENT
RACM	REGULATED ASBESTOS-CONTAINING MATERIAL
SF	SQUARE FEET
SFA	SQUARE FOOT ALLOWANCE
TCLP	TOXICITY CHARACTERISTIC LEACHING PROCEDURE
TEM	TRANSMISSION ELECTRON MICROSCOPY
UNO	UNLESS NOTED OTHERWISE
VAT	VINYL ASBESTOS TILE
XRF	X-RAY FLUORESCENCE

FOR:
OSUBMITTAL
OPRICING

PERMIT STAMP



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ANCHORAGE SCHOOL DISTRICT

Spring Hill Elementary School Roof Replacement

9911 Lake Otis Pkwy, Anchorage, AK 99507

100% PERMIT DOCUMENTS

JOB NO.	2024-05
DATE:	02/14/2024
PROJ. MGR.:	СТО
DRAWN BY:	СТО
REVIEWED BY:	сто
REVISIONS:	

HAZARDS ABATEMENT -GENERAL NOTES

SHEET NO.

H001

KEYNOTE REFERENCE	MATERIAL DESCRIPTION AND INSTRUCTION
H3	REMOVE AND DISPOSE OF ASSUMED ACM SEALANTS ON THE KITCHEN EXHAUST HOOD DUCTWORK AS NECESSARY TO ACCOMMODATE THE WORK.
H4	REMOVE AND DISPOSE OF ACM TAN AND GREY SEALANTS ON AFFECTED HVAC SYSTEMS AS NECESSARY TO ACCOMMODATE THE WORK.
H5	REMOVE AND DISPOSE OF OFF-WHITE PUTTIES CONTAINING <1% ASBESTOS ON HVAC SYSTEM DUCT FLANGES AS NECESSARY TO ACCOMMODATE THE WORK.
H6	REMOVE AND DISPOSE OF ACM FLANGE GASKET AT THE GENERATOR EXHAUST TO GENERATOR MUFFLER CONNECTION IF NECESSARY TO ACCOMMODATE THE WORK.
H7	REMOVE AND DISPOSE OF HARD BLACK WINDOW GASKET AND ASSOCIATED STICKY BLACK WINDOW GLAZING COMPOUNDS THAT BOTH CONTAIN <1% ASBESTOS AT CLERESTORY WINDOWS.
H8	REMOVE AND DISPOSE OF ACM HARD GREY DUCT SEAM SEALANTS ON THE OUTSIDE AIR INTAKE AND RELIEF AIR DUCTS AND BIRD SCREENS.
H10	REMOVE AND DISPOSE OF ASSUMED ACM BLACK TARRY DAMPPROOFING MATERIALS ON FOUNDATIONS WALLS AS NECESSARY TO ACCOMMODATE THE STRUCTURAL UPGRADES WORK.
H11	REMOVE AND DISPOSE OF EXTERIOR WINDOWS IN ART CLASSROOM WITH ASSUMED ACM WINDOW GLAZING COMPOUNDS.
H12	TERRAZZO FLOORING IS ASSUMED TO NOT CONTAIN ASBESTOS FOR BIDDING PURPOSES BUT MUST BE SAMPLED PRIOR TO DISTURBANCE. DO NOT COLLECT SAMPLES FROM UNAFFECTED AREAS OF TERRAZZO OR OTHERWISE DAMAGE ADJACENT TERRAZZO FLOORING TO REMAIN FOR THE PURPOSES OF SAMPLE COLLECTION.
	18 17 16 15 18 16 15 14

H4 H5 H8

WEST FAN

ROOM

254

HAZARDS ABATEMENT -

(20)

CLASSROOM

165

1ST CLASSROOM

166

HAZARDS ABATEMENT - OVERALL FIRST FLOOR PLAN

K-2ND

EXTENDED

RESOURCE

CLASSROOM

167

2ND CLASSROOM

168

WEST FAN ROOM

H100 / 1/16" = 1'-0"

(22)

1ST

CLASROOM

171

2ND CLASSROOM

172

H100 / 1/16" = 1'-0"

200A

K-3RD

RESOURCE

CLASSROOM

169

1ST

CLASSROOM

170

B

G

K

M

N

P

Q

R

S

ASBESTOS, LEAD AND OTHER POTENTIALLY HAZARDOUS MATERIALS ARE PRESENT IN THE BUILDING THAT MAY IMPACT THE WORK OF ALL TRADES. REGULATED AIR CONTAMINANTS, INCLUDING ASBESTOS AND LEAD, ARE ALSO PRESENT IN SETTLED AND CONCEALED DUST IN AND ON ARCHITECTURAL, STRUCTURAL, MECHANICAL AND ELECTRICAL COMPONENTS OR SYSTEMS THROUGHOUT THE BUILDING. ALL TRADES SHALL COORDINATE WITH OTHER TRADES AND CONDUCT THEIR WORK TO PREVENT WORKER EXPOSURE OR SITE CONTAMINATION. REFER TO SPECIFICATION DIVISIONS 0, 1 AND 2 FOR SPECIFIC INFORMATION CONCERNING DISTURBING, REMOVING AND DISPOSING OF THESE MATERIALS AND THE INSTALLATION OF NEW MATERIALS OR COMPONENTS. THIS NOTIFICATION IS PROVIDED IN ACCORDANCE WITH EPA AND OSHA REQUIREMENTS.

SERVICE

159

RECEIV.

GEN RM.

KITCHEN 129

BOOK RM / IT

COMM. ROOM

133

EQPT./

128

8

BOILER

ROOM 117

119

(AT ROOF LEVEL ABOVE) (H7)-

2ND-6TH EXTENDED

RESOURCE

CLASSROOM

2ND-6TH EXTENDED RESOURCE CLASSROOM

116

 (K)

6

CLASSROOM

111

CLASSROOM

112

CLASSROOM

109

4TH

CLASSROOM

110

(10) 9

EAST FAN

ROOM

233

H4 H5 H8 -4

HAZARDS ABATEMENT -

CORR

400

5

4TH

CLASSROOM

107

4TH-6TH

RESOURCE

CLASSROOM

108

4TH

CLASSROOM

105

3RD-6TH

BILINGUAL /

INDIAN ED

CLASSROOM

106

13

130

MUSIC

CLASSROOM

/ STAGE

132

GYMNASIUM

38

CONF.

144.2

LIBRARIAN

OFFICE

144.3

PTA / STOR.

144.1

7IT EQPT. 144.5

43 ENTRY

142

300B

IMC GROUP RM.

144.4

IMC 144

H4 H5

THESE KEYNOTES ARE TYPICAL THROUGHOUT THIS SHEET

STOR.

145C

145B

CLASSROOM

145

MAIN OFFICE

WORKRM.

153

SPEECH OFF

K CLASSROOM

162

155

SEC. STOR 148

MAIN ENTRY

PRINCIPAL

149

150

STAFF

LOUNGE

156

PSY OFF

157

(AT ROOF LEVEL ABOVE)

COMPUTER

LAB

163

174

OFF

173

K CLASSROOM

164

PERMIT STAMP

6TH

103

CLASSROOM

101

CLASSROOM

102

CLASSROOM

CLASSROOM

LEGEND (THIS SHEET ONLY)

INDICATE ITEMS TO REMAIN

NOTE, FADED LINEWORK AND GRAPHICS SHOWN IN PLAN

WORK

AREA OF TERRAZZO FLOORING SCHEDULED FOR DEMOLITION

ASSUMED ACM BLACK TARRY

FOUNDATIONS WALLS AS

DAMPPROOFING MATERIALS ON

NECESSARY TO ACCOMMODATE

THE STRUCTURAL UPGRADES

EXTERIOR WINDOWS IN ART

TO BE REMOVED

CLASSROOM WITH ASSUMED ACM WINDOW GLAZING COMPOUNDS

104

2




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OPRICING

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ANCHORAGE SCHOOL DISTRICT

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REVISIONS:	

HAZARDS ABATEMENT -OVERALL FIRST FLOOR PLAN

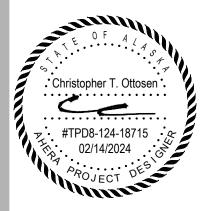SHEET NO. **H100**



H2 H3	SEALANTS FROM SUBSTRATES TO REMAIN. REMOVE AND DISPOSE OF ASSUMED ACM ASPHALTIC ROOF TARS, SEALANTS, AND MASTICS FROM AFFECTED ROOFING AND APPURTENANCES AS NECESSARY TO ACCOMMODATE THE WORK. REMOVE AND DISPOSE OF ASSUMED ACM SEALANTS ON THE KITCHEN EXHAUST HOOD DUCTWORK AS NECESSARY TO ACCOMMODATE THE WORK.	ROOF AREAS NOT ANTICIPATED TO CONTAIN ACM'S WHICH WERE NOT ACCESSIBLE FOR INSPECTION THAT MUST HAVE A HAZMAT ASSESSMENT PRIOR TO THE START OF WORK IN THOSE AREAS HARD BLACK WINDOW GASKET AND ASSOCIATED STICKY	STRUCTURAL, MECHANICAL AND ELECTRICAL COMPONENTS OR SYSTEMS THROUGHOUT THE BUILDING. ALL TRADES SHALL COORDINATE WITH OTHER TRADES AND CONDUCT THEIR WORK TO PREVENT WORKER EXPOSURE OR SITE CONTAMINATION. REFER TO SPECIFICATION DIVISIONS 0, 1 AND 2 FOR SPECIFIC INFORMATION CONCERNING DISTURBING, REMOVING AND DISPOSING OF THESE MATERIALS AND THE INSTALLATION OF NEW MATERIALS OR COMPONENTS. THIS NOTIFICATION IS PROVIDED IN ACCORDANCE WITH	
H4	REMOVE AND DISPOSE OF ACM TAN AND GREY SEALANTS ON AFFECTED HVAC SYSTEMS AS NECESSARY TO ACCOMMODATE THE WORK. REMOVE AND DISPOSE OF ACM FLANGE GASKET AT THE GENERATOR EXHAUST TO GENERATOR MUFFLER CONNECTION IF NECESSARY TO ACCOMMODATE THE WORK. REMOVE AND DISPOSE OF HARD BLACK WINDOW GASKET AND ASSOCIATED STICKY BLACK WINDOW GLAZING	BLACK WINDOW GLAZING COMPOUNDS THAT BOTH CONTAIN <1% ASBESTOS AT CLERESTORY WINDOWS TO BE REMOVED ACM HARD GREY DUCT SEAM SEALANTS ON THE OUTSIDE AIR AND RELIEF AIR INTAKE DUCTS AND BIRD SCREENS TO BE REMOVED	EPA AND OSHA REQUIREMENTS.	PERMIT STAMP
H7 H8 H9	COMPOUNDS THAT BOTH CONTAIN <1% ASBESTOS AT CLERESTORY WINDOWS. REMOVE AND DISPOSE OF ACM HARD GREY DUCT SEAM SEALANTS ON THE OUTSIDE AIR INTAKE AND RELIEF AIR DUCTS AND BIRD SCREENS. ROOF AREAS NOT ANTICIPATED TO CONTAIN ACM'S WHICH WERE NOT ACCESSIBLE FOR INSPECTION THAT MUST HAVE A HAZMAT ASSESSMENT PRIOR TO THE START OF WORK IN THOSE AREAS.	18 16 15 14	13 12 11 10 9 8 7 6 5 4 <td< th=""><th>3</th></td<>	3
			+ + + + + + + + + + + + + + + + + + +	
			+ + + + + + + + + + + + + + + + + + +	+ + + + + + + + + + + + + + + + + + +
_ (23)	22 21 20	19 + + + + + + + + + + + + + + + + + + +	+ + + + + + + + + + + + + + + + + + +	+ + + + + + + + + + + + + + + + + + +
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FOR:
O SUBMITTAL
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HAZARDS ABATEMENT -OVERALL ROOF PLAN

SHEET NO.
H101

TOS

TOW

TYP

UNO

VERT

VSC2

W/

W/C

W/O

WP

WSP

WWF

UT

TRANS

TOP OF STEEL

TOP OF WALL

TRANSVERSE

UNLESS NOTED OTHERWISE

VERCO SIDELAP CONNECTION

WOOD STRUCTURAL PANEL

WELDED WIRE FABRIC

WELDING PROCEDURE SPECIFICATION(S)

ULTRASONIC TESTING

WATER-TO-CEMENT

WORKING POINT

TYPICAL

VERTICAL

WITHOUT

NOTIFICATION OF POTENTIAL HAZARD ASBESTOS, LEAD AND OTHER POTENTIALLY HAZARDOUS MATERIALS ARE PRESENT IN THE BUILDING THAT MAY IMPACT THE WORK OF ALL TRADES. REGULATED AIR CONTAMINANTS, INCLUDING ASBESTOS AND LEAD, ARE ALSO PRESENT IN SETTLED AND CONCEALED DUST IN AND ON ARCHITECTURAL STRUCTURAL, MECHANICAL AND ELECTRICAL COMPONENTS OR SYSTEMS THROUGHOUT THE BUILDING. ALL TRADES SHALL COORDINATE WITH OTHER TRADES AND CONDUCT THEIR WORK TO PREVENT WORKER EXPOSURE OR SITE CONTAMINATION. REFER TO SPECIFICATION DIVISIONS 0, 1 AND 2 FOR SPECIFIC INFORMATION CONCERNING DISTURBING, REMOVING AND DISPOSING OF THESE MATERIALS AND THE INSTALLATION OF NEW MATERIALS OR COMPONENTS. THIS NOTIFICATION IS PROVIDED IN ACCORDANCE WITH EPA AND OSHA REQUIREMENTS.

MIN FOOTING DEPTH BELOW FINISHED GRADE:

UNHEATED ON NFS SOILS

HEATED

SYMBOLS

DETAIL CUT/CALLOUT

SECTION CUT

ELEVATION

KEYNOTE

IMAGE REFERENCE

3" MASONRY WALL, UNO

STEEL STUD WALL, UNO

WOOD STUD WALL, UNO

COLD-FORMED STEEL

SHEAR WALL SYMBOL

WOOD SHEAR WALL

WALL CONTROL JOINT

DIRECTION OF SLOPE

CHANGE IN ELEVATION

OR SLAB DEPRESSION

CIRCULAR OPENING IN

RECTANGULAR OPENING

BRACED FRAME MEMBER

TOP OF STEEL ELEVATION

RELATIVE TO BOTTOM OF

INDICATES NUMBER OF

ROWS OF BOLTS AT

CONNECTION IF MORE

BEAM CAMBER SIZE

SPOT ELEVATION

CENTER LINE

DIAMETER

OPENING

THAN ONE ROW OF BOLTS

MECHANICAL EQUIPMENT

SPAN DIRECTION

REVISION SYMBOL

NUMBER OF HEADED

STUDS ON COMPOSITE

RIGID (MOMENT)

CONNECTION

BEAM SPLICE

IN BEAM WEB

STEEL BEAM

DECK ELEVATION

DROPPED BEAM

FLUSH BEAM

OCCURS

BEAM

SYMBOL

HOLDOWN

DETAIL NUMBER

S101 SHEET NUMBER

SECTION NUMBER

\$101 SHEET NUMBER

NUMBER

SHEET NUMBER

\$1019 SHEET NUMBER

SW

SW

HDU2

(15")

<-2 1/2">

(c=1/2")

—ELEVATION

✓ IMAGE NUMBER

NOTIFICATION OF CHILD OCCUPIED FACILITY PORTIONS OF THIS BUILDING ARE CLASSIFIED AS A CHILD OCCUPIED FACILITY IN ACCORDANCE WITH 40 CFR 745 AND LEAD-BASED PAINTS MAY BE PRESENT ON COMPONENTS TO BE DISTURBED IN THOSE AREAS. PERSONNEL PERFORMING WORK IN THESE AREAS MUST COMPLY WITH THE REQUIREMENTS OF 40 CFR 745, INCLUDING TRAINING, WORK PRACTICES AND CLEANING OF THE WORK AREA. REFER TO SPECIFICATION DIVISIONS 0, 1 AND 2 FOR SPECIFIC INFORMATION CONCERNING DISTURBING, REMOVING AND DISPOSING OF LEAD MATERIALS AND THE INSTALLATION OF NEW MATERIALS OR COMPONENTS. THIS NOTIFICATION IS PROVIDED IN ACCORDANCE WITH EPA AND OSHA REQUIREMENTS.

PERMIT STAMP

DESIGN CRITERIA DESIGN CODES AND STANDARDS IBC-18: INTERNATIONAL BUILDING CODE, WITH LOCAL AMENDMENTS ASCE/SEI 7-16: MINIMUM DESIGN LOADS FOR BUILDINGS AND OTHER STRUCTURES RISK CATEGORY **DESIGN DEAD LOADS** UNIFORM | CONCENTRATED LOCATION REMARKS PSF LBS ROOFS, UNO 20 ---**DESIGN LIVE LOADS** UNIFORM CONCENTRATED LOCATION REMARKS PSF LBS ROOFS, UNO 20** ---**SNOW LOADS GOVERN **DESIGN SNOW LOADS** GROUND SNOW LOAD, Pg SNOW IMPORTANCE FACTOR, IS SNOW EXPOSURE FACTOR, Ce SNOW THERMAL FACTOR, Ct (WARM SNOW THERMAL FACTOR. Ct (COLD) 40 PSF FLAT-ROOF SNOW LOAD, Pf (WARM 12" MASONRY WALL, UNO 46.2 PSF FLAT-ROOF SNOW LOAD, Pf (COLD) **DESIGN WIND LOADS** 3" CONCRETE WALL, UNO ULTIMATE WIND SPEED, Vult 160 MPH NOMINAL WIND SPEED, Vasd 124 MPF WIND EXPOSURE INTERNAL PRESSURE COEFFICIENT (ENCLOSED) ±0.18 INTERNAL PRESSURE COEFFICIENT (PARTIALLY ENCLOSED) ±0.55 C&C EDGE AND CORNER DISTANCE, "a" PER PLANS PER PLANS **IC&C PRESSURES (ULTIMATE):** DESIGN SEISMIC LOADS SEISMIC IMPORTANCE FACTOR, le SITE CLASS MAPPED SPECTRAL RESPONSE, Ss / S1 1.50g / 0.68g DESIGN SPECTRAL RESPONSE, SDS / SD1 1.20g / 0.77g SEISMIC DESIGN CATEGORY SEISMIC FORCE RESISTING SYSTEM CONCENTRIC BRACED FRAMES ANALYSIS PROCEDURE **EQUIVALENT LATERAL FORCE** RESPONSE MODIFICATION COEFFICIENT, R SEISMIC RESPONSE COEFFICIENT, Cs 0.462 DESIGN BASE SHEAR (NOMINAL) EARTHWORK ALLOWABLE BEARING PRESSURE 1/3 INCREASE FOR SHORT-TERM LOADS

	MATERIALS & STRENGTH								
CONCRETE									
ITEMS	MIN COMP STRENGTH	MAX W/C RATIO	AIR ENTRAINMENT	SLUMP					
FOUNDATIONS	3,000 PSI	0.50	5%, ±1%	1 - 3 IN					
SLAB ON GRADE	4,000 PSI	0.45		1 - 4 IN					
STRUCTURAL STEEL				•					
ITEMS	ASTM	GRADE	MIN YIELD STRESS, Fy	REMARKS					
WIDE-FLANGE	A992		50 KSI						
SQUARE HSS	A500	С	50 KSI						
ANGLES	A36		36 KSI						
PLATES, UNO	A36		36 KSI						
BASE PLATES	A572		50 KSI						
THREADED RODS	A36		36 KSI						
HIGH STRENGTH BOLTS	A325								
WASHERS	F436								
NUTS	A563								
ANCHOR RODS	F1554	55							
NON-SHRINK GROUT									
ITEMS	MIN COMP STRENGTH		PRODUCT	SLUMP					
DRYPACK	5,000 PSI	FIVE STAR,	SIKA 212 OR EQUIVALENT						
REINFORCING STEEL									
ITEMS	ASTM	GRADE	MIN YIELD STRESS, Fy	REMARKS					
REBAR, #4 - #9	A615	60	60 KSI						

DEFERRED SUBMITTALS DEFERRED SUBMITTAL ITEMS SHALL BE REVIEWED BY THE EOR AND THEN SUBMITTED TO THE AUTHORITY HAVING JURISDICTION WITH A NOTATION INDICATING THAT THE DOCUMENTS HAVE BEEN REVIEWED BY THE EOR.

THE CONTRACTOR SHALL BE RESPONSIBLE FOR SUBMITTING CALCULATIONS AND DRAWINGS STAMPED BY A REGISTERED PROFESSIONAL ENGINEER IN THE STATE THE PROJECT IS LOCATED IN FOR THE FOLLOWING CONTRACTOR DESIGNED AND DETAILED ITEMS:

- SEISMIC RESTRAINT OF ARCHITECTURAL MECHANICAL & ELECTRICAL COMPONENTS
- ROOFING ATTACHMENT
- SNOW GUARD ATTACHMENT
- SHORING PLAN

42 IN

60 IN

REFER TO ARCHITECTURAL, MECHANICAL & ELECTRICAL FOR OTHER DEFERRED SUBMITTALS.

SUBMITTAL DOCUMENTS FOR DEFERRED SUBMITTAL ITEMS SHALL BE SUBMITTED TO THE AUTHORITY HAVING JURISDICTION AND EOR A MINIMUM OF 30 DAYS PRIOR TO FABRICATION. THE DOCUMENTS SHALL BE REVIEWED FOR GENERAL CONFORMANCE WITH THE DRAWINGS. THE DEFERRED SUBMITTAL ITEMS SHALL NOT BE INSTALLED UNTIL THEIR DESIGN AND SUBMITTAL DOCUMENTS HAVE BEEN APPROVED BY THE AUTHORITY HAVING JURISDICTION AND EOR.

SUBMITTAL PRICING

FOR:



MCG **EXPLORE DESIGN**

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ANCHORAGE SCHOOL DISTRICT

Spring Hill Elementary School Roof Replacement

9911 Lake Otis Pkwy,

95% BID DOCUMENTS

Anchorage, AK

REVISIONS:

24.010 JOB NO. 02/14/2024 DATE PROJ. MGR. MEH DRAWN BY: JG REVIEWED BY:

STRUCTURAL GENERAL INFORMATION

> SHEET NO. **S001**

ICC

ICF

IEBC

KSI

LBS

LONG

LRFD

LSL

LL

INCH

JOINT

POUNDS

LIVE LOAD

KIP (1000 POUNDS)

KIPS PER SQUARE INCH

LONG LEG HORIZONTAL

LAMINATED STRAND LUMBER

LONG LEG VERTICAL


LONGITUDINAL

INTERNATIONAL CODE COUNCIL

INTERNATIONAL EXISTING BUILDING

LOAD AND RESISTANCE FACTOR DESIGN

INSULATED CONCRETE FORM

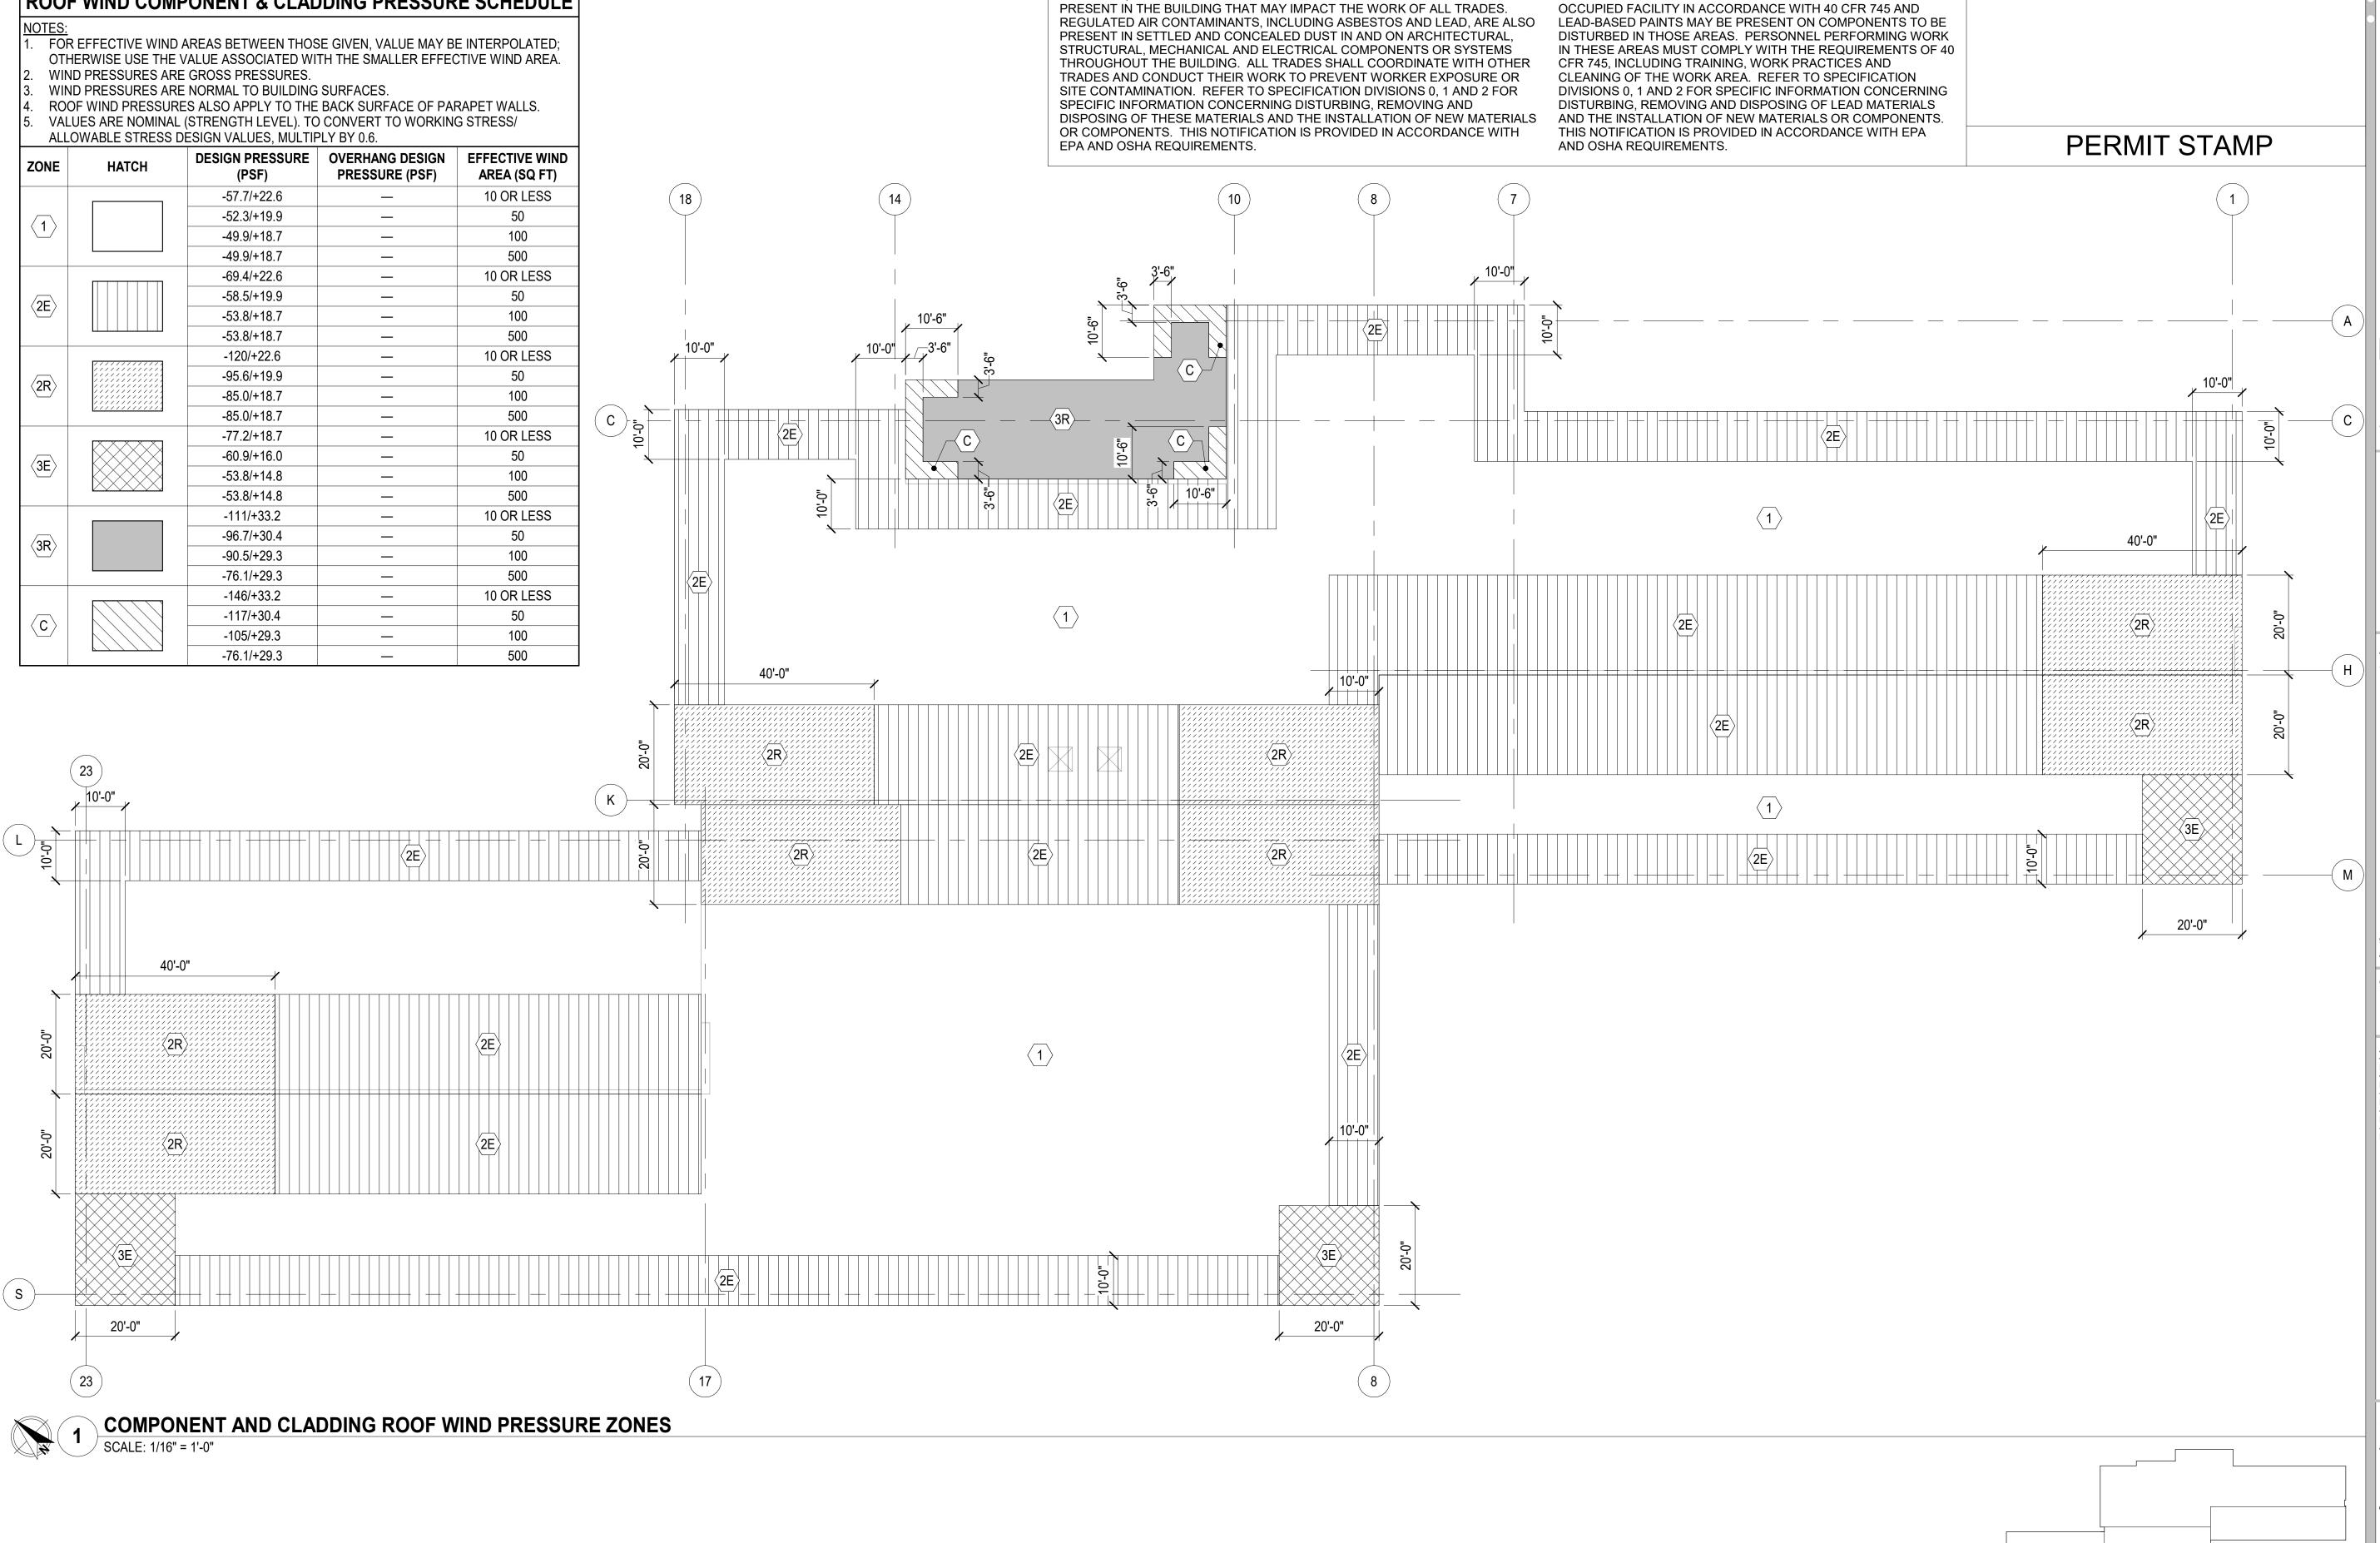

NOTIFICATION OF POTENTIAL HAZARD

ASBESTOS, LEAD AND OTHER POTENTIALLY HAZARDOUS MATERIALS ARE

NOTIFICATION OF CHILD OCCUPIED FACILITY

PORTIONS OF THIS BUILDING ARE CLASSIFIED AS A CHILD

SUBMITTAL PRICING

MCG EXPLORE DESIGN

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ANCHORAGE SCHOOL DISTRICT

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24.010	JOB NO.
02/14/2024	DATE:
JG	PROJ. MGR.:
MEH	DRAWN BY:
JG	REVIEWED BY:
	REVISIONS:

COMPONENT AND CLADDING ROOF WIND PRESSURE ZONES

> SHEET NO. **S002**

ROOF WIND COMPONENT & CLADDING PRESSURE SCHEDULE

KEY PLAN

GEOTECHNICAL SPECIAL INSPECTIONS				
SOILS				
SYSTEM OR MATERIAL	IBC CODE REF	CODE OR STANDARD REF	FREQUENCY	REMARKS
VERIFY MATERIALS BELOW SHALLOW FOUNDATIONS ARE ADEQUATE TO ACHIEVE DESIGN BEARING CAPACITY	1705.6	_	PERIODIC	_
VERIFY EXCAVATIONS ARE EXTENDED TO PROPER DEPTH AND HAVE REACHED PROPER MATERIAL	1705.6	_	PERIODIC	_
PERFORM CLASSIFICATION AND TESTING OF COMPACTED FILL MATERIALS	1705.6	_	PERIODIC	_
VERIFY USE OF PROPER MATERIALS, DENSITIES AND LIFT THICKNESSES DURING PLACEMENT AND COMPACTION OF	1705.6	_	CONTINUOUS	_
PRIOR TO PLACEMENT OF COMPACTED FILL, OBSERVE SUBGRADE AND VERIFY SITE HAS BEEN PROPERLY PREPARED	1705.6	_	PERIODIC	_

STRUCTURAL SPECIAL INSPECTIONS				
CONCRETE				
SYSTEM OR MATERIAL	IBC CODE REF	CODE OR STANDARD REF	FREQUENCY	REMARKS
GENERAL INSPECTIONS				
REINFORCING STEEL PLACEMENT	1705.3	ACI 318 20 ACI 318 25.2 ACI 318 25.3 ACI 318 26.6.1-3	PERIODIC	_
PLACEMENT OF CAST-IN-PLACE ANCHOR BOLTS	1705.3	ACI 318 17.8.2	PERIODIC	(NOTE 2)
VERIFY USE OF REQUIRED MIX DESIGN(S)	1705.3 1904.1 1904.2	ACI 318 19 ACI 318 26.4.3 ACI 318 26.4.4	PERIODIC	_
SAMPLING OF CONCRETE FOR STRENGTH, SLUMP, AIR CONTENT TESTS, AND TEMPERATURE DETERMINATION	1705.3	ASTM C172 ASTM C31 ACI 318 26.5 ACI 318 26.12	CONTINUOUS	REFER TO CONCRETE TESTING TABLES
CONCRETE PLACEMENT	1705.3	ACI 318 26.5	CONTINUOUS	_
CONCRETE CURING	1705.3	ACI 318 26.5.3-5	PERIODIC	_
ERECTION OF PRECAST CONCRETE MEMBERS	1705.3	ACI 318 26.9	PERIODIC	(NOTE 3)
VERIFICATION OF FORMWORK	1705.3	ACI 318 26.11.1.2(b)	PERIODIC	(NOTE 4)

STRUCTURAL SP	ECIAL IN	SPECTIONS		
STRUCTURAL STEEL - FABRICATED SYSTEMS AND ELEMENTS				
SYSTEM OR MATERIAL	IBC CODE REF	CODE OR STANDARD REF	FREQUENCY	REMARKS
FABRICATED SYSTEMS AND ELEMENTS	1704.2.5	AISC 360 N6	PERIODIC	(NOTES 1 & 2)

SPECIAL INSPECTIONS APPLY TO SHAPE, LOCATION AND DIMENSIONS OF THE CONCRETE MEMBER BEING FORMED.

REFER TO STRUCTURAL STEEL STRUCTURAL SPECIAL INSPECTION TABLE.

ALL CONNECTIONS VISUALLY INSPECTED, REFER TO ANCHOR BOLT AND WELDING REQUIREMENTS.

ALL ANCHOR BOLTS ARE VISUALLY INSPECTED.

SPECIAL INSPECTIONS APPLY TO VERIFICATION OF DETAILED FABRICATION AND QUALITY CONTROL PROCEDURES, INCLUDING REVIEW FOR COMPLETENESS AND ADEQUACY RELATIVE TO THE CODE REQUIREMENTS. SPECIAL INSPECTIONS ARE NOT REQUIRED FOR WORK DONE ON THE PREMISES OF A FABRICATOR REGISTERED AND APPROVED TO PERFORM SAID WORK WITHOUT SPECIAL INSPECTION. APPROVED FABRICATOR'S, UPON COMPLETION OF COMPONENT MANUFACTURING, SHALL SUBMIT A CERTIFICATE OF COMPLIANCE TO OWNER OR OWNER'S AUTHORIZED AGENT FOR SUBMITTAL TO THE BUILDING OFFICIAL STATING THAT THE WORK WAS PERFORMED IN ACCORDANCE WITH THE APPROVED CONSTRUCTION DOCUMENTS.

1705.10

NON-DESTRUCTIVE TESTING REQUIREMENTS FOR WELDS CANNOT BE WAIVED PER AISC 360 SECTION N6. NDT OF WELDS COMPLETED IN AN APPROVED FABRICATOR'S SHOP IS PERMITTED TO BE PERFORMED BY THAT FABRICATOR WHEN APPROVED BY THE AUTHORITY HAVING JURISDICATION. WHEN THE FABRICATOR PERFORMS THE NDT, THE QA AGENCY SHALL REVIEW THE FABRICATOR'S NDT REPORTS.

ASBESTOS, LEAD AND OTHER POTENTIALLY HAZARDOUS MATERIALS ARE PRESENT IN THE BUILDING THAT MAY IMPACT THE WORK OF ALL TRADES. REGULATED AIR CONTAMINANTS, INCLUDING ASBESTOS AND LEAD, ARE ALSO PRESENT IN SETTLED AND CONCEALED DUST IN AND ON ARCHITECTURAL, STRUCTURAL, MECHANICAL AND ELECTRICAL COMPONENTS OR SYSTEMS TRADES AND CONDUCT THEIR WORK TO PREVENT WORKER EXPOSURE OR

THROUGHOUT THE BUILDING. ALL TRADES SHALL COORDINATE WITH OTHER SITE CONTAMINATION. REFER TO SPECIFICATION DIVISIONS 0, 1 AND 2 FOR SPECIFIC INFORMATION CONCERNING DISTURBING, REMOVING AND DISPOSING OF THESE MATERIALS AND THE INSTALLATION OF NEW MATERIALS OR COMPONENTS. THIS NOTIFICATION IS PROVIDED IN ACCORDANCE WITH EPA AND OSHA REQUIREMENTS.

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PERMIT STAMP

STRUCTURAL SPECIAL INSPECTIONS				
STRUCTURAL STEEL - AVAILABLE DOCUMENTS FOR STEEL CONSTRUCTION				
SYSTEM OR MATERIAL	IBC CODE REF	CODE OR STANDARD REF	FREQUENCY	REMARKS
MATERIAL VERIFICATION OF STRUCTURAL STEEL	1705.2.1	ASTM A6 AISC 360 A3.1, N3.2	PERIODIC	CERTIFIED MILL TEST REPORTS
MATERIAL VERIFICATION OF FASTENERS	1705.2.1	AISC 360 A3.3, N3.2	PERIODIC	(NOTE 1)
MATERIAL VERIFICATION OF ANCHOR RODS AND THREADED RODS	1705.2.1	AISC 360 A3.4, N3.2	PERIODIC	(NOTE 1)
MATERIAL VERIFICATION OF WELDING CONSUMABLES	1705.2.1	AISC 360 A3.5, N3.2, N5.4	PERIODIC	(NOTE 1)
MATERIAL VERIFICATION OF WELDING FILLER METALS AND FLUXES	1705.2.1	AISC 360 N3.2	PERIODIC	(NOTE 2)
WELDING PROCEDURE SPECIFICATIONS (WPSs)	1705.2.1	AISC 360 N3.2	PERIODIC	_
PROCEDURE QUALIFICATION RECORDS (PQRs)	1705.2.1	AISC 360 N3.2	PERIODIC	_
WELDING PERSONNEL PERFORMANCE QUALIFICATION RECORDS	1705.2.1	AISC 360 N3.2	PERIODIC	_
FABRICATOR'S OR ERECTOR'S WRITTEN QC MANUAL	1705.2.1	AISC 360 N3.2	PERIODIC	AS APPLICABLE
FABRICATOR'S OR ERECTOR'S QCI QUALIFICATIONS	1705.2.1	AISC 360 N3.2	PERIODIC	AS APPLICABLE
FABRICATOR NDT PERSONNEL QUALIFICATIONS	1705.2.1	AISC 360 N3.2	PERIODIC	(NOTE 3)

NOTIFICATION OF POTENTIAL HAZARD

MANUFACTURER'S TEST REPORTS.

- 2. MANUFACTURER'S PRODUCT DATA SHEETS OR CATALOG DATA.

3. IF NDT IS PERFORMED BY THE FABRICATOR.				
STRUCTURAL STEEL - GENERAL INSPECTIONS				
INSPECTION TASKS	IBC CODE REF	CODE OR STANDARD REF	FREQUENCY (NOTE 1)	REMARKS
INSPECTION OF GALVANIZED STRUCTURAL STEEL MAIN MEMBERS	1705.2.1	AISC 360 N5.7	OBSERVE	(NOTE 2)
VERIFICATION OF THE FABRICATED STEEL OR ERECTED STEEL FRAME INCLUDING BRACES, STIFFENERS, MEMBER LOCATIONS AND THE CORRECT APPLICATION OF JOINT DETAILS AT EACH	1705.2.1	AISC 360 N5.8	OBSERVE	(NOTE 3)
PLACEMENT OF ANCHOR RODS AND OTHER EMBEDMENTS SUPPORTING STRUCTURAL STEEL FOR COMPLIANCE WITH THE	1705.2.1	AISC 360 N5.8	OBSERVE	(NOTE 4)

"OBSERVE": THE INSPECTOR SHALL OBSERVE THESE ITEMS ON A RANDOM BASIS. OPERATIONS NEED NOT BE DELAYED PENDING THESE INSPECTIONS. "PERFORM": THESE TASKS SHALL BE PERFORMED FOR EACH WELDED JOINT OR MEMBER.

CRACKS SHALL BE REPAIRED OR THE MEMBER SHALL BE REJECTED.

ACCEPTANCE OR REJECTION OF JOINT DETAILS AND THE CORRECT APPLICATION OF JOINT DETAILS SHALL BE DOCUMENTED.

AT MINIMUM, THE DIAMETER, GRADE, TYPE AND LENGTH OF THE ANCHOR ROD OR EMBEDDED ITEM AND THE EXTENT OR DEPTH OF EMBEDMENT INTO THE CONCRETE, SHALL BE VERIFIED PRIOR TO PLACEMENT OF CONCRETE.

STRUCTURAL SPECIAL INSPECTIONS				
HIGH STRENGTH BOLTING - JOINTS				
SYSTEM OR MATERIAL	IBC CODE REF	CODE OR STANDARD REF	FREQUENCY	REMARKS
SNUG-TIGHT JOINTS				
INSTALLATION	1705.2.1	AISC 360 N5.6	PERIODIC	(NOTE 1)
PRETENSIONED AND SLIP-CRITICAL JOINTS				
INSTALLATION USING TURN-OF-THE-NUT METHOD WITH MATCH MARKING, DIRECT TENSION INDICATOR METHOD OR TWIST-OFF	1705.2.1	AISC 360 N5.6	PERIODIC	(NOTE 2)
INSTALLATION USING TURN-OF-THE-NUT METHOD WITHOUT MATC	1705.2.1	AISC 360 N5.6	CONTINUOUS	(NOTE 1)
NOTES:				

VISUALLY INSPECT ALL CONNECTIONS INSPECTION NEED NOT OCCUR DURING INSTALLATION OF FASTENERS.

2. VISUALLY INSPECT ALL CONNECTIONS. CONNECTIONS USING DIRECT TENSION INDICATORS: ALL BOLTS SHALL BE INSPECTED AFTER

HIGH STRENGTH BOLTING				
NSPECTION TASKS	IBC CODE REF	CODE OR STANDARD REF	FREQUENCY (NOTE 1)	REMARKS
NSPECTION TASKS PRIOR TO BOLTING			1	
MANUFACTURER'S CERTIFICATIONS AVAILABLE FOR FASTENER MATERIALS	1705.2.1	AISC 360 N5.6-1	PERFORM	_
FASTENERS MARKED IN ACCORDANCE WITH ASTM REQUIREMENTS	1705.2.1	AISC 360 N5.6-1	OBSERVE	_
CORRECT FASTENERS SELECTED FOR THE JOINT DETAIL (GRADE, TYPE, BOLT LENGTH IF THREADS ARE TO BE EXCLUDED FROM SHEAR PLANE)	1705.2.1	AISC 360 N5.6-1	OBSERVE	_
CORRECT BOLTING PROCEDURE SELECTED FOR JOINT DETAIL	1705.2.1	AISC 360 N5.6-1	OBSERVE	_
CONNECTING ELEMENTS, INCLUDING THE APPROPRIATE FAYING SURFACE CONDITION AND HOLE PREPARATION, IF SPECIFIED, MEET APPLICABLE REQUIREMENTS	1705.2.1	AISC 360 N5.6-1	OBSERVE	_
PRE-INSTALLATION VERIFICATION TESTING BY INSTALLATION PERSONNEL OBSERVED AND DOCUMENTED FOR FASTENER ASSEMBLIES AND METHODS USED	1705.2.1	AISC 360 N5.6-1	OBSERVE	(NOTE 2)
PROTECTED STORAGE PROVIDED FOR BOLTS, NUTS, WASHERS AND OTHER FASTENER COMPONENTS	1705.2.1	AISC 360 N5.6-1	OBSERVE	_
NSPECTION TASKS DURING BOLTING			1	
FASTENER ASSEMBLIES PLACED IN ALL HOLES AND WASHERS AND NUTS ARE POSITIONED AS REQUIRED	1705.2.1	AISC 360 N5.6-2	OBSERVE	_
JOINT BROUGHT TO THE SNUG-TIGHT CONDITION PRIOR TO THE PRETENSIONING OPERATION	1705.2.1	AISC 360 N5.6-2	OBSERVE	_
FASTENER COMPONENT NOT TURNED BY THE WRENCH PREVENTED FROM ROTATING	1705.2.1	AISC 360 N5.6-2	OBSERVE	_
FASTENERS ARE PRETENSIONED IN ACCORDANCE WITH THE RCSC SPECIFICATION, PROGRESSING SYSTEMATICALLY FROM THE MOST RIGID POINT TOWARD THE FREE EDGES	1705.2.1	AISC 360 N5.6-2	OBSERVE	_
NSPECTION TASKS AFTER BOLTING				
DOCUMENT ACCEPTANCE OR REJECTION OF BOLTED CONNECTIONS	1705.2.1	AISC 360 N5.6-3	PERFORM	_

"OBSERVE": THE INSPECTOR SHALL OBSERVE THESE ITEMS ON A RANDOM BASIS. OPERATIONS NEED NOT BE DELAYED PENDING THESE INSPECTIONS. "PERFORM": THESE TASKS SHALL BE PERFORMED FOR EACH WELDED JOINT OR MEMBER. REFER TO STEEL TESTING TABLES.

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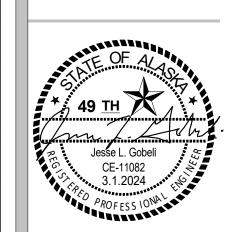
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ANCHORAGE SCHOOL DISTRICT

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SPECIAL INSPECTIONS

SHEET NO.

STRUCTURAL SPECIAL INSPECTIONS				
STRUCTURAL STEEL - WELDING		I		
INSPECTION TASKS	IBC CODE REF	CODE OR STANDARD REF	FREQUENCY (NOTE 1)	REMARKS
INSPECTION TASKS PRIOR TO WELDING WELDER QUALIFICATION RECORDS AND CONTINUITY RECORDS	1705.2.1	AISC 360 N5.4-1	OBSERVE	
WELDING PROCEDURE SPECIFICATIONS	1705.2.1	AISC 360 N5.4-1	PERFORM	<u> </u>
MANUFACTURER CERTIFICATIONS FOR WELDING CONSUMABLES	1705.2.1	AISC 360 N5.4-1	PERFORM	_
MATERIAL IDENTIFICATION (TYPE/GRADE)	1705.2.1	AISC 360 N5.4-1	OBSERVE	_
WELDER IDENTIFICATION SYSTEM	1705.2.1	AISC 360 N5.4-1	OBSERVE	(NOTE 2)
FIT-UP OF GROOVE WELDS (INCLUDING JOINT GEOMETRY)	4705.0.4	AISC 360 N5.4-1	ODCEDVE	
A. JOINT PREPARATIONB. DIMENSIONS (ALIGNMENT, ROOT OPENING, ROOT FACE, BEVEL)	1705.2.1	AISC 360 N5.4-1	OBSERVE	_
B. DIMENSIONS (ALIGNMENT, ROOT OF ENING, ROOT FACE, BEVEL)	1705.2.1	AISC 360 N5.4-1	OBSERVE	_
C. CLEANLINESS (CONDITION OF SURFACES)	1705.2.1	AISC 360 N5.4-1	OBSERVE	_
D. TACK WELD QUALITY AND LOCATION	1705.2.1	AISC 360 N5.4-1	OBSERVE	_
E. BACKING TYPE AND FIT (IF APPLICABLE)	1705.2.1	AISC 360 N5.4-1	OBSERVE	-
FIT-UP OF CJP GROOVE WELDS OF HSS T-, Y- AND K-JOINTS WITHOUT	•		, , , , , , , , , , , , , , , , , , ,	
A. JOINT PREPARATION	1705.2.1	AISC 360 N5.4-1	OBSERVE	
B. DIMENSIONS (ALIGNMENT, ROOT OPENING, ROOT FACE, BEVEL)	1705.2.1	AISC 360 N5.4-1	OBSERVE	_
C. CLEANLINESS (CONDITION OF SURFACES)	1705.2.1	AISC 360 N5.4-1	OBSERVE	
D. TACK WELD QUALITY AND LOCATION	1705.2.1	AISC 360 N5.4-1	OBSERVE	_
E. BACKING TYPE AND FIT (IF APPLICABLE)	1705.2.1	AISC 360 N5.4-1	OBSERVE	_
CONFIGURATION AND FINISH OF ACCESS HOLES	1705.2.1	AISC 360 N5.4-1	OBSERVE	_
FIT UP OF FILLET WELDS	4705.0.4	A100 000 NE 1 1	ODOED\/E	
A. DIMENSIONS (ALIGNMENT, GAPS AT ROOT)	1705.2.1	AISC 360 N5.4-1	OBSERVE	_
B. CLEANLINESS (CONDITION OF STEEL SURFACES)	1705.2.1 1705.2.1	AISC 360 N5.4-1 AISC 360 N5.4-1	OBSERVE OBSERVE	<u> </u>
C. TACK WELD QUALITY AND LOCATION INSPECTION TASKS DURING WELDING	1703.2.1	AISC 300 N3.4-1	ODSERVE	<u>—</u>
CONTROL AND HANDLING OF WELDING CONSUMABLES				
A. PACKAGING	1705.2.1	AISC 360 N5.4-2	OBSERVE	_
B. EXPOSURE CONTROL	1705.2.1	AISC 360 N5.4-2	OBSERVE	_
NO WELDING OVER CRACKED TACK WELDS ENVIRONMENTAL CONDITIONS	1705.2.1	AISC 360 N5.4-2	OBSERVE	_
A. WIND SPEED WITHIN LIMITS	1705.2.1	AISC 360 N5.4-2	OBSERVE	_
B. PRECIPITATION AND TEMPERATURE	1705.2.1	AISC 360 N5.4-2	OBSERVE	_
WPS FOLLOWED				
A. SETTINGS ON WELDING EQUIPMENT	1705.2.1	AISC 360 N5.4-2	OBSERVE	
B. TRAVEL SPEED	1705.2.1	AISC 360 N5.4-2	OBSERVE	_
C. SELECTED WELDING MATERIALS	1705.2.1	AISC 360 N5.4-2	OBSERVE	_
D. SHIELDING GAS TYPE/FLOW RATE E. PREHEAT APPLIED	1705.2.1 1705.2.1	AISC 360 N5.4-2 AISC 360 N5.4-2	OBSERVE OBSERVE	
F. INTERPASS TEMPERATURE MAINTAINED (MIN/MAX)	1705.2.1	AISC 360 N5.4-2	OBSERVE	<u>_</u>
G. PROPER POSITION (F, V, H, OH)	1705.2.1	AISC 360 N5.4-2	OBSERVE	
WELDING TECHNIQUES		7 5 5 5 5 5 1 1 5 1 5	02022	
A. INTERPASS AND FINAL CLEANING	1705.2.1	AISC 360 N5.4-2	OBSERVE	_
B. EACH PASS WITHIN PROFILE LIMITATIONS	1705.2.1	AISC 360 N5.4-2	OBSERVE	_
C. EACH PASS MEETS QUALITY REQUIREMENTS	1705.2.1	AISC 360 N5.4-2	OBSERVE	<u> </u>
PLACEMENT AND INSTALLATION OF STEEL HEADED STUD ANCHORS	1705.2.1	AISC 360 N5.4-2	PERFORM	_
INSPECTION TASKS AFTER WELDING				
WELDS CLEANED	1705.2.1	AISC 360 N5.4-3	OBSERVE	_
SIZE, LENGTH AND LOCATION OF WELDS WELDS MEET VISUAL ACCEPTANCE CRITERIA	1705.2.1	AISC 360 N5.4-3	PERFORM	_
A. CRACK PROHIBITION	1705.2.1	AISC 360 N5.4-3	PERFORM	
B. WELD/BASE-METAL FUSION	1705.2.1	AISC 360 N5.4-3	PERFORM	
C. CRATER CROSS SECTION	1705.2.1	AISC 360 N5.4-3	PERFORM	_
D. WELD PROFILES	1705.2.1	AISC 360 N5.4-3	PERFORM	_
E. WELD SIZE	1705.2.1	AISC 360 N5.4-3	PERFORM	<u> </u>
F. UNDERCUT	1705.2.1	AISC 360 N5.4-3	PERFORM	
G. POROSITY	1705.2.1	AISC 360 N5.4-3	PERFORM	<u> </u>
ARC STRIKES	1705.2.1	AISC 360 N5.4-3	PERFORM	
K-AREA WELD ACCESS HOLES IN ROLLED HEAVY SHAPES AND BUILT-UP	1705.2.1	AISC 360 N5.4-3	PERFORM	(NOTE 3)
HEAVY SECTIONS	1705.2.1	AISC 360 N5.4-3	PERFORM	(NOTE 4)
BACKING REMOVED AND WELD TABS REMOVED (IF REQUIRED) REPAIR ACTIVITIES	1705.2.1 1705.2.1	AISC 360 N5.4-3 AISC 360 N5.4-3	PERFORM PERFORM	<u> </u>
DOCUMENT ACCEPTANCE OR REJECTION OF WELDED JOINT OR MEMBER	1705.2.1	AISC 360 N5.4-3	PERFORM	
NO PROHIBITED WELDS HAVE BEEN ADDED WITHOUT THE APPROVAL OF THE EOR	1705.2.1	AISC 360 N5.4-3	OBSERVE	

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- 2. THE FABRICATOR OR ERECTOR, AS APPLICABLE, SHALL MAINTAIN A SYSTEM BY WHICH A WELDER WHO HAS WELDED A JOINT OR MEMBER CAN BE IDENTIFIED. STAMPS, IF USED, SHALL BE THE LOW-STRESS TYPE.
- 3. WHEN WELDING OF DOUBLER PLATES, CONTINUITY PLATES OR STIFFENERS HAS BEEN PERFORMED IN THE K-AREA, VISUALLY INSPECT THE WEB K-AREA FOR CRACK WITHIN 3 INCHES OF THE WELD.
- 4. AFTER ROLLED HEAVY SHAPES AND BUILT-UP SHAPES ARE WELDED, VISUALLY INSPECT THE WELD ACCESS HOLE FOR CRACKS.

Al

NOTIFICATION OF POTENTIAL HAZARD

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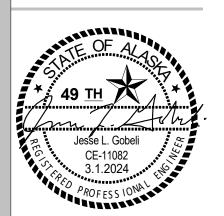
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ANCHORAGE SCHOOL DISTRICT

Spring Hill Elementary School Roof Replacement

9911 Lake Otis Pkwy, Anchorage, AK

95% BID DOCUMENTS

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PROJ. MGR.:	JG
DRAWN BY:	MEH
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REVISIONS:	

SPECIAL INSPECTIONS


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EPA AND OSHA REQUIREMENTS.

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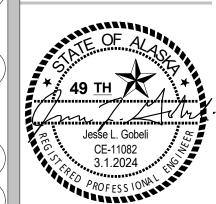


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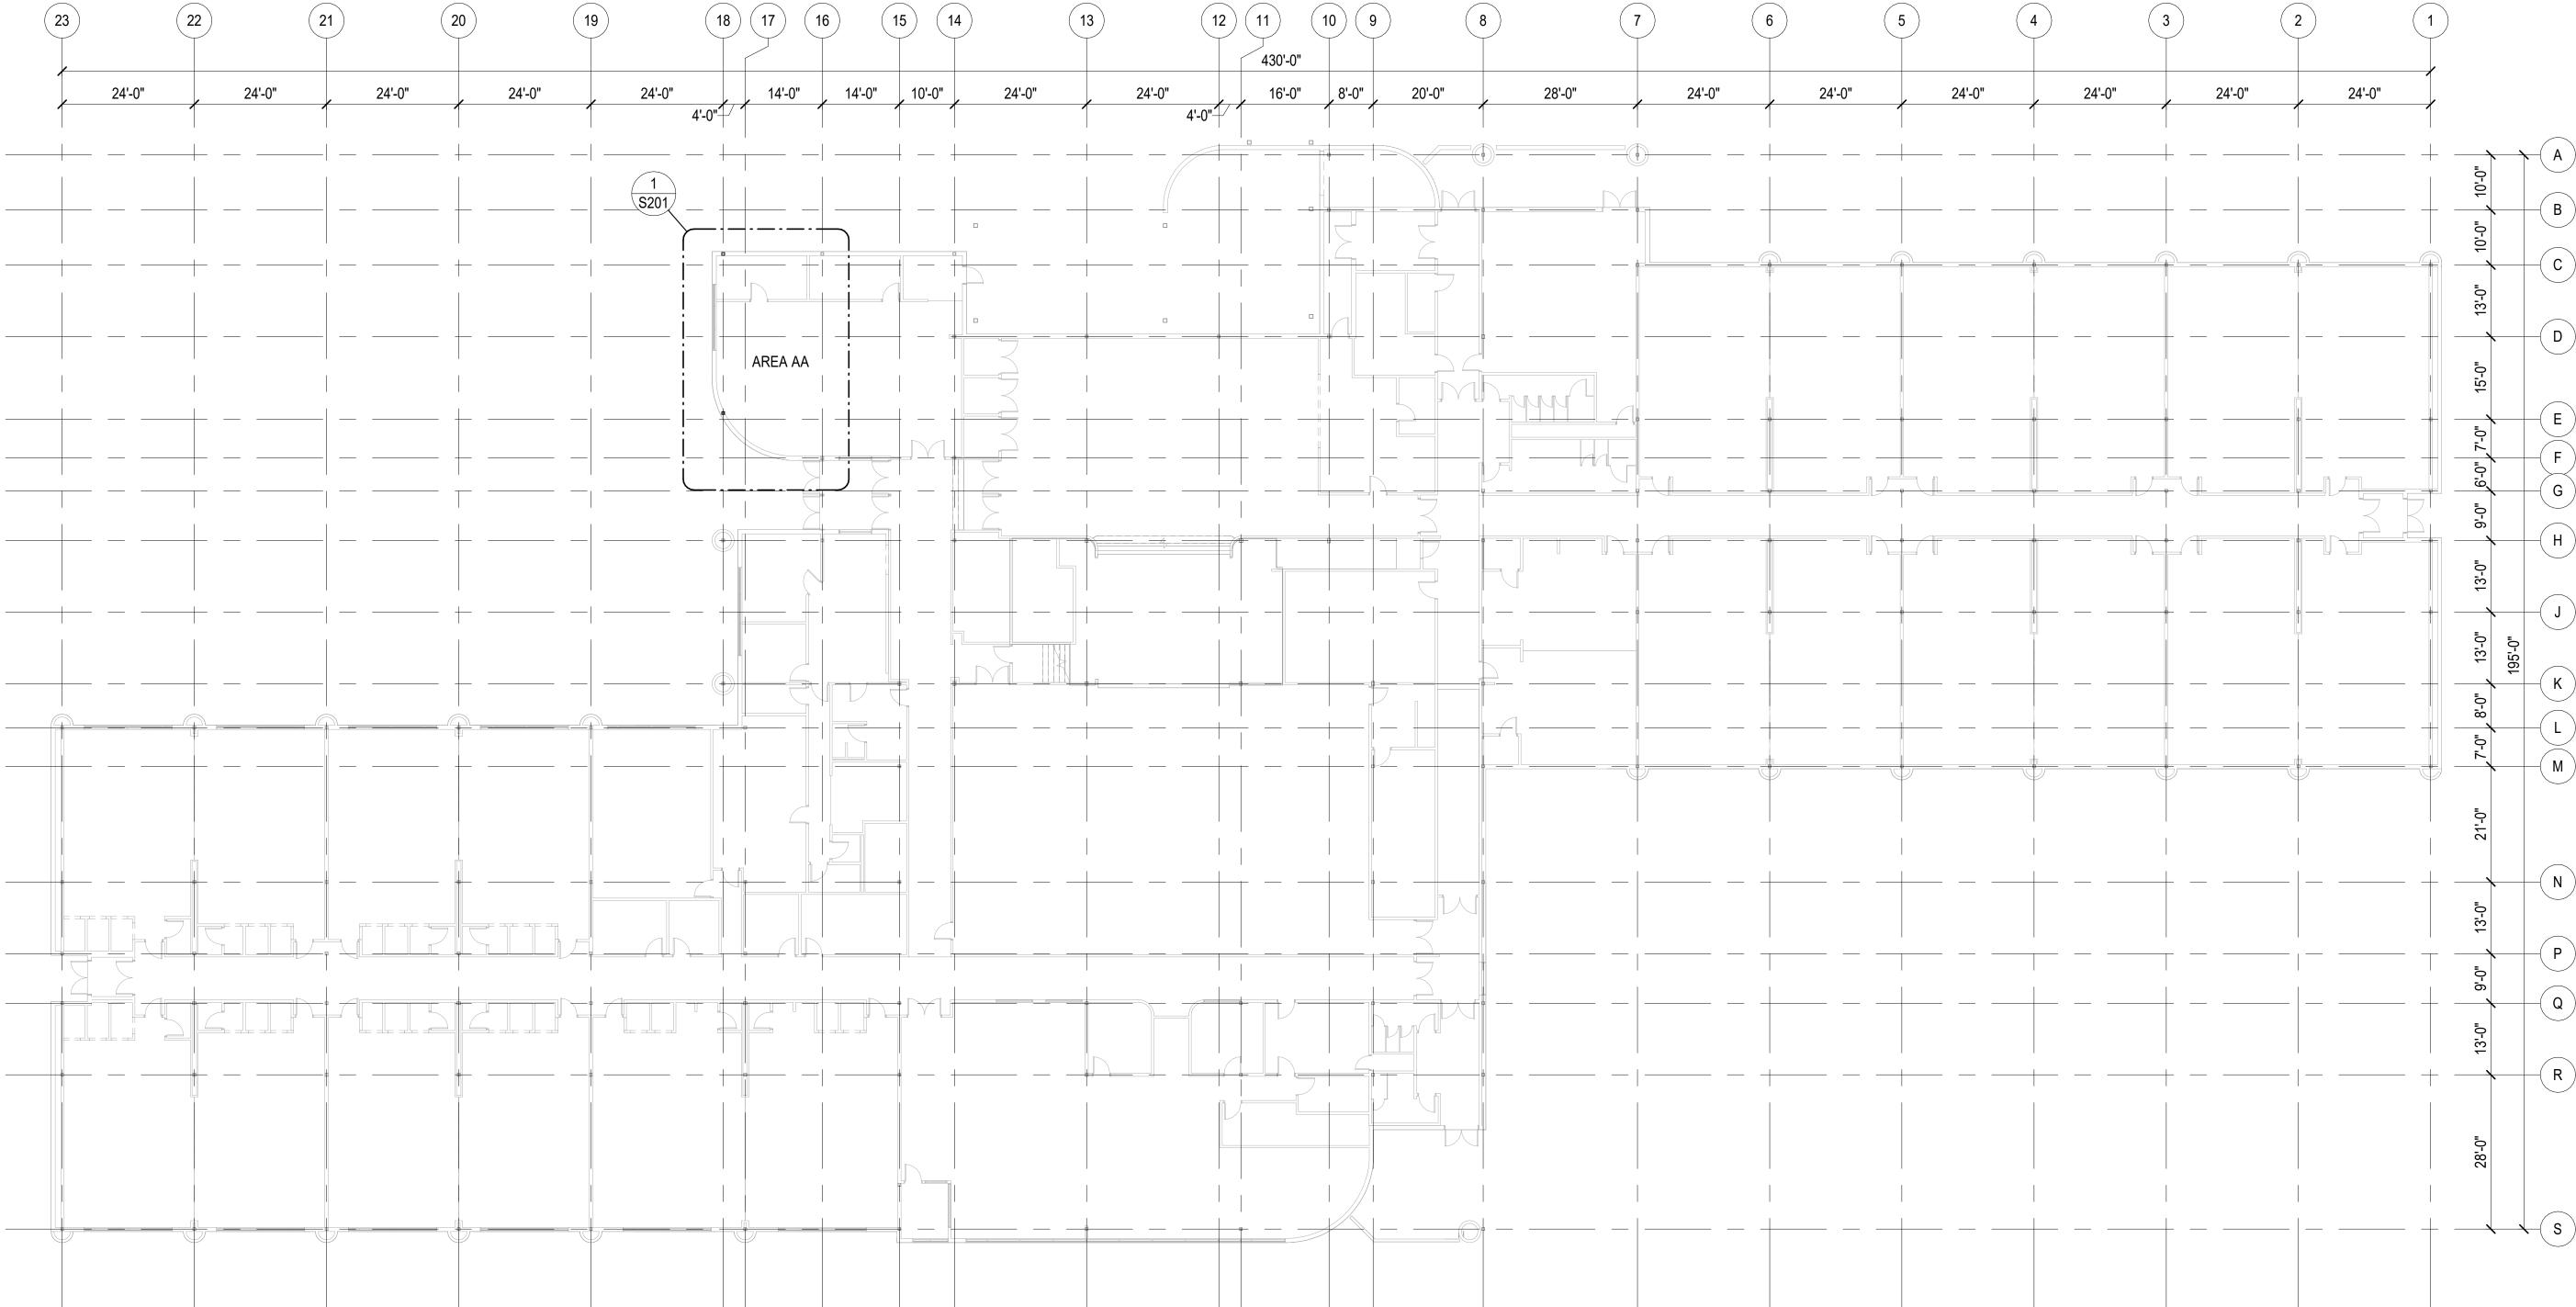
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 DRAWN BY:
 MEH

 REVIEWED BY:
 JG

OVERALL FIRST FLOOR PLAN

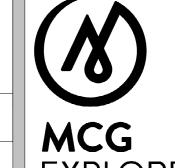SHEET NO.



OVERALL FIRST FLOOR PLAN

EPA AND OSHA REQUIREMENTS.

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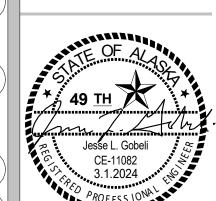
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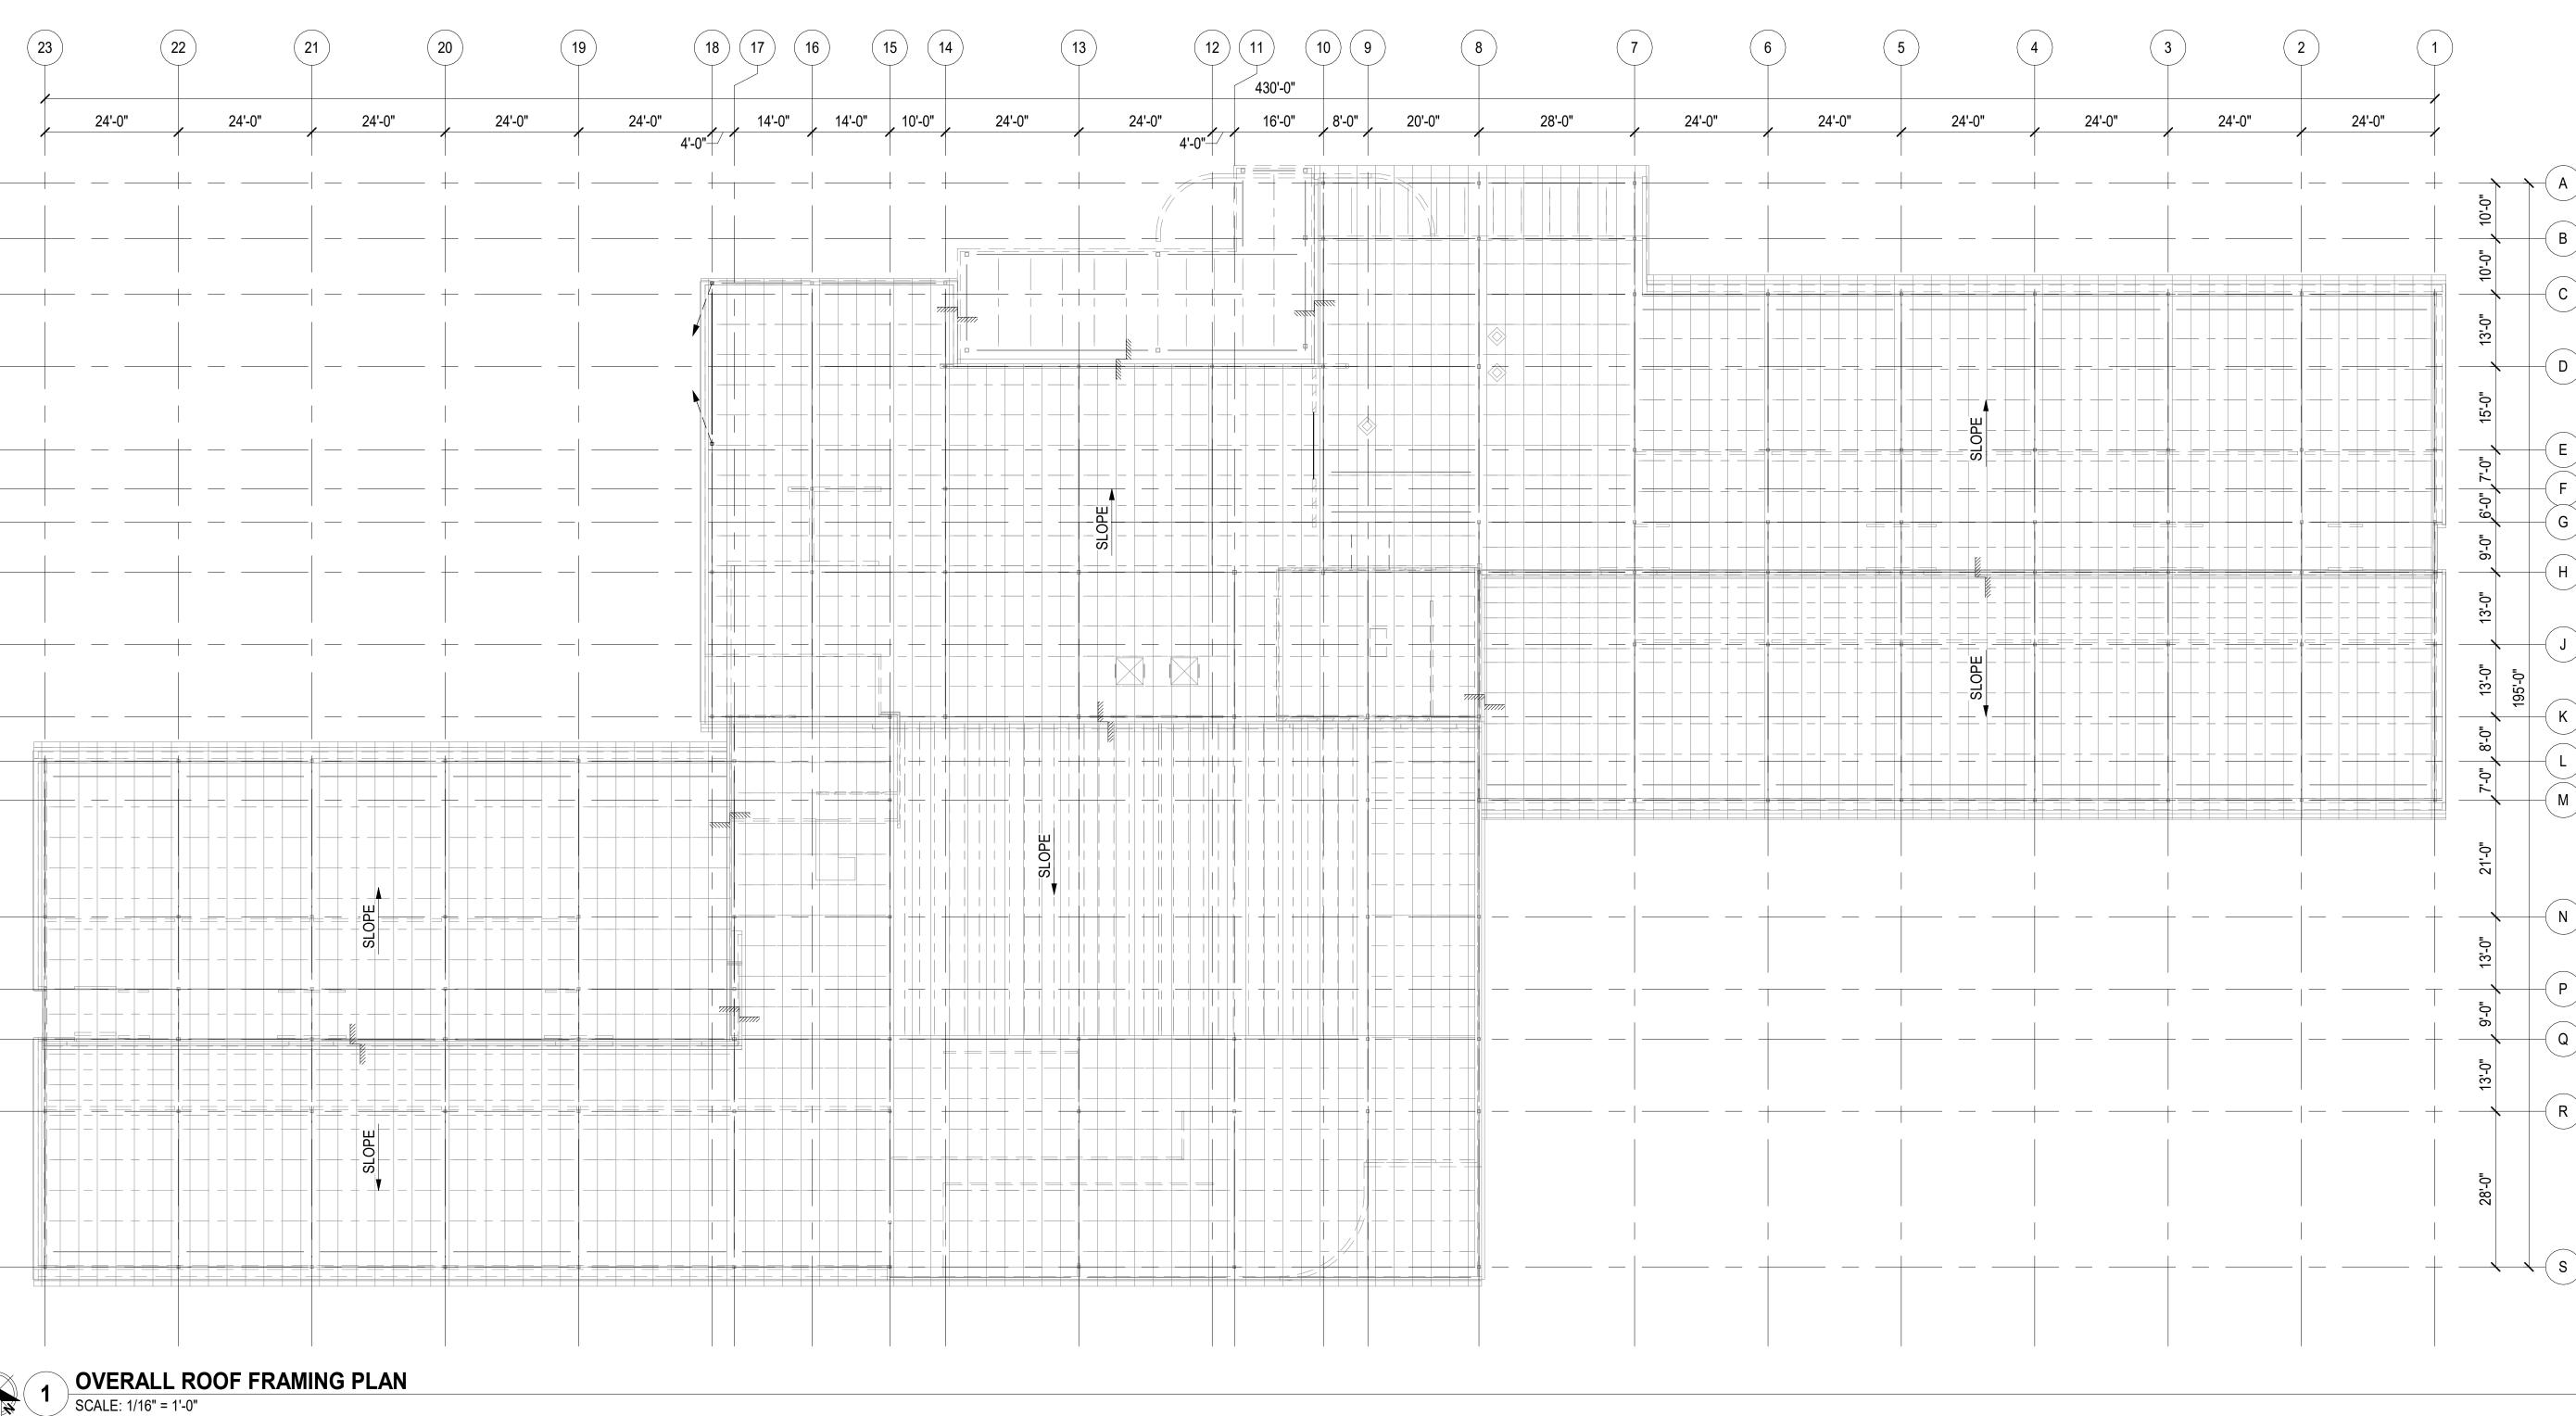
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DRAWN BY:	MEH
REVIEWED BY:	JG
REVISIONS:	

OVERALL ROOF FRAMING PLAN

SHEET NO. **S102**

KEY PLAN



NOTIFICATION OF POTENTIAL HAZARD
ASBESTOS, LEAD AND OTHER POTENTIALLY HAZARDOUS MATERIALS ARE
PRESENT IN THE BUILDING THAT MAY IMPACT THE WORK OF ALL TRADES.
REGULATED AIR CONTAMINANTS, INCLUDING ASBESTOS AND LEAD, ARE ALSO
PRESENT IN SETTLED AND CONCEALED DUST IN AND ON ARCHITECTURAL,

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PERMIT STAMP

○ FRAMING KEYNOTES:

1 HATCH INDICATES AREAS OF KNOWN ROOF LEAKS. REPLACE EXISTING ROOF DECK AS REQUIRED. MATCH EXISTING ROOF DECK AND ATTACHMENT: 1 1/2" B-30 18 GAGE ROOF DECK WITH 3/4" DIA PLUG WELDS AT 12" OC AT BOUNDARIES AND (6) PER PANEL AT ALL SUPPORTS, CONNECT SIDE LAPS WITH TOP SEAM WELDS AT 24" OC.

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Jesse L. Gobeli
CE-11082
3.1.2024

ANCHORAGE SCHOOL DISTRICT

Spring Hill Elementary School Roof Replacement

9911 Lake Otis Pkwy, Anchorage, AK


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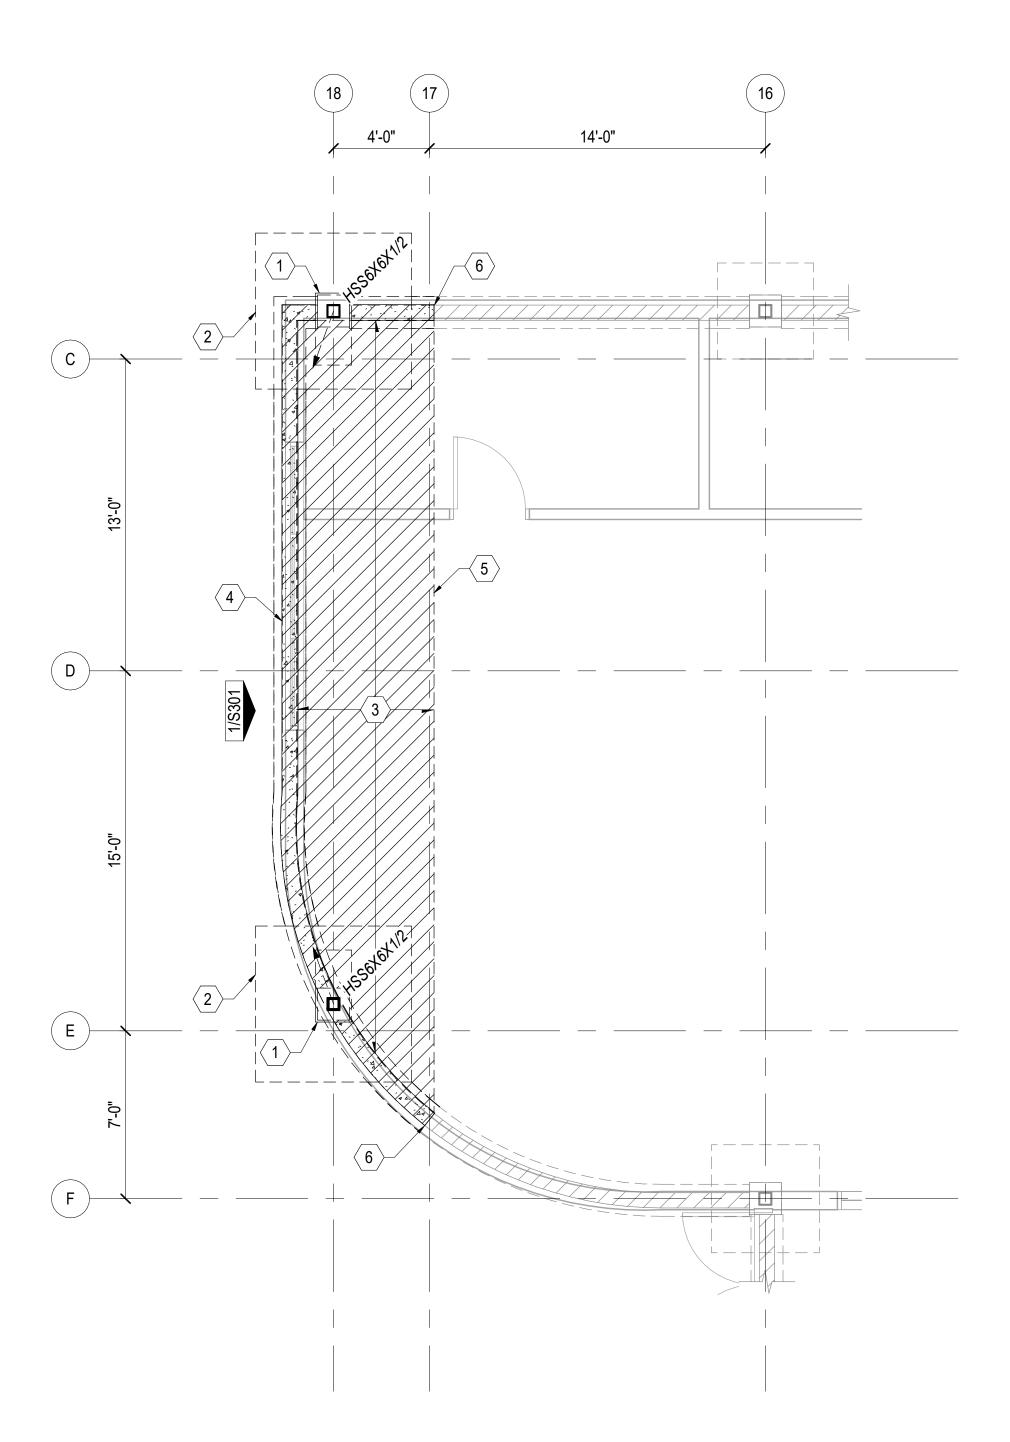
JOB NO.	24.010
DATE:	02/14/2024
PROJ. MGR.:	JG
DRAWN BY:	MEH
REVIEWED BY:	JG
REVISIONS:	

ROOF FRAMING PLAN - AREA C

SHEET NO.

C KEY PLAN



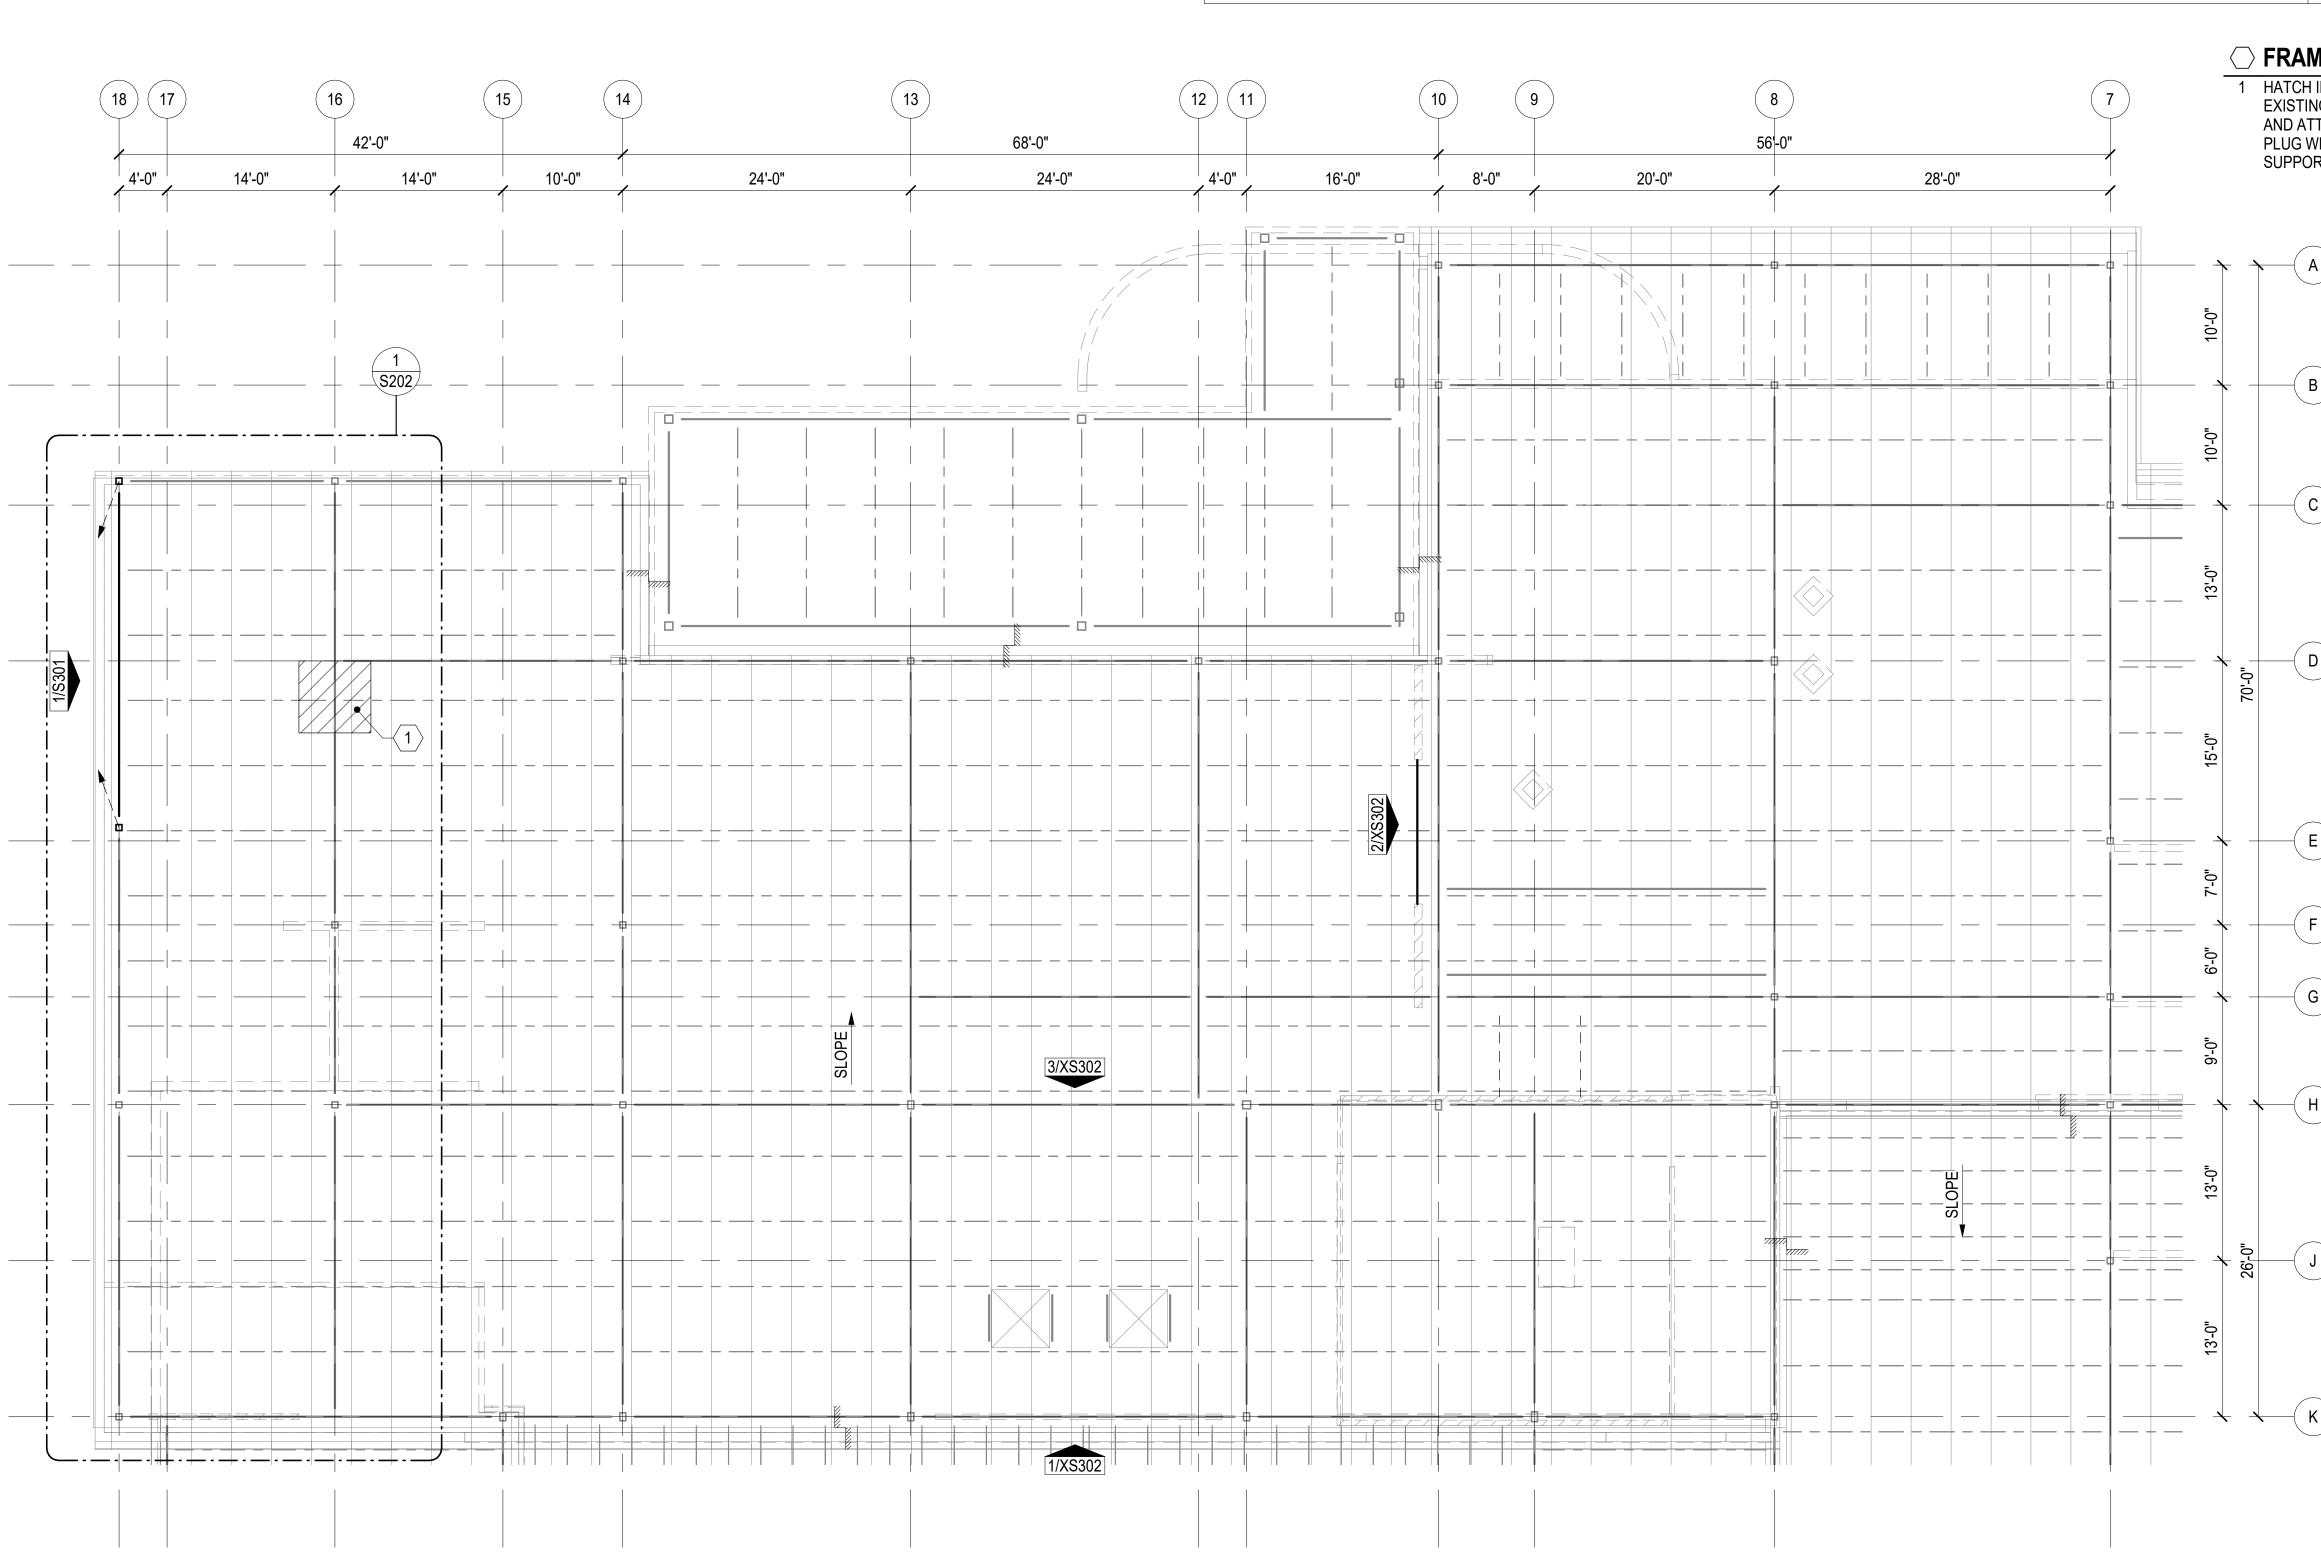

ENLARGED FOUNDATION PLAN - AREA AA

SCALE: 1/4" = 1'-0"

NOTIFICATION OF POTENTIAL HAZARD ASBESTOS, LEAD AND OTHER POTENTIALLY HAZARDOUS MATERIALS ARE PRESENT IN THE BUILDING THAT MAY IMPACT THE WORK OF ALL TRADES. REGULATED AIR CONTAMINANTS, INCLUDING ASBESTOS AND LEAD, ARE ALSO PRESENT IN SETTLED AND CONCEALED DUST IN AND ON ARCHITECTURAL, STRUCTURAL, MECHANICAL AND ELECTRICAL COMPONENTS OR SYSTEMS THROUGHOUT THE BUILDING. ALL TRADES SHALL COORDINATE WITH OTHER TRADES AND CONDUCT THEIR WORK TO PREVENT WORKER EXPOSURE OR SITE CONTAMINATION. REFER TO SPECIFICATION DIVISIONS 0, 1 AND 2 FOR SPECIFIC INFORMATION CONCERNING DISTURBING, REMOVING AND DISPOSING OF THESE MATERIALS AND THE INSTALLATION OF NEW MATERIALS OR COMPONENTS. THIS NOTIFICATION IS PROVIDED IN ACCORDANCE WITH EPA AND OSHA REQUIREMENTS.

KEY PLAN

NOTIFICATION OF CHILD OCCUPIED FACILITY PORTIONS OF THIS BUILDING ARE CLASSIFIED AS A CHILD OCCUPIED FACILITY IN ACCORDANCE WITH 40 CFR 745 AND LEAD-BASED PAINTS MAY BE PRESENT ON COMPONENTS TO BE DISTURBED IN THOSE AREAS. PERSONNEL PERFORMING WORK IN THESE AREAS MUST COMPLY WITH THE REQUIREMENTS OF 40 CFR 745, INCLUDING TRAINING, WORK PRACTICES AND CLEANING OF THE WORK AREA. REFER TO SPECIFICATION DIVISIONS 0, 1 AND 2 FOR SPECIFIC INFORMATION CONCERNING DISTURBING, REMOVING AND DISPOSING OF LEAD MATERIALS AND THE INSTALLATION OF NEW MATERIALS OR COMPONENTS. THIS NOTIFICATION IS PROVIDED IN ACCORDANCE WITH EPA AND OSHA REQUIREMENTS.

○ SHEET KEYNOTES:

- 1 NEW 1'-6" X 3'-0" CONCRETE PEDESTAL
- 2 NEW 18" X 6'-6" X 6'-6" CONCRETE FOOTING. REINFORCE WITH #5 BARS AT 12" OC EW, TOP AND BOTTOM
- 3 DEMO (E) CONC SLAB ON GRADE AS REQ'D FOR NEW FOOTINGS AND PEDESTALS. REPLACE WITH 4" CONCRETE SLAB ON GRADE, REINFORCED WITH #4 BARS AT 18" OC, EW, AND DOWEL INTO (E) SLAB 4" MIN
- 4 DEMO (E) CONC FOOTING AND MASONRY STEM WALL AS REQ'D FOR NEW FOOTINGS AND PEDESTALS. REPLACE WITH 12"t x16"w CONCRETE FOOTING AND 8" CONCRETE STEM WALL. REINFORCE FOOTING WITH (2) #5 BARS, BOTTOM. REINFORCE STEMWALL WITH #4 BARS AT 16" OC EW.
- SUPPORT ABOVE ROOF, JOISTS, AND CEILING.
- 6 DOWEL REINFORCEMENT FROM NEW TO (E) STEMWALL AND

PERMIT STAMP

- 5 ADD SHORING WALL INBOARD OF DEMO SLAB LOCATION TO
- FOOTING.



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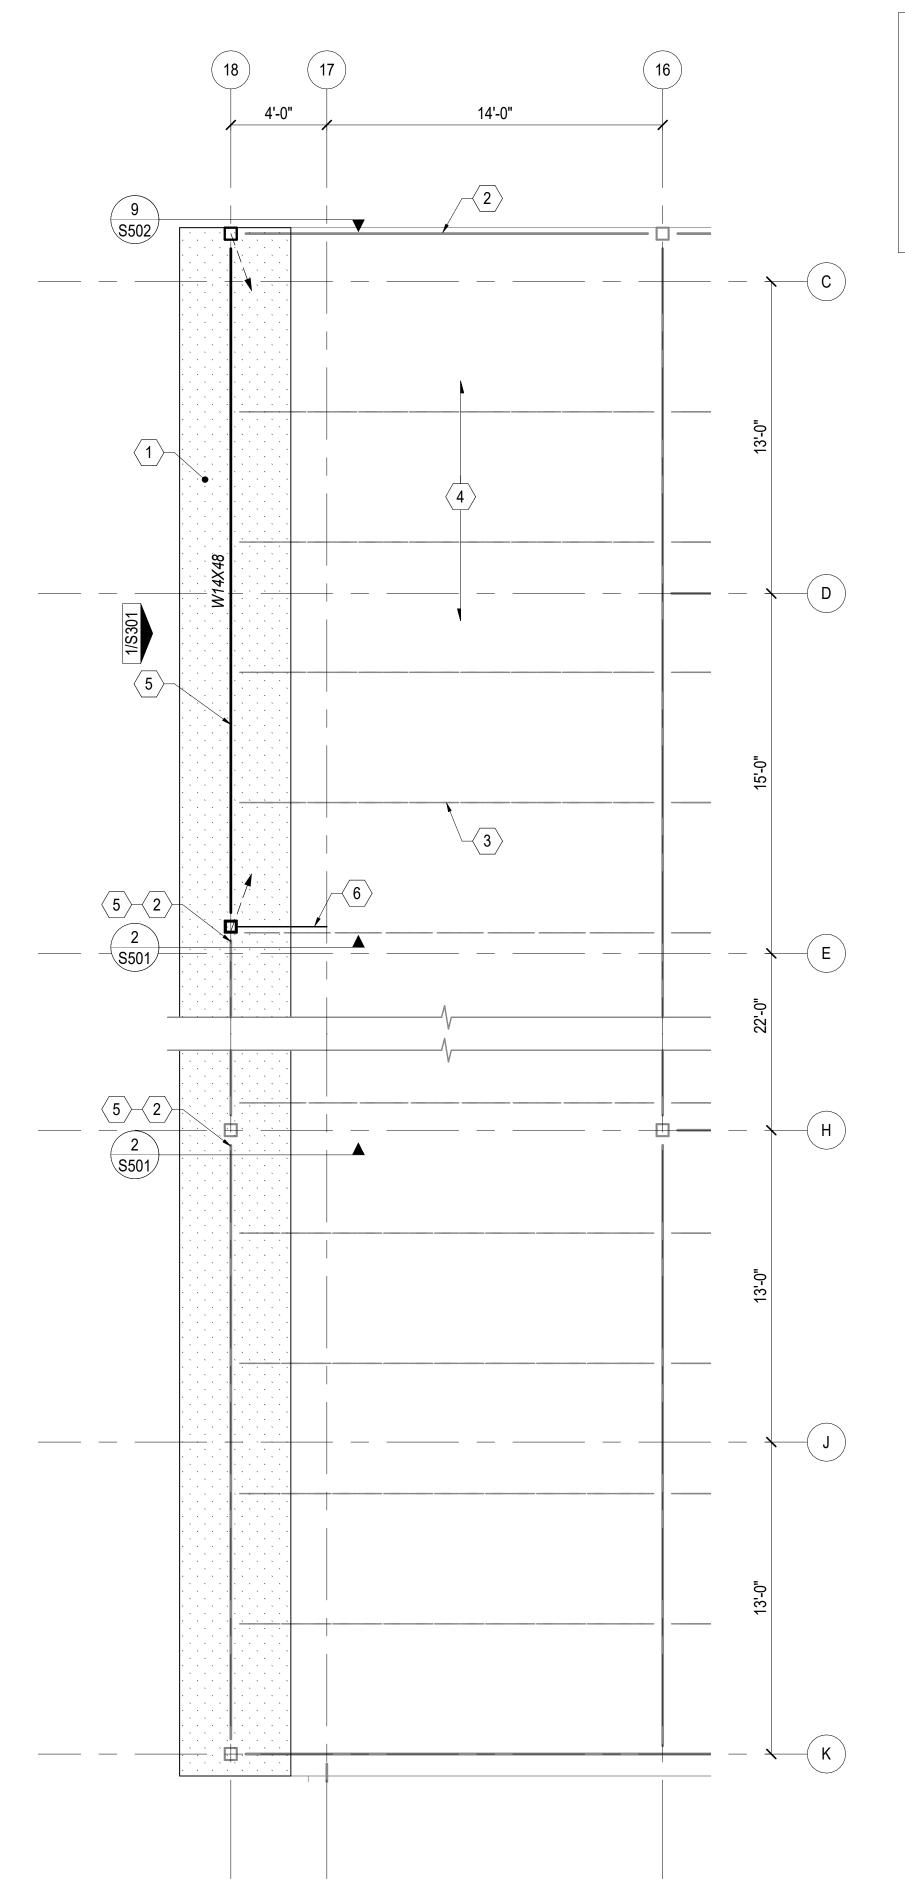
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DRAWN BY:	MEH
REVIEWED BY:	JG
REVISIONS:	

ENLARGED FOUNDATION PLAN

> SHEET NO. **S201**





NOTIFICATION OF POTENTIAL HAZARD

ASBESTOS, LEAD AND OTHER POTENTIALLY HAZARDOUS MATERIALS ARE PRESENT IN THE BUILDING THAT MAY IMPACT THE WORK OF ALL TRADES. REGULATED AIR CONTAMINANTS, INCLUDING ASBESTOS AND LEAD, ARE ALSO PRESENT IN SETTLED AND CONCEALED DUST IN AND ON ARCHITECTURAL, STRUCTURAL, MECHANICAL AND ELECTRICAL COMPONENTS OR SYSTEMS THROUGHOUT THE BUILDING. ALL TRADES SHALL COORDINATE WITH OTHER TRADES AND CONDUCT THEIR WORK TO PREVENT WORKER EXPOSURE OR SITE CONTAMINATION. REFER TO SPECIFICATION DIVISIONS 0, 1 AND 2 FOR SPECIFIC INFORMATION CONCERNING DISTURBING, REMOVING AND DISPOSING OF THESE MATERIALS AND THE INSTALLATION OF NEW MATERIALS OR COMPONENTS. THIS NOTIFICATION IS PROVIDED IN ACCORDANCE WITH EPA AND OSHA REQUIREMENTS.

NOTIFICATION OF CHILD OCCUPIED FACILITY PORTIONS OF THIS BUILDING ARE CLASSIFIED AS A CHILD OCCUPIED FACILITY IN ACCORDANCE WITH 40 CFR 745 AND LEAD-BASED PAINTS MAY BE PRESENT ON COMPONENTS TO BE DISTURBED IN THOSE AREAS. PERSONNEL PERFORMING WORK IN THESE AREAS MUST COMPLY WITH THE REQUIREMENTS OF 40 CFR 745, INCLUDING TRAINING, WORK PRACTICES AND CLEANING OF THE WORK AREA. REFER TO SPECIFICATION DIVISIONS 0, 1 AND 2 FOR SPECIFIC INFORMATION CONCERNING DISTURBING, REMOVING AND DISPOSING OF LEAD MATERIALS AND THE INSTALLATION OF NEW MATERIALS OR COMPONENTS. THIS NOTIFICATION IS PROVIDED IN ACCORDANCE WITH EPA AND OSHA REQUIREMENTS.

PERMIT STAMP

> SHEET KEYNOTES:

- 1 DETACH (E) DECKING FROM ROOF SUPPORTS ALONG GRID 18. ATTACH (E) DECKING TO SUPPORT MEMBERS WITH 3/4Ø PUDDLE WELDS, MIN (3) AT 2'-0" OC.
- 2 SHORE BEAM PRIOR TO STRUCTURAL DEMO.
- 3 SHORE JOISTS SUPPORTED BY DEMO'D BEAM PRIOR TO REMOVAL.
- 4 (E) 1-1/2" TYPE B MTL DECK
- 5 PROVIDE 2L4x4x3/8 KICKERS AT EA JOIST TO BEAM BOTTOM FLANGE.
- 6 KICKER BRACE FROM COL TO (E) JOIST



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Spring Hill Elementary School Roof Replacement


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).	24.010
	02/14/2024
MGR.:	JG
N BY:	MEH
VED BY:	JG
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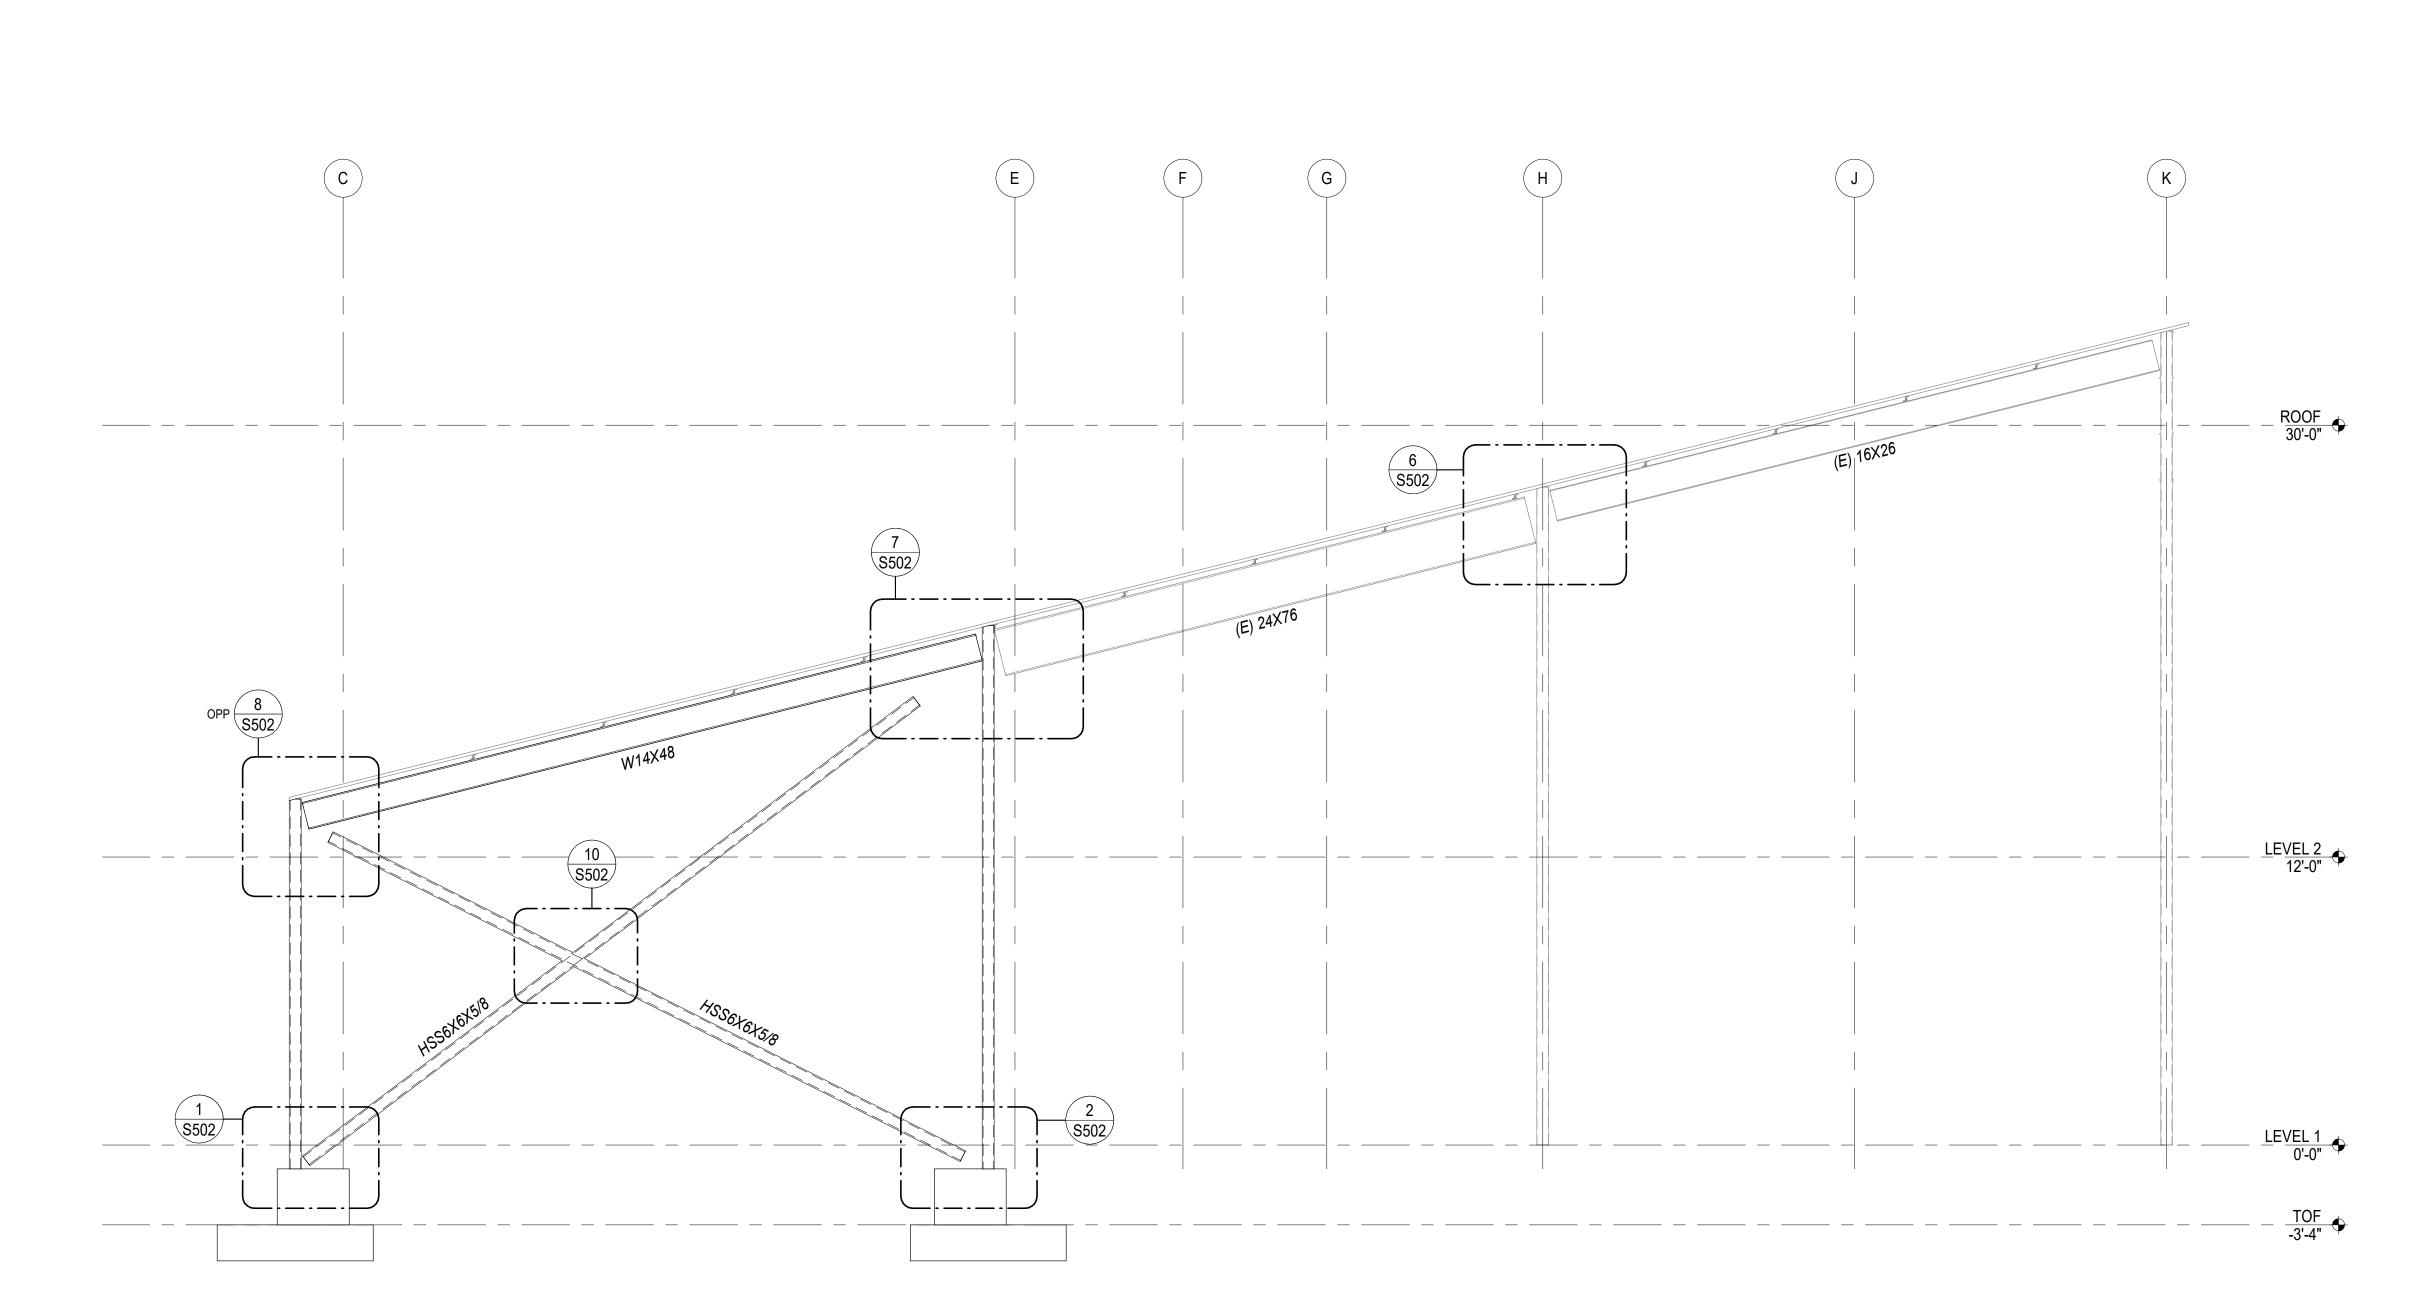
ENLARGED ROOF FRAMING PLAN

SHEET NO.



NOTIFICATION OF CHILD OCCUPIED FACILITY
PORTIONS OF THIS BUILDING ARE CLASSIFIED AS A CHILD
OCCUPIED FACILITY IN ACCORDANCE WITH 40 CFR 745 AND
LEAD-BASED PAINTS MAY BE PRESENT ON COMPONENTS TO BE
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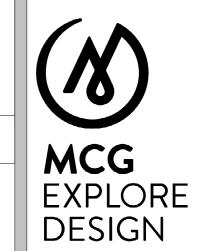
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1 BRACED FRAME ELEVATION


SCALE: 1/4" = 1'-0"
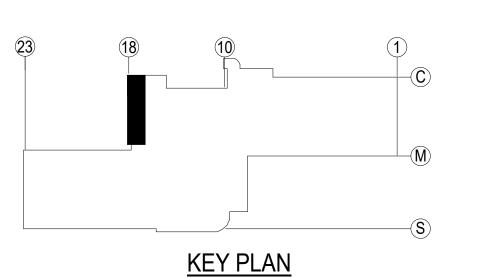
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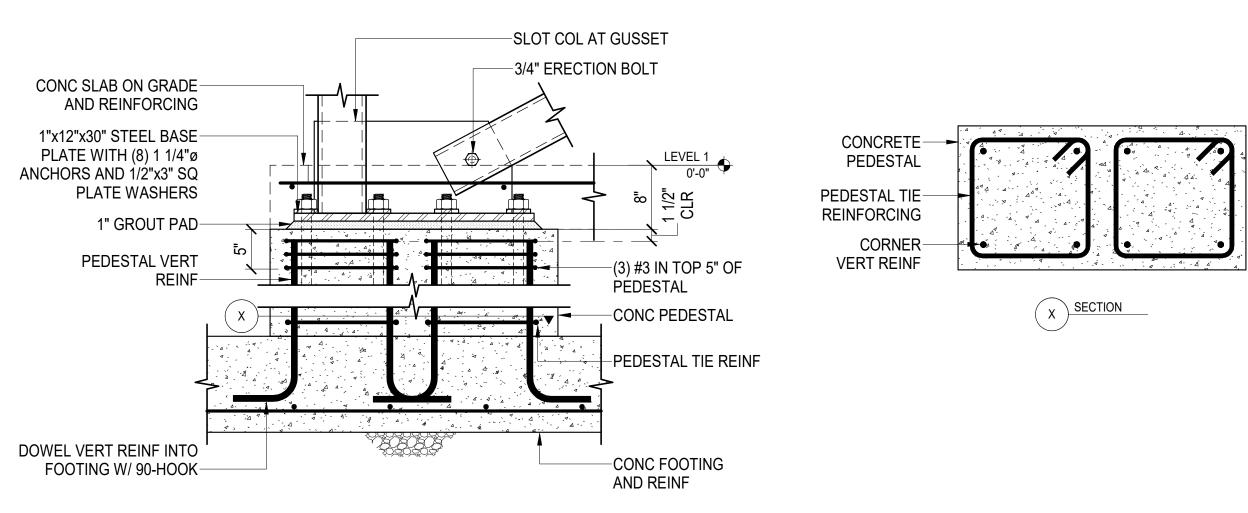
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BRACED FRAME ELEVATION


SHEET NO. **S301**

NOTIFICATION OF CHILD OCCUPIED FACILITY PORTIONS OF THIS BUILDING ARE CLASSIFIED AS A CHILD OCCUPIED FACILITY IN ACCORDANCE WITH 40 CFR 745 AND LEAD-BASED PAINTS MAY BE PRESENT ON COMPONENTS TO BE DISTURBED IN THOSE AREAS. PERSONNEL PERFORMING WORK IN THESE AREAS MUST COMPLY WITH THE REQUIREMENTS OF 40 CFR 745, INCLUDING TRAINING, WORK PRACTICES AND CLEANING OF THE WORK AREA. REFER TO SPECIFICATION DIVISIONS 0, 1 AND 2 FOR SPECIFIC INFORMATION CONCERNING DISTURBING, REMOVING AND DISPOSING OF LEAD MATERIALS AND THE INSTALLATION OF NEW MATERIALS OR COMPONENTS. THIS NOTIFICATION IS PROVIDED IN ACCORDANCE WITH EPA AND OSHA REQUIREMENTS.

PERMIT STAMP

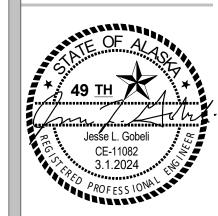

TYP STEEL BRACE AT CONC PEDESTAL SCALE: NTS

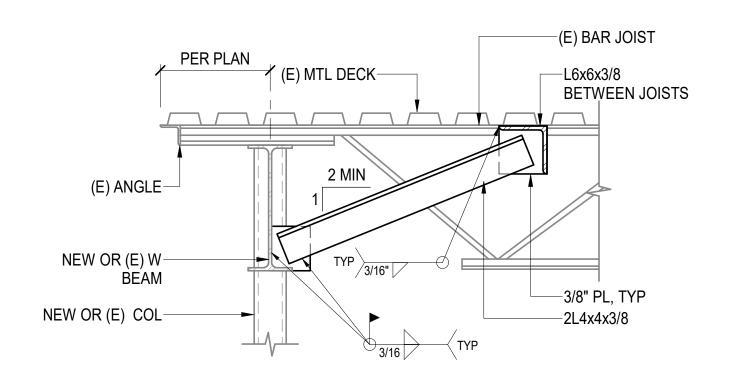


2 TYP STEEL BRACE AT STEEL BEAM

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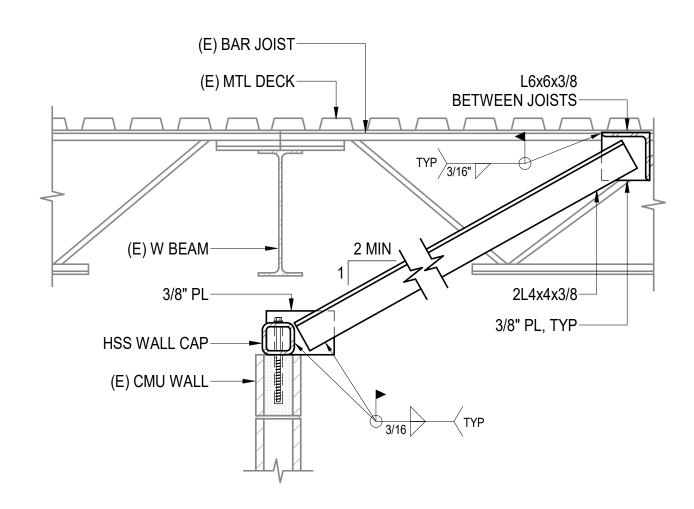
DETAILS

SHEET NO.


COL -1/2" A572, GR 50 PL BOTH SIDES OF \ -BRACE BRACE, TYP /5/16" / 6" COL TO GUSSET, BOTH SIDES OF 5/16" 9" COL, TYP GUSSET TO BASEPLATE, TYP **WORK POINT**

- A. CONC SLAB ON GRADE AND STEM WALL NOT SHOWN FOR CLARITY.
- FOR INFORMATION SHOWN BUT NOT SPECIFIED, SEE DETAIL 1 / S501.

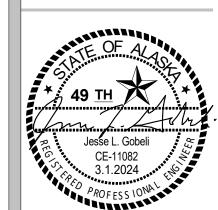STEEL BRACE AT STEEL COLUMN



STEEL KICKER AT EXISTING CMU WALL

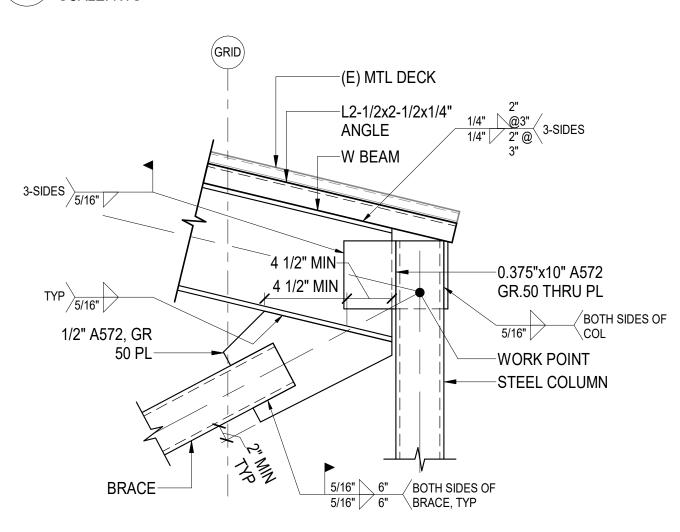

NOTIFICATION OF POTENTIAL HAZARD ASBESTOS, LEAD AND OTHER POTENTIALLY HAZARDOUS MATERIALS ARE PRESENT IN THE BUILDING THAT MAY IMPACT THE WORK OF ALL TRADES. REGULATED AIR CONTAMINANTS, INCLUDING ASBESTOS AND LEAD, ARE ALSO

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NOTIFICATION OF CHILD OCCUPIED FACILITY

OF COL

3 SIDES, TYP 5/16"

0.375"x10" A572-

−1/2" A572, GR 50 PL

6" MIN

GR.50 THRU PL

(E) MTL DECK-

ANGLE

W BEAM-

L2-1/2x2-1/2x1/4"-

3-SIDES 1/4" @3" 1/4" 2" @

BOTH SIDES OF 5/16"

GUSSET PL

BRACE. SLOT FOR


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GRID EPA AND OSHA REQUIREMENTS. 1/2" A572, GR-50 PL _/ BOTH SIDES OF /COL TO GUSSET, \langle BOTH SIDES OF COL, TYP BRACE-GUSSET TO BASEPLATE, TYP 5/16" -WORK POINT


> A. CONC SLAB ON GRADE AND STEM WALL NOT SHOWN FOR CLARITY.

B. FOR INFORMATION SHOWN BUT NOT SPECIFIED, SEE DETAIL 1 / S501.


STEEL BRACE AT STEEL COLUMN

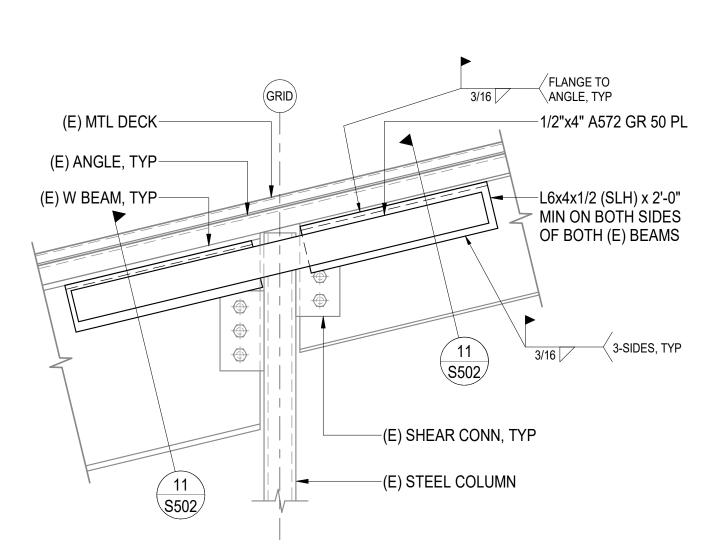

STEEL BEAM AT STEEM COLUMN

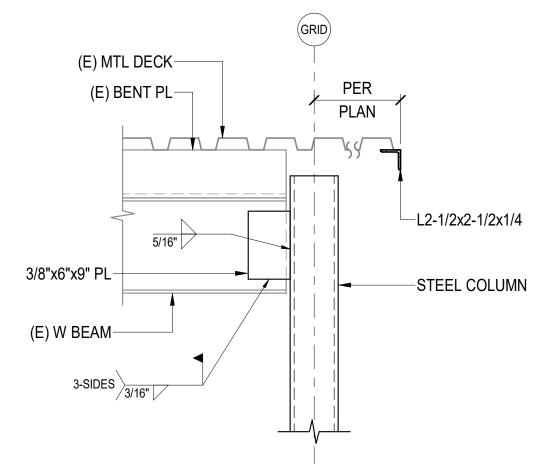

STEEL BRACE AT STEEM BEAM

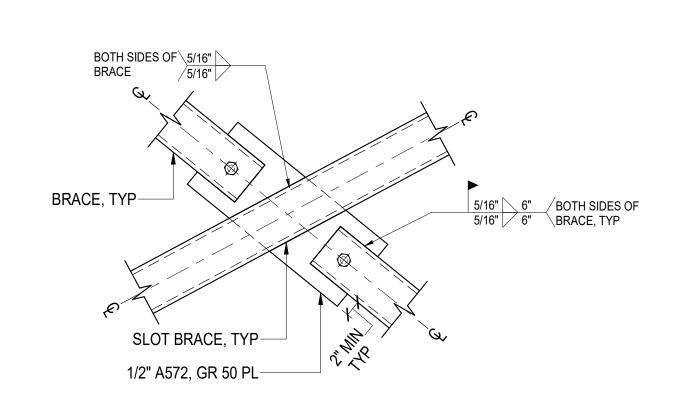

STEEL BEAM AT STEEL COLUMN STEEL BRACE AT STEEL BRACE

STEEL BEAM AT STEEL BEAM

-ANGLE

-STEEL PL

-COL BEYOND

(E) OR NEW BEAM

−(E) W BEAM

−(E) ANGLE

-WORK POINT

-1/2"x10" A572 GR.50 PL

-STEEL COLUMN


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Spring Hill Elementary **School Roof** Replacement

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DETAILS

SHEET NO.

S502

STEEL BRACE AT STEEL BEAM

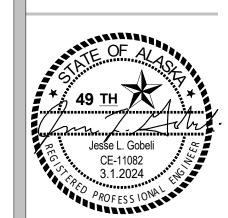NOTIFICATION OF CHILD OCCUPIED FACILITY
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ANCHORAGE SCHOOL DISTRICT

Spring Hill Elementary School Roof Replacement

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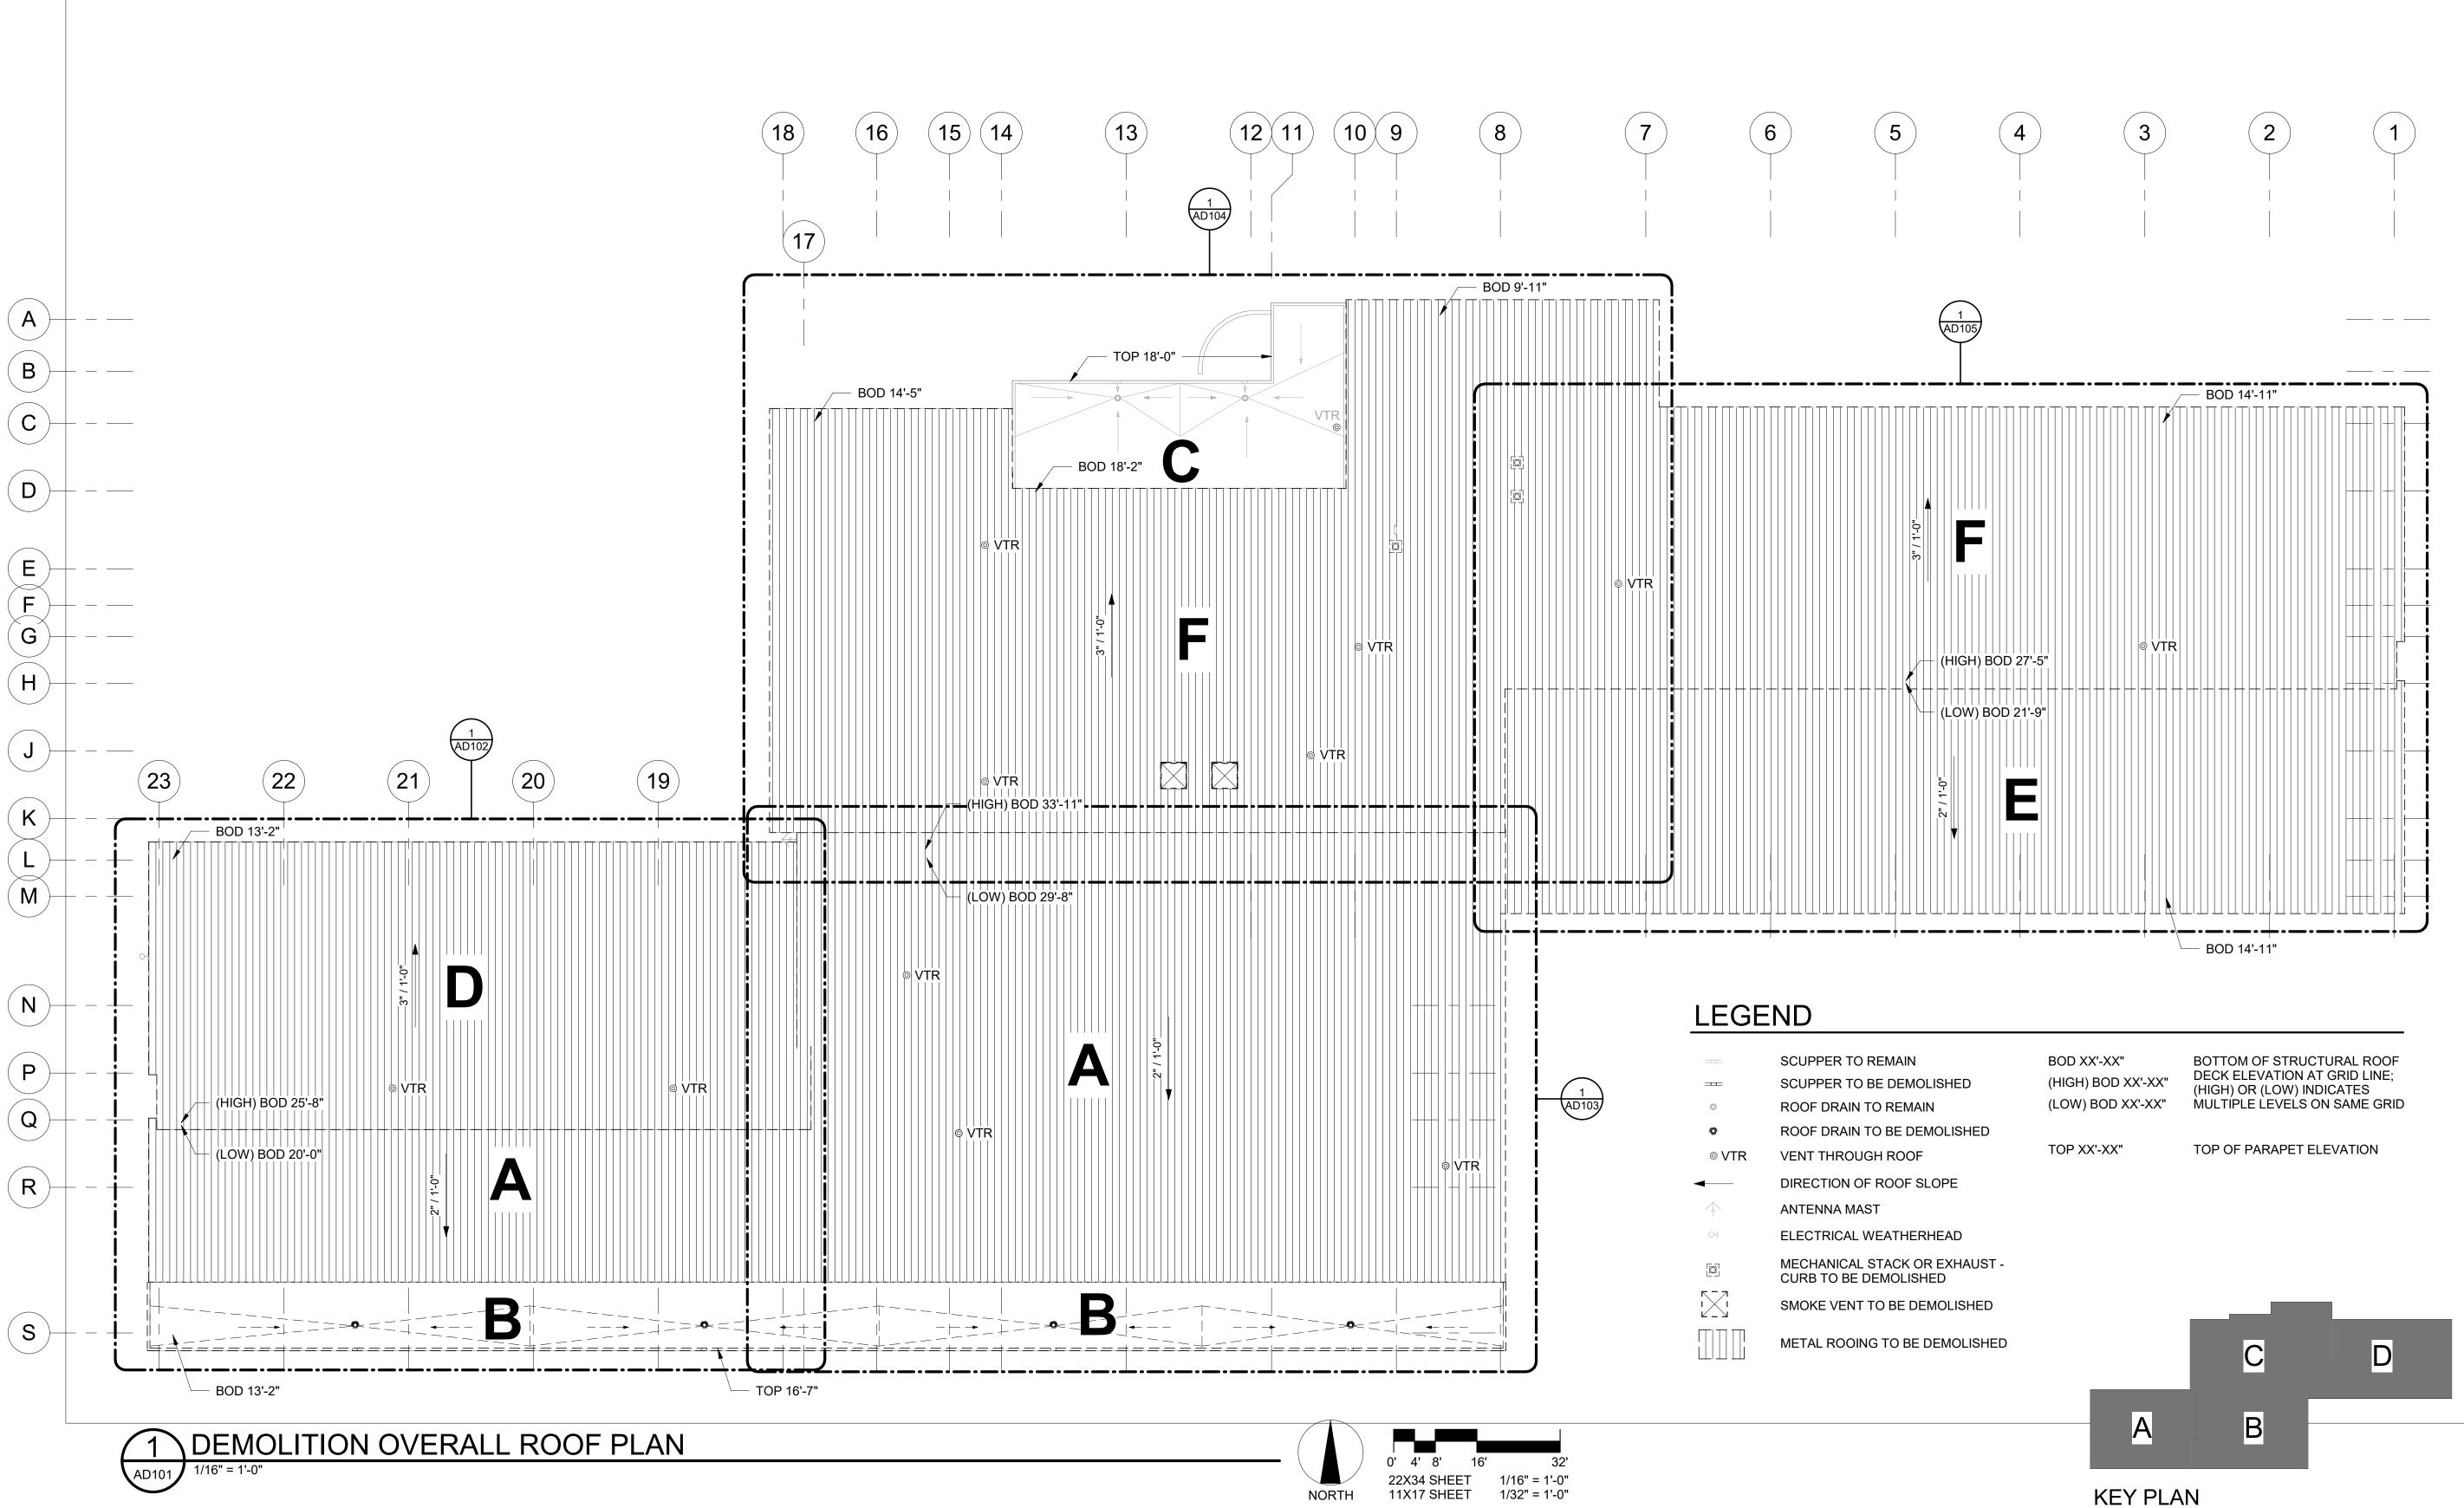
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REVISIONS:	

DEMOLITION OVERALL ROOF

SHEET NO.
AD101

PLAN



NOTIFICATION OF CHILD OCCUPIED FACILITY PORTIONS OF THIS BUILDING ARE CLASSIFIED AS A CHILD OCCUPIED FACILITY IN ACCORDANCE WITH 40 CFR 745 AND LEAD-BASED PAINTS MAY BE PRESENT ON COMPONENTS TO BE DISTURBED IN THOSE AREAS. PERSONNEL PERFORMING WORK IN THESE AREAS MUST COMPLY WITH THE REQUIREMENTS OF 40 CFR 745, INCLUDING TRAINING, WORK PRACTICES AND CLEANING OF THE WORK AREA. REFER TO SPECIFICATION DIVISIONS 0, 1 AND 2 FOR SPECIFIC INFORMATION CONCERNING DISTURBING, REMOVING AND DISPOSING OF LEAD MATERIALS AND THE INSTALLATION OF NEW MATERIALS OR COMPONENTS. THIS NOTIFICATION IS PROVIDED IN ACCORDANCE WITH EPA AND OSHA REQUIREMENTS.

1/16" = 1'-0"

11X17 SHEET

SUBMITTAL PRICING

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GENERAL NOTES-DEMOLITION


- THE INFORMATION SHOWN IN THIS DRAWING IS TAKEN FROM RECORD DRAWINGS AND A WALK-THRU OF THE EXISTING FACILITY. THERE IS NO WARRANTY OR GUARANTEE AS OF THE ACCURACY OF THE INFORMATION SHOWN. THE CONTRACTOR SHALL FIELD VERIFY CRITCAL ITEMS, AREA, AND ASSEMBLIES SHOWN FOR DEMOLITION PRIOR TO START OF WORK
- ROOF ELEVATIONS SHOWN INDICATE BOTTOM OF STRUCTURAL DECK AT GRIDS AND ARE APPROXIMATE. DATUM FOR ROOF ELEVATIONS IS 0'-0" AT FIRST FLOOR
- CONTRACTOR SHALL FIELD VERIFY ALL DIMENSIONS
- DEMOLISH ALL EXISTING ROOF ASSEMBLIES DOWN TO STRUCTURAL ROOF DECK (EXCEPT AT NIC ROOFS) AND PREPARE SUBSTRATE FOR NEW ROOF ASSEMBLY
- CONTRACTOR SHALL COORDINATE SITE ACCESS AND STAGING AREA WITH THE OWNER
- REFER TO STRUCTURAL, MECHANICAL AND ELECTRICAL SHEETS FOR RELATED DEMOLITION INFORMATION

ROOF PLAN GENERAL NOTES


CONTRACTOR SHALL COORDINATE AND MAINTAIN ADEQUATE DRAINAGE FROM ALL ROOFS DURING DEMOLITION AND CONSTRUCTION

	KEYNOTES
D4	DEMOLISH EXISTING METAL ROOFING DOWN TO EXISTING STRUCTURAL STEEL DECKING, INCLUDING FASCIA FLASHINGS. DO NOT COVER UNTIL STRUCTURAL DESIGNER OF RECORD INSPECTS EXPOSED STRUCTURAL DECKING
D6	VTR TO REMAIN, COORDINATE WITH NEW ROOF
D8	DEMOLISH EXISTING EPDM ROOFING, DRAINS, CRICKETS, AND PARAPETS IN THEIR ENTIRETY DOWN TO ORIGINAL STEEL ROOF DECK.
D10	EXISTING WALL MOUNT ANTENNA MAST. REMOVE AND SALVAGE FOR REINSTALLATION
D16	EXISTING ELECTRICAL WEATHERHEAD TO REMAIN

DEMOLITION ROOF LEGEND

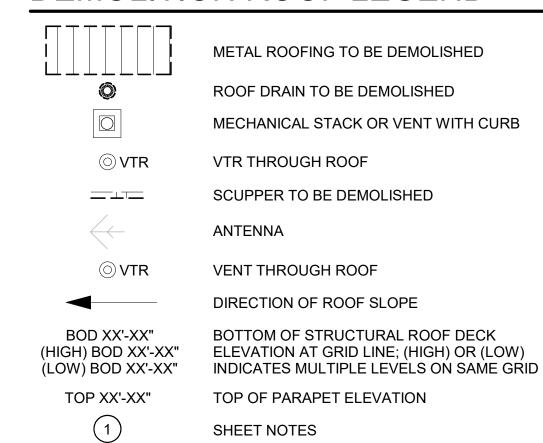


SHEET NOTES

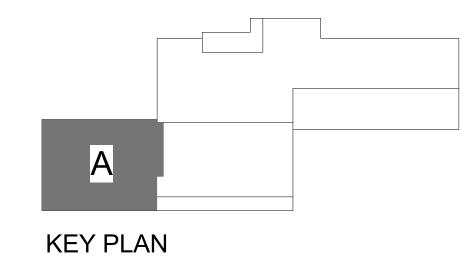



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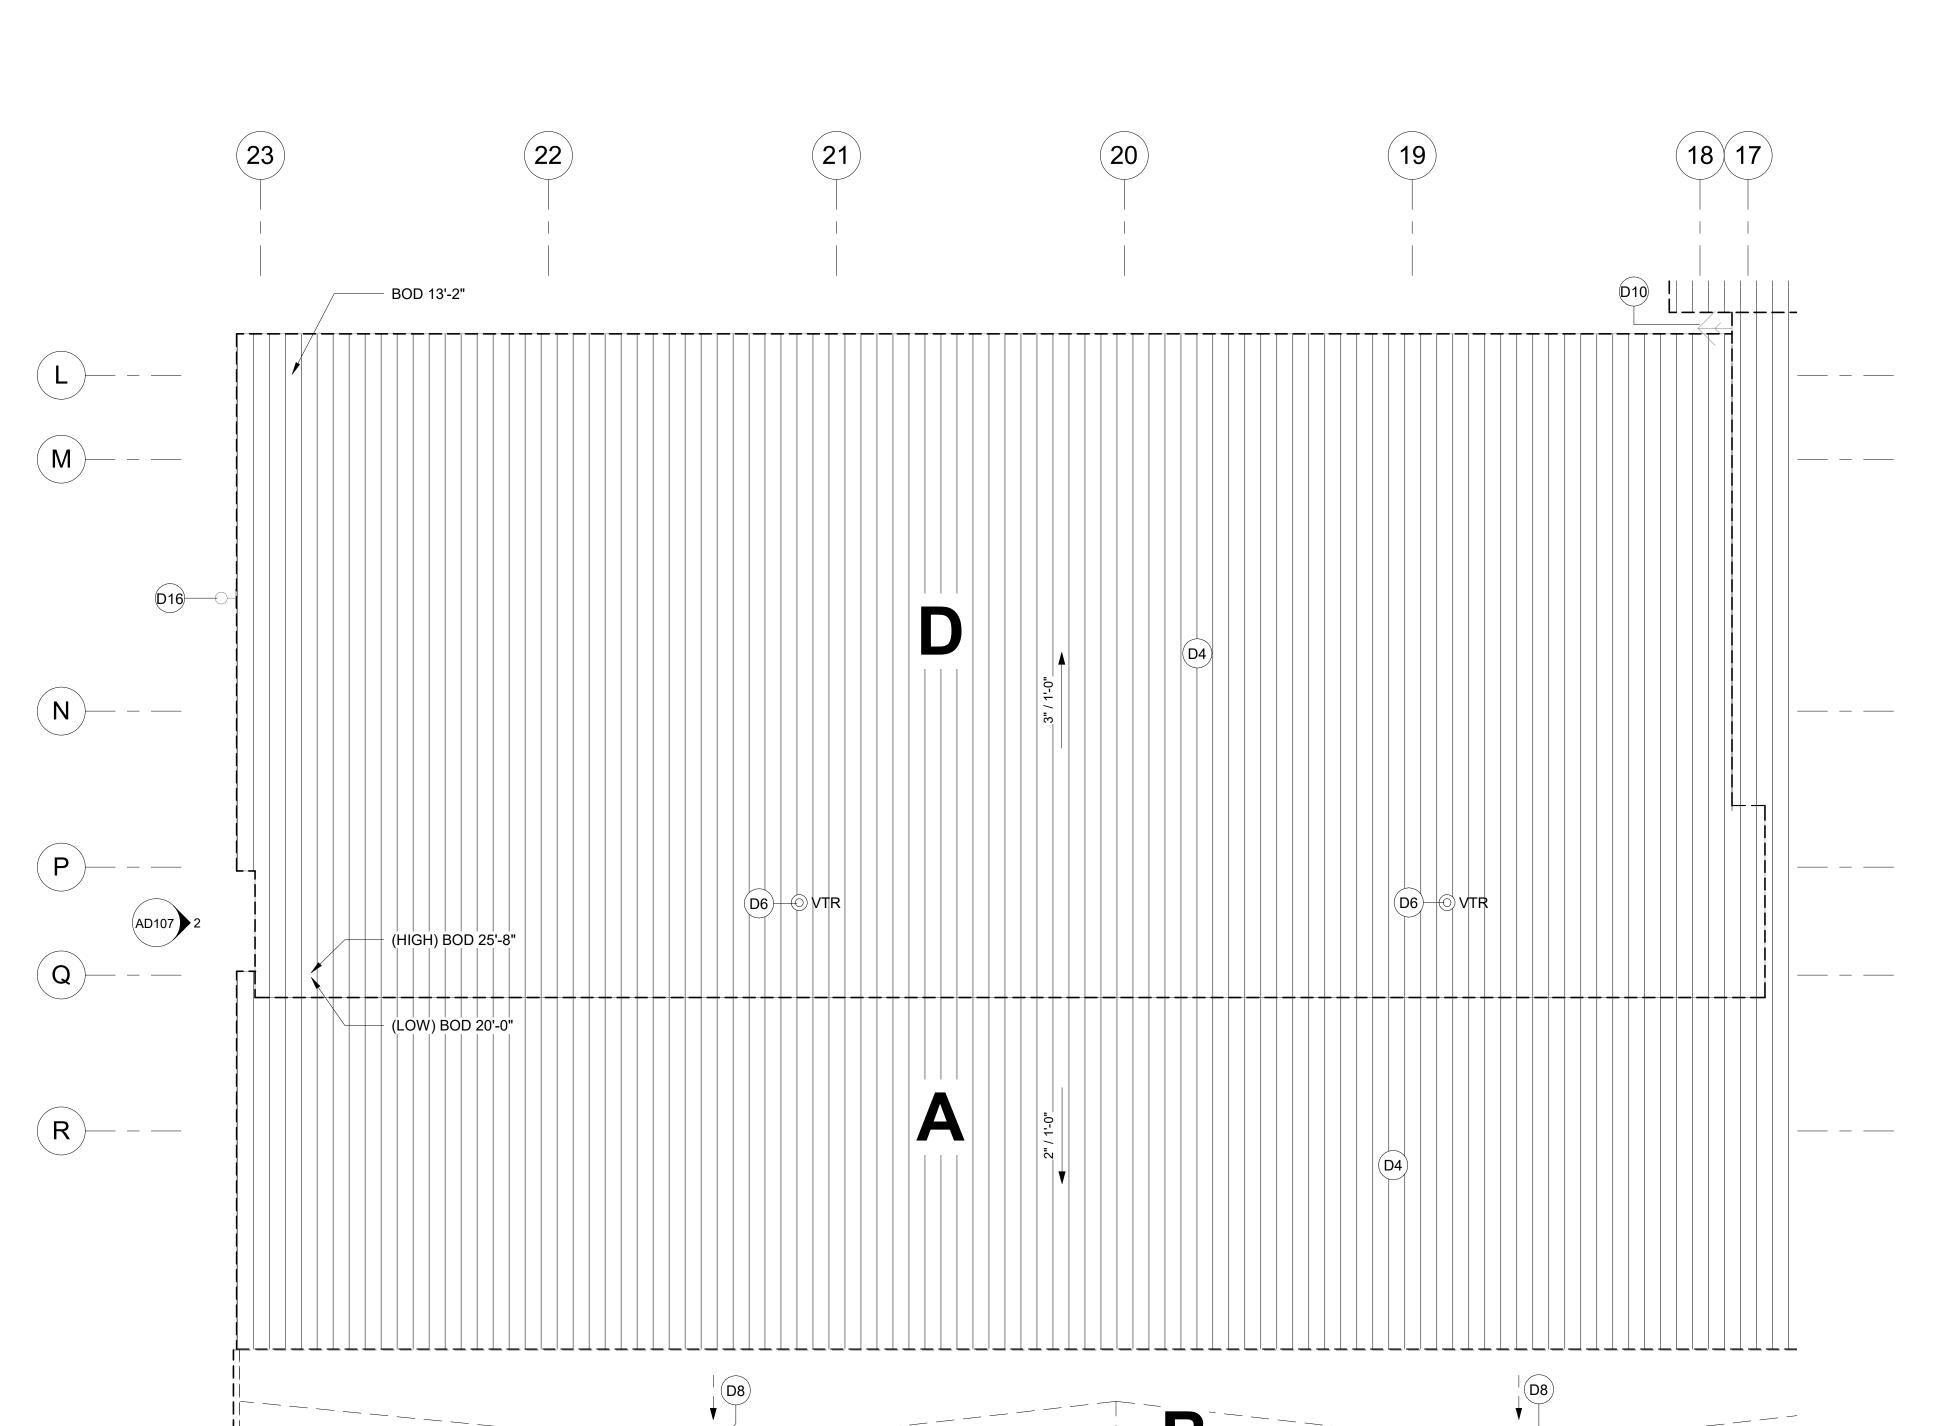
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REVIEWED BY:	-	
DEVISIONS:		

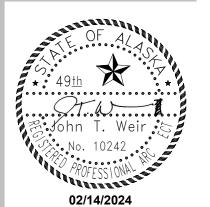DEMOLITION ROOF PLAN -AREA A

SHEET NO. **AD102**



S

BOD 13'-2"

DEMOLITION ROOF PLAN - AREA A

(D6)—(D1)VTR

(D6)|⊕ √TR

(Q)

S

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GENERAL NOTES-DEMOLITION

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- CONTRACTOR SHALL FIELD VERIFY ALL DIMENSIONS
- DEMOLISH ALL EXISTING ROOF ASSEMBLIES DOWN TO STRUCTURAL ROOF DECK (EXCEPT AT NIC ROOFS) AND PREPARE SUBSTRATE FOR NEW ROOF ASSEMBLY
- CONTRACTOR SHALL COORDINATE SITE ACCESS AND STAGING AREA WITH THE OWNER
- REFER TO STRUCTURAL, MECHANICAL AND ELECTRICAL SHEETS FOR RELATED DEMOLITION INFORMATION


ROOF PLAN GENERAL NOTES

CONTRACTOR SHALL COORDINATE DRAINAGE OF ALL ROOFS **DURING CONSTRUCTOIN**

KEYNOTES

D4	DEMOLISH EXISTING METAL ROOFING DOWN TO EXISTING STRUCTURAL STEEL DECKING, INCLUDING FASCIA FLASHINGS. DO NOT COVER UNTIL STRUCTURAL DESIGNER OF RECORD INSPECTS EXPOSED STRUCTURAL DECKING
D6	VTR TO REMAIN, COORDINATE WITH NEW ROOF
D8	DEMOLISH EXISTING EPDM ROOFING, DRAINS, CRICKETS, AND PARAPETS IN THEIR ENTIRETY DOWN TO ORIGINAL STEEL ROOF DECK.
D10	EXISTING WALL MOUNT ANTENNA MAST. REMOVE AND SALVAGE FOR REINSTALLATION

DEMOLITION ROOF LEGEND

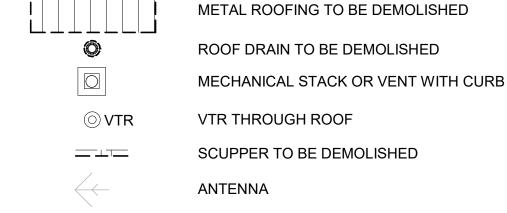


VENT THROUGH ROOF DIRECTION OF ROOF SLOPE

BOD XX'-XX" BOTTOM OF STRUCTURAL ROOF DECK (HIGH) BOD XX'-XX" ELEVATION AT GRID LINE; (HIGH) OR (LOW) (LOW) BOD XX'-XX" INDICATES MULTIPLE LEVELS ON SAME GRID


TOP XX'-XX" TOP OF PARAPET ELEVATION

1 SHEET NOTES

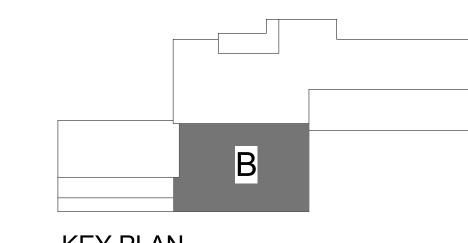



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ANCHORAGE SCHOOL DISTRICT

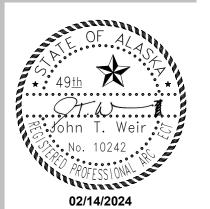Spring Hill Elementary **School Roof** Replacement


9911 Lake Otis Pkwy, Anchorage, AK 99507

100% BID DOCUMENTS

JOB NO. 2023017		
DATE:	02/14/2024	
PROJ. MGR.:	JTW	
DRAWN BY:	DD	
REVIEWED BY:	-	
REVISIONS:		

DEMOLITION ROOF PLAN -AREA B

> SHEET NO. **AD103**

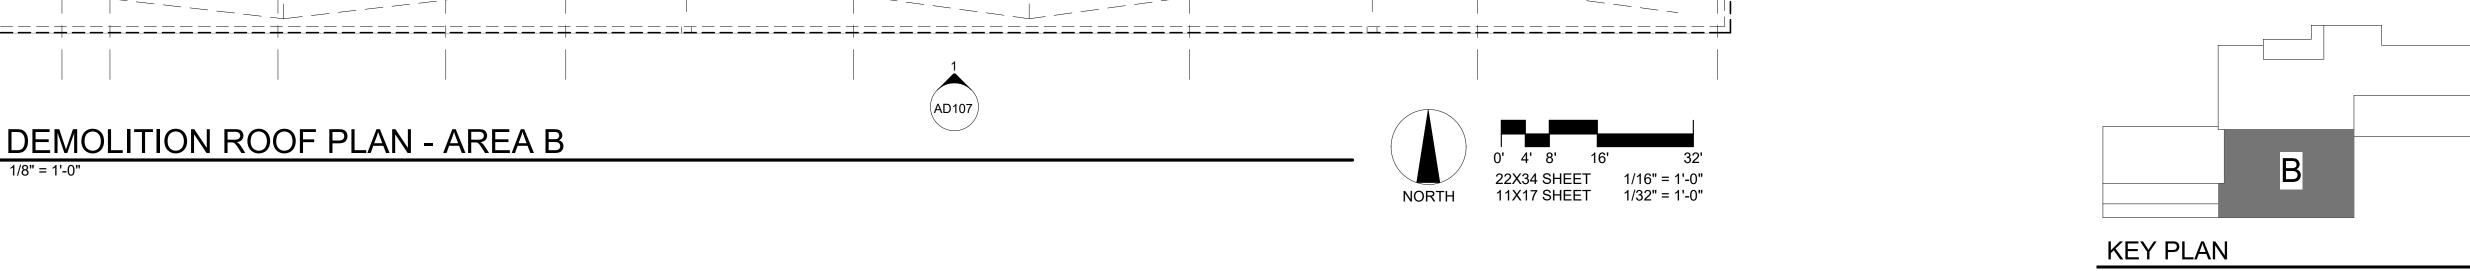

В

(D6) | VTR

9

(10)

(D1)

NOTIFICATION OF CHILD OCCUPIED FACILITY
PORTIONS OF THIS BUILDING ARE CLASSIFIED AS A CHILD
OCCUPIED FACILITY IN ACCORDANCE WITH 40 CFR 745 AND
LEAD-BASED PAINTS MAY BE PRESENT ON COMPONENTS TO BE
DISTURBED IN THOSE AREAS. PERSONNEL PERFORMING WORK
IN THESE AREAS MUST COMPLY WITH THE REQUIREMENTS OF 40
CFR 745, INCLUDING TRAINING, WORK PRACTICES AND
CLEANING OF THE WORK AREA. REFER TO SPECIFICATION
DIVISIONS 0, 1 AND 2 FOR SPECIFIC INFORMATION CONCERNING
DISTURBING, REMOVING AND DISPOSING OF LEAD MATERIALS
AND THE INSTALLATION OF NEW MATERIALS OR COMPONENTS.
THIS NOTIFICATION IS PROVIDED IN ACCORDANCE WITH EPA
AND OSHA REQUIREMENTS.

PERMIT STAMP

GENERAL NOTES-DEMOLITION

- THE INFORMATION SHOWN IN THIS DRAWING IS TAKEN FROM RECORD DRAWINGS AND A WALK-THRU OF THE EXISTING FACILITY. THERE IS NO WARRANTY OR GUARANTEE AS OF THE ACCURACY OF THE INFORMATION SHOWN. THE CONTRACTOR SHALL FIELD VERIFY CRITCAL ITEMS, AREA, AND ASSEMBLIES SHOWN FOR DEMOLITION PRIOR TO START OF WORK
- ROOF ELEVATIONS SHOWN INDICATE BOTTOM OF STRUCTURAL DECK AT GRIDS AND ARE APPROXIMATE. DATUM FOR ROOF ELEVATIONS IS 0'-0" AT FIRST FLOOR
- CONTRACTOR SHALL FIELD VERIFY ALL DIMENSIONS
- DEMOLISH ALL EXISTING ROOF ASSEMBLIES DOWN TO STRUCTURAL ROOF DECK (EXCEPT AT NIC ROOFS) AND PREPARE SUBSTRATE FOR NEW ROOF ASSEMBLY
- . CONTRACTOR SHALL COORDINATE SITE ACCESS AND STAGING AREA WITH THE OWNER
- REFER TO STRUCTURAL, MECHANICAL AND ELECTRICAL SHEETS FOR RELATED DEMOLITION INFORMATION

ROOF PLAN GENERAL NOTES

1. CONTRACTOR SHALL COORDINATE DRAINAGE OF ALL ROOFS DURING CONSTRUCTOIN

D1 SCUPPER TO REMAIN D2 ROOF DRAIN TO REMAIN D5 DEMOLISH ROOF CURB AND PENETRATION PER MECHANICAL D6 VTR TO REMAIN, COORDINATE WITH NEW ROOF D7 DEMOLISH EXISTING SMOKE DAMPERS AND HATCHES D10 EXISTING WALL MOUNT ANTENNA MAST. REMOVE AND SALVAGE FOR REINSTALLATION D12 EPDM ROOFING TO REMAIN

DEMOLITION ROOF LEGEND

D19 EXISTING VTR TO REMAIN

○ VTR

=

BOD XX'-XX" (HIGH) BOD XX'-XX" (LOW) BOD XX'-XX"

TOP XX'-XX"

1

ROOF DRAIN TO BE DEMOLISHED

ROOF DRAIN TO BE DEMOLISHED

MECHANICAL STACK OR VENT WITH C

MECHANICAL STACK OR VENT WITH CURB

VTR THROUGH ROOF

SCUPPER TO BE DEMOLISHED

ANTENNA


VENT THROUGH ROOF

DIRECTION OF ROOF SLOPE

BOTTOM OF STRUCTURAL ROOF DECK ELEVATION AT GRID LINE; (HIGH) OR (LOW) INDICATES MULTIPLE LEVELS ON SAME GRID

TOP OF PARAPET ELEVATION

SHEET NOTES

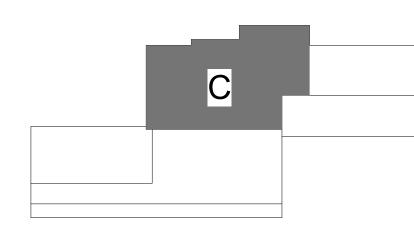

KEY PLAN


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ANCHORAGE SCHOOL DISTRICT

Spring Hill Elementary School Roof Replacement

9911 Lake Otis Pkwy,

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JOB NO.	2023017
DATE:	02/14/2024
PROJ. MGR.:	JTW
DRAWN BY:	DD
REVIEWED BY:	-
DEVISIONS:	

DEMOLITION ROOF PLAN -AREA C

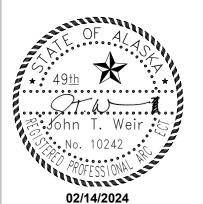SHEET NO.

AD104

DEMOLITION ROOF PLAN - AREA C

AD104 1/8" = 1'-0"

16

B,

(C)

(D)

 (E)

 (F)

G

 $\left(\mathsf{H}\right)$

(K)-

(15)

14

 $(D6)+\bigcirc VTR$


|(D6)||⊙|V|TR|

13)

D12



(D6) VTR

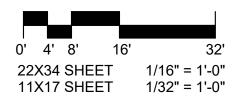

 \square \square \square \square \square \square \square \square

NOTIFICATION OF CHILD OCCUPIED FACILITY PORTIONS OF THIS BUILDING ARE CLASSIFIED AS A CHILD OCCUPIED FACILITY IN ACCORDANCE WITH 40 CFR 745 AND LEAD-BASED PAINTS MAY BE PRESENT ON COMPONENTS TO BE DISTURBED IN THOSE AREAS. PERSONNEL PERFORMING WORK IN THESE AREAS MUST COMPLY WITH THE REQUIREMENTS OF 40 CFR 745, INCLUDING TRAINING, WORK PRACTICES AND CLEANING OF THE WORK AREA. REFER TO SPECIFICATION DIVISIONS 0, 1 AND 2 FOR SPECIFIC INFORMATION CONCERNING DISTURBING, REMOVING AND DISPOSING OF LEAD MATERIALS AND THE INSTALLATION OF NEW MATERIALS OR COMPONENTS. THIS NOTIFICATION IS PROVIDED IN ACCORDANCE WITH EPA AND OSHA REQUIREMENTS.

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02/14/2024

ANCHORAGE

Spring Hill

Elementary

School Roof

Replacement

9911 Lake Otis Pkwy, Anchorage, AK 99507

> 2023017 02/14/2024

> > DD

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JOB NO.

PROJ. MGR.:

DRAWN BY:

REVIEWED BY: REVISIONS:

SCHOOL DISTRICT

DESIGN

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FOR:

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GENERAL NOTES-DEMOLITION

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- AREA WITH THE OWNER


KEY PLAN

SHEET NO.

AD105

DEMOLITION ROOF PLAN -

AREA D

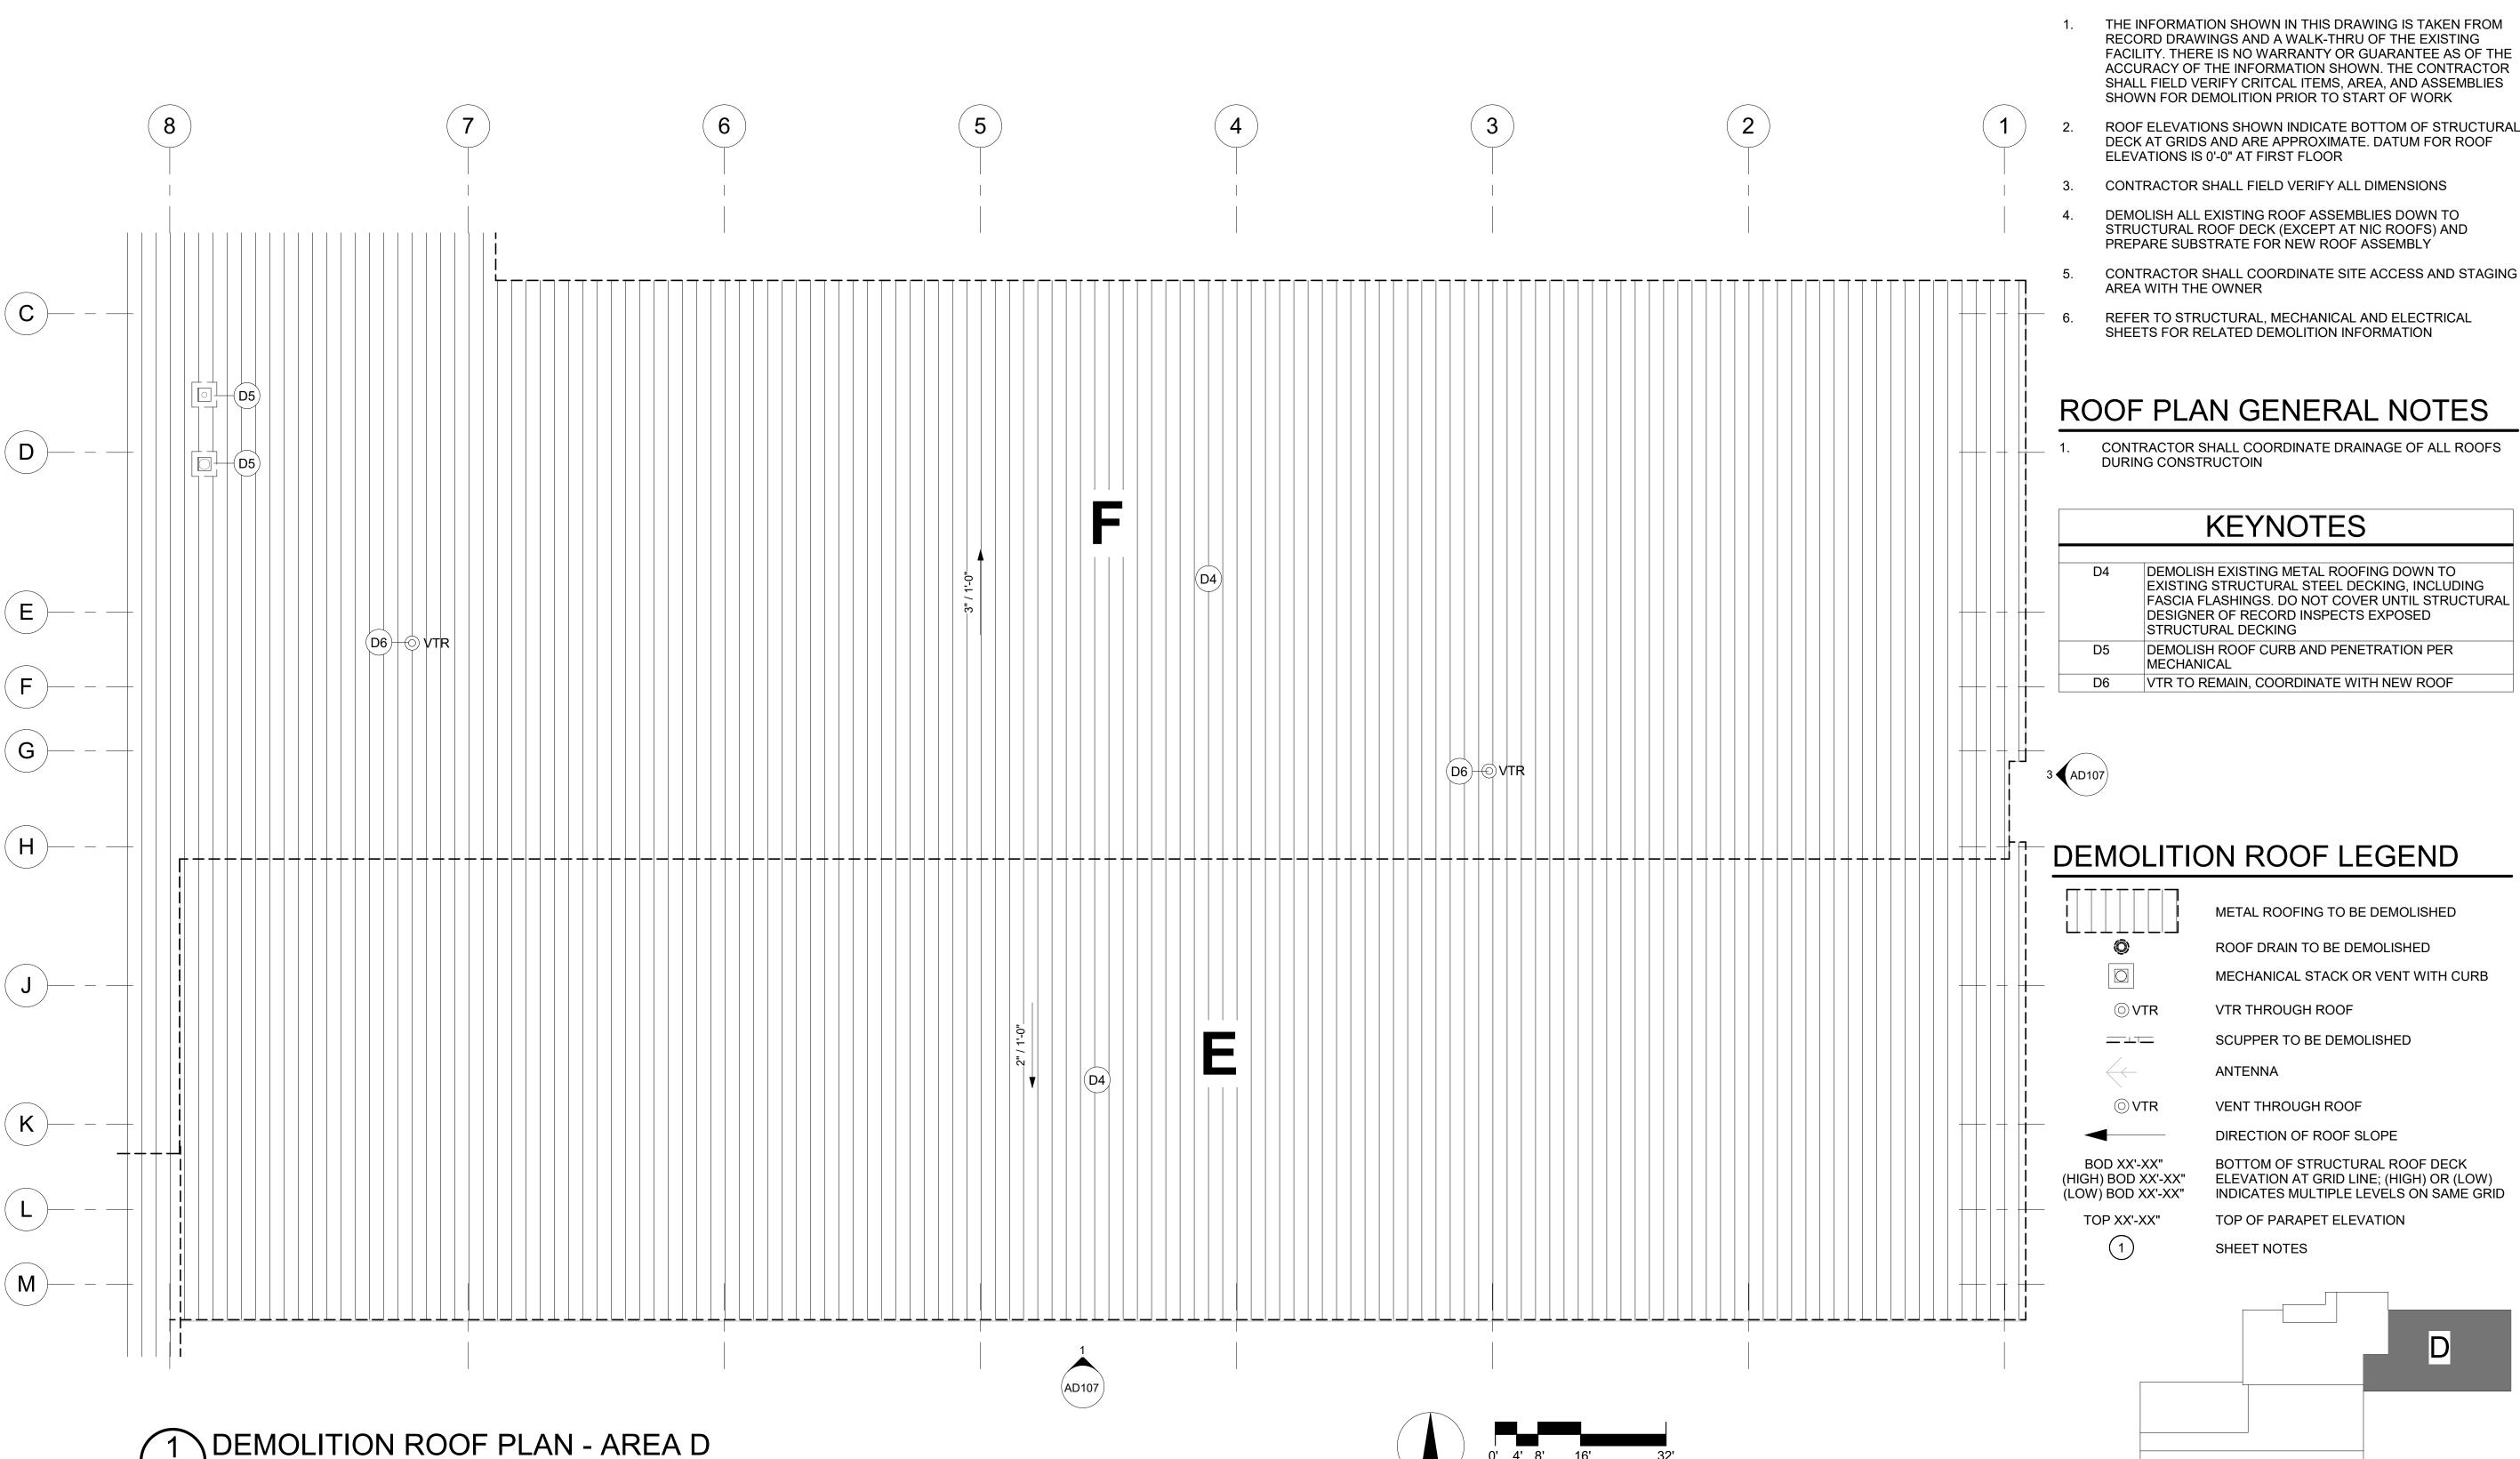

11X17 SHEET

1/32" = 1'-0"


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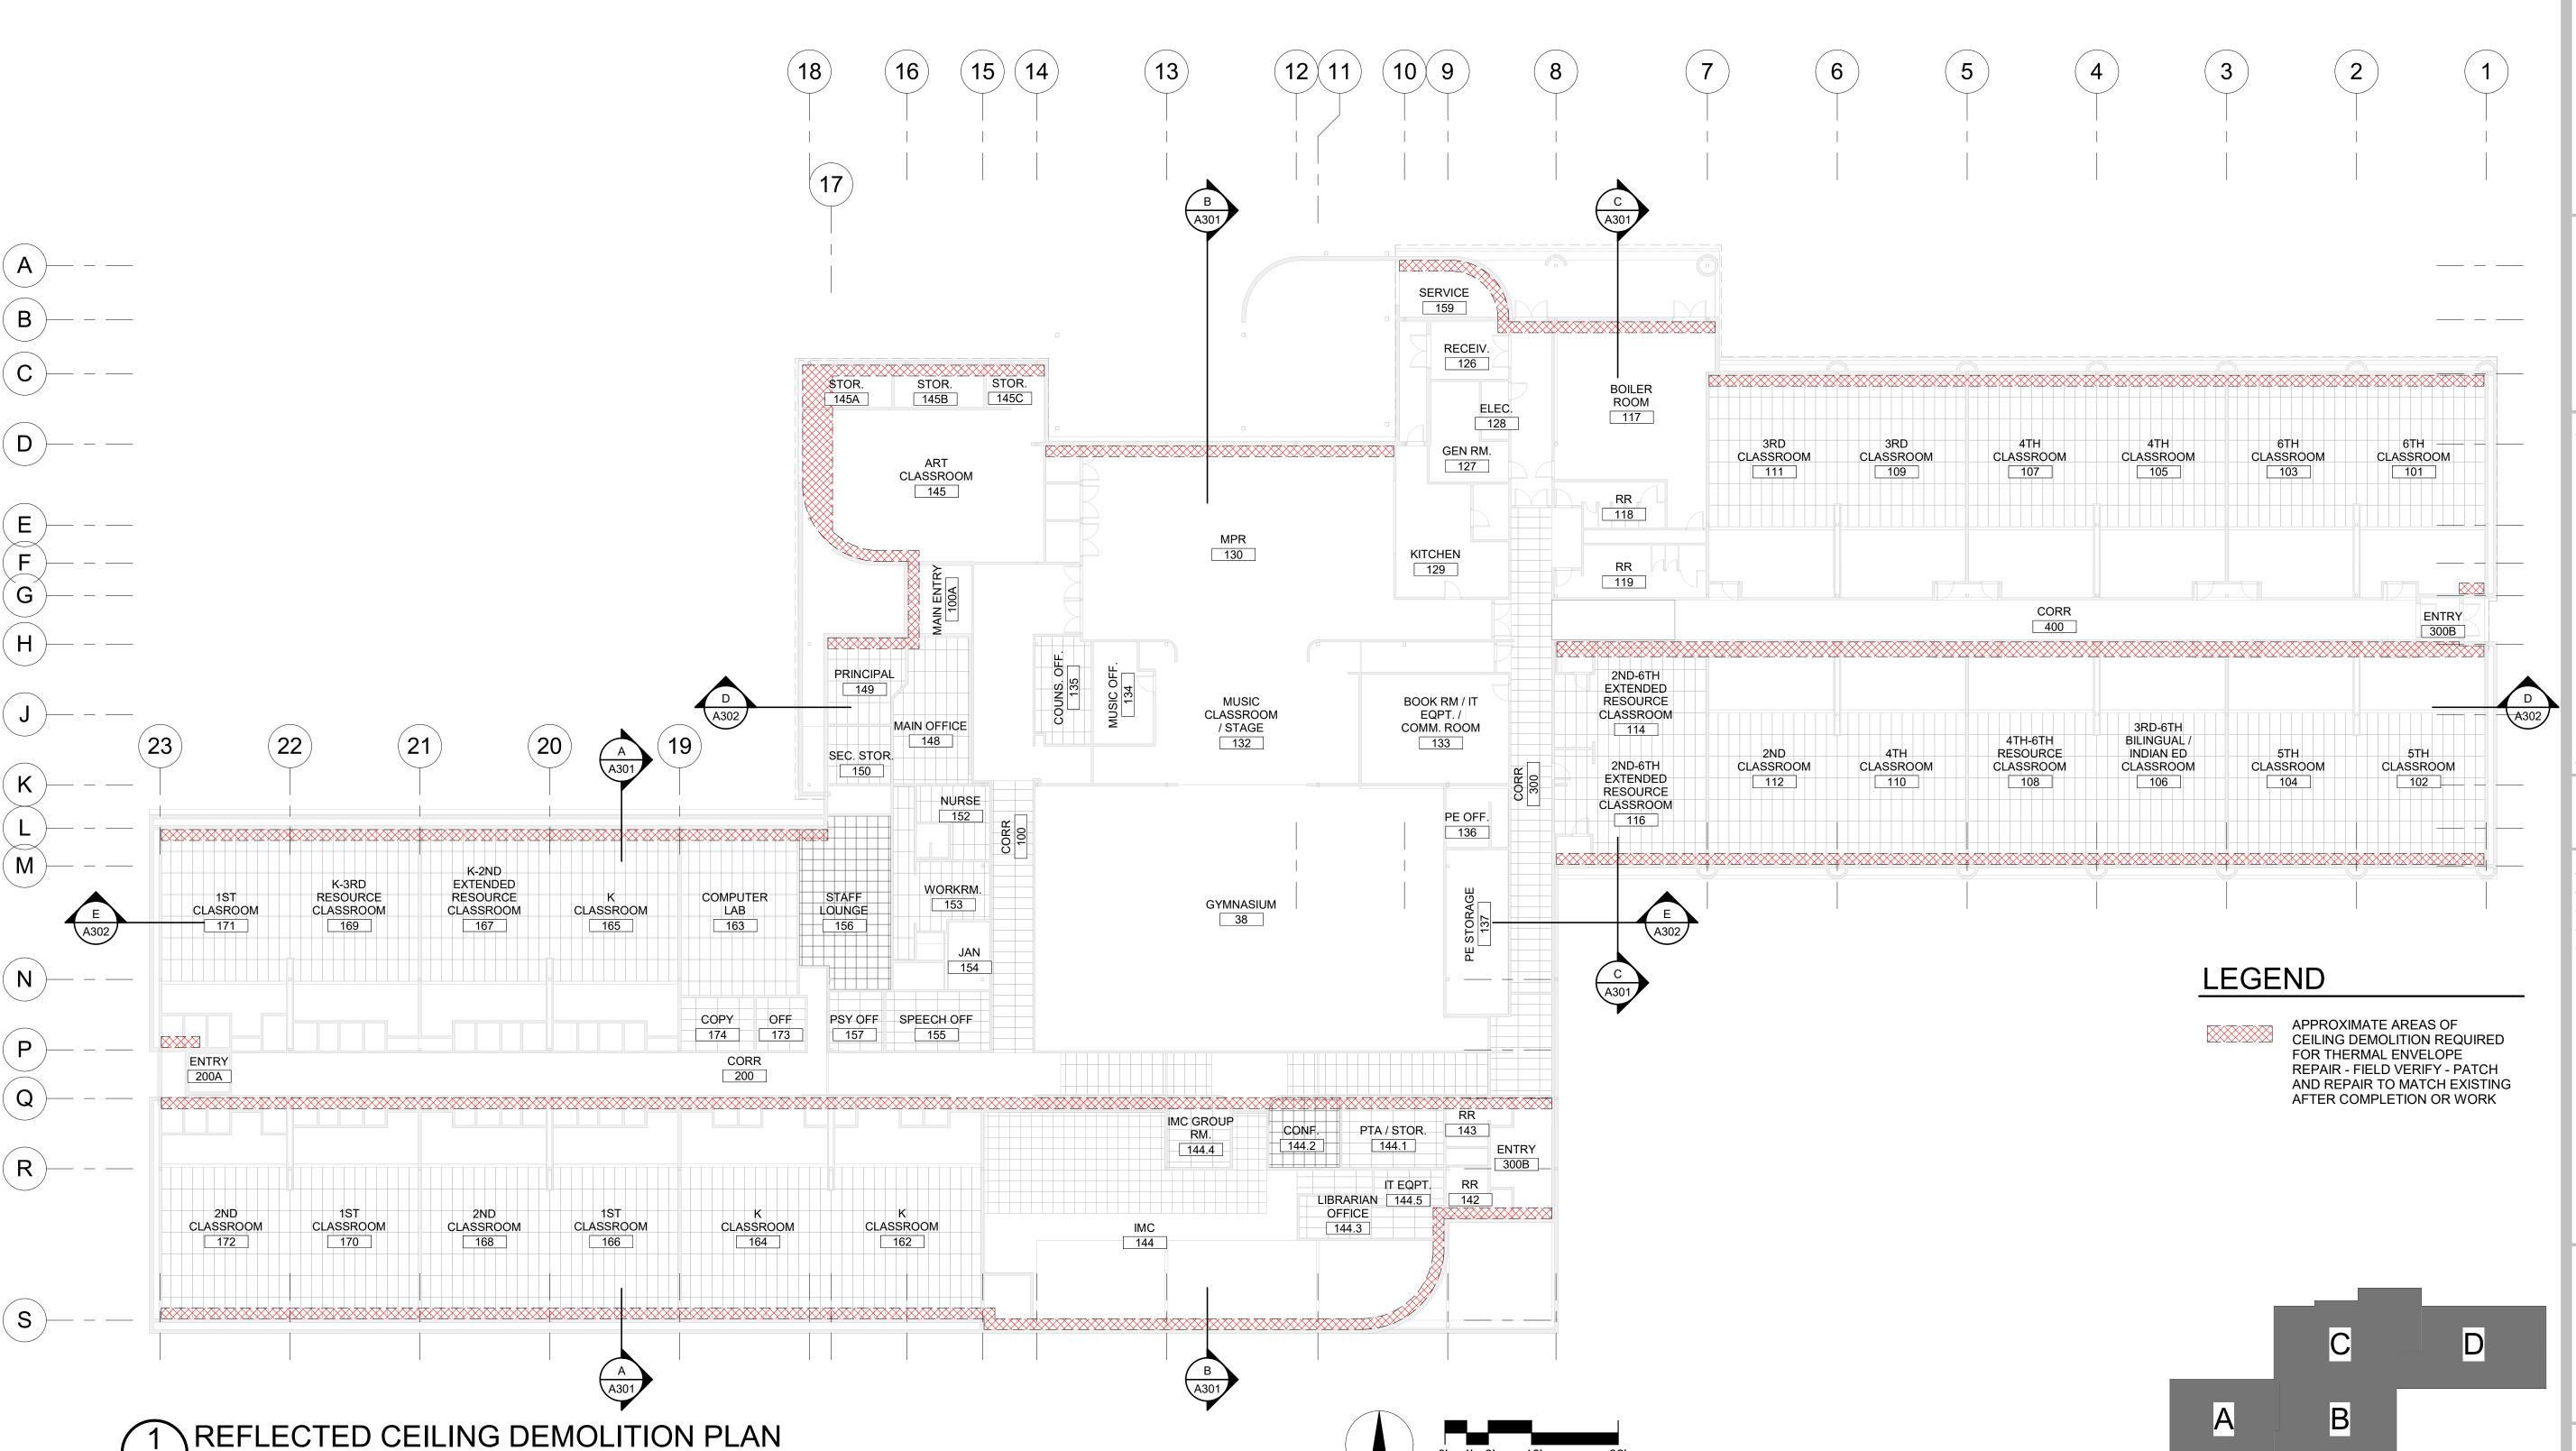
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KEY PLAN






22X34 SHEET


11X17 SHEET 1/32" = 1'-0"

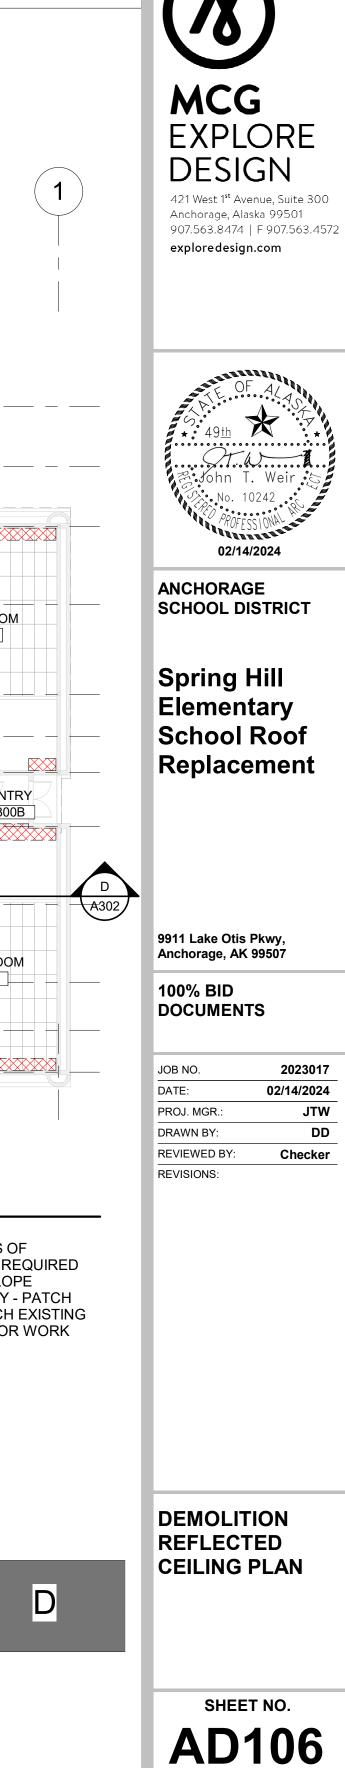1/16" = 1'-0"


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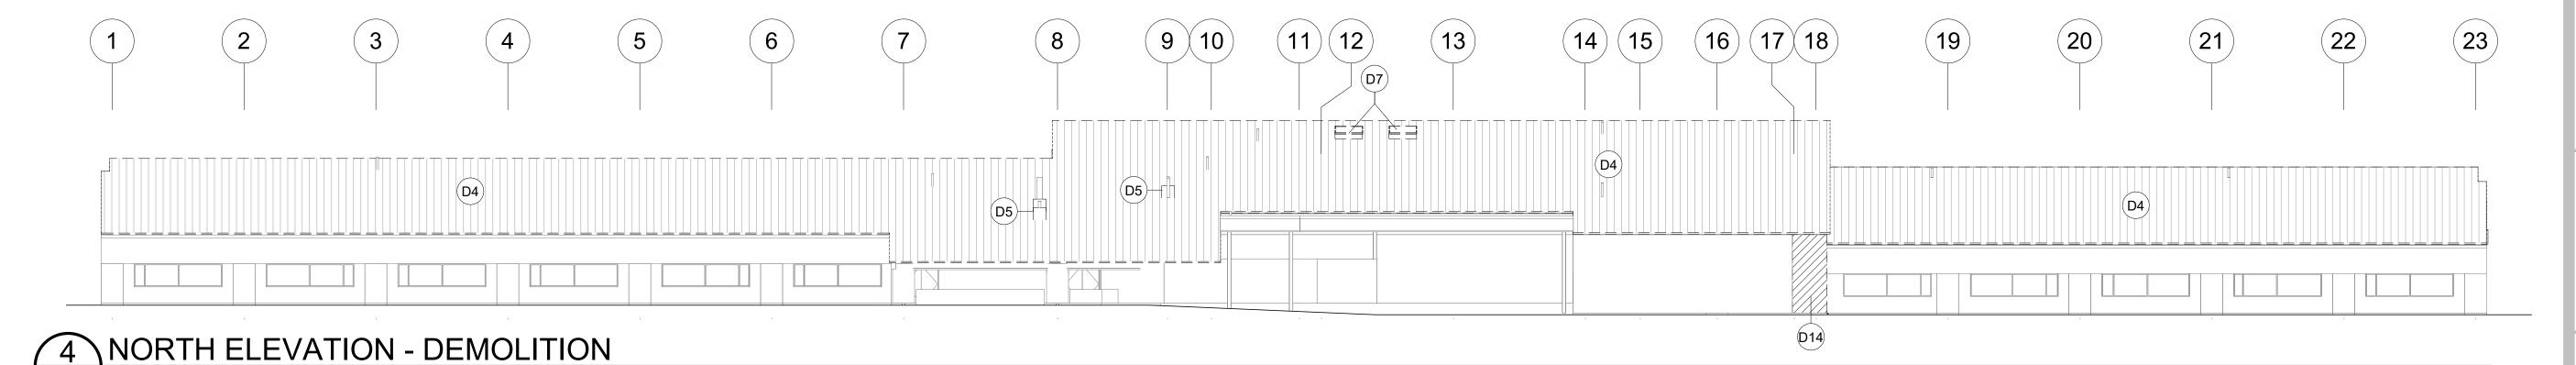


1 SOUTH ELEVATION - DEMOLITION 1/16" = 1'-0"

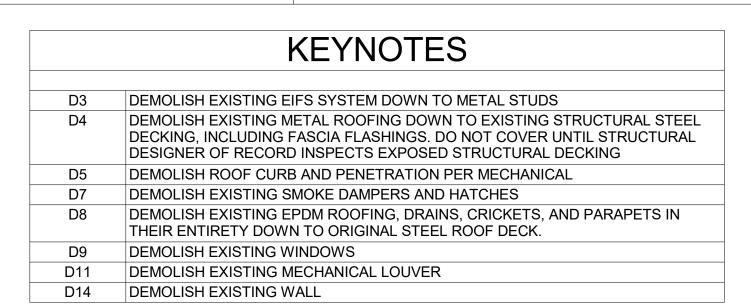

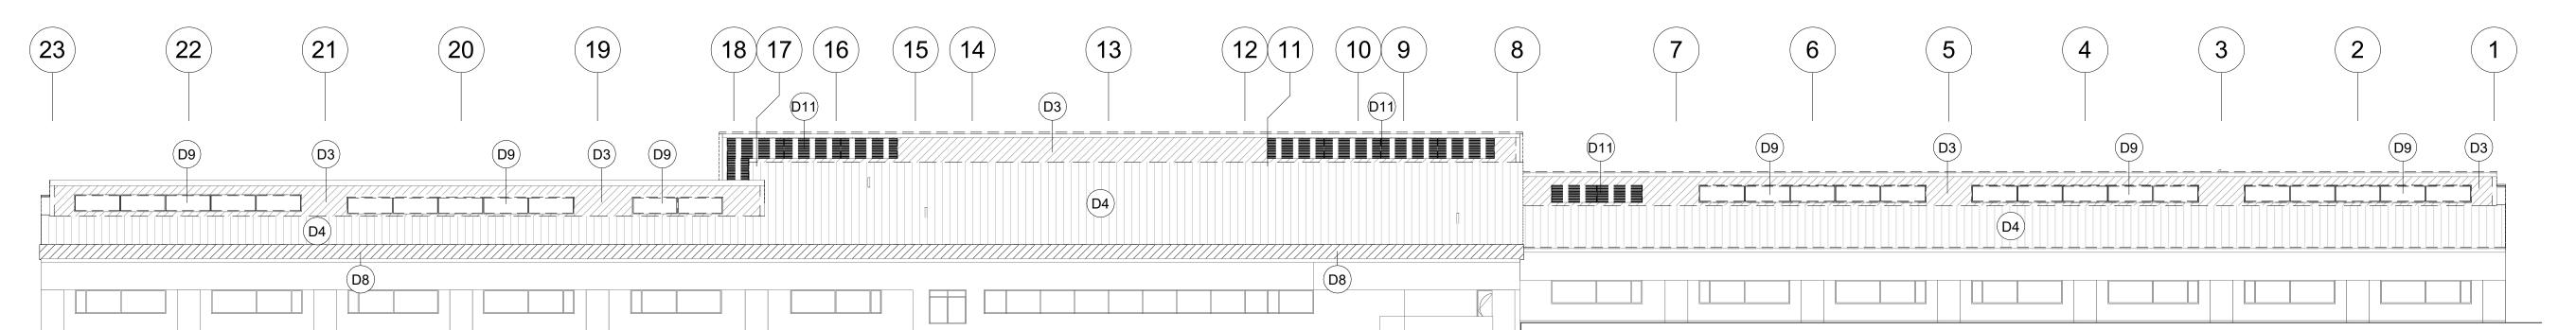2 WEST ELEVATION - DEMOLITION




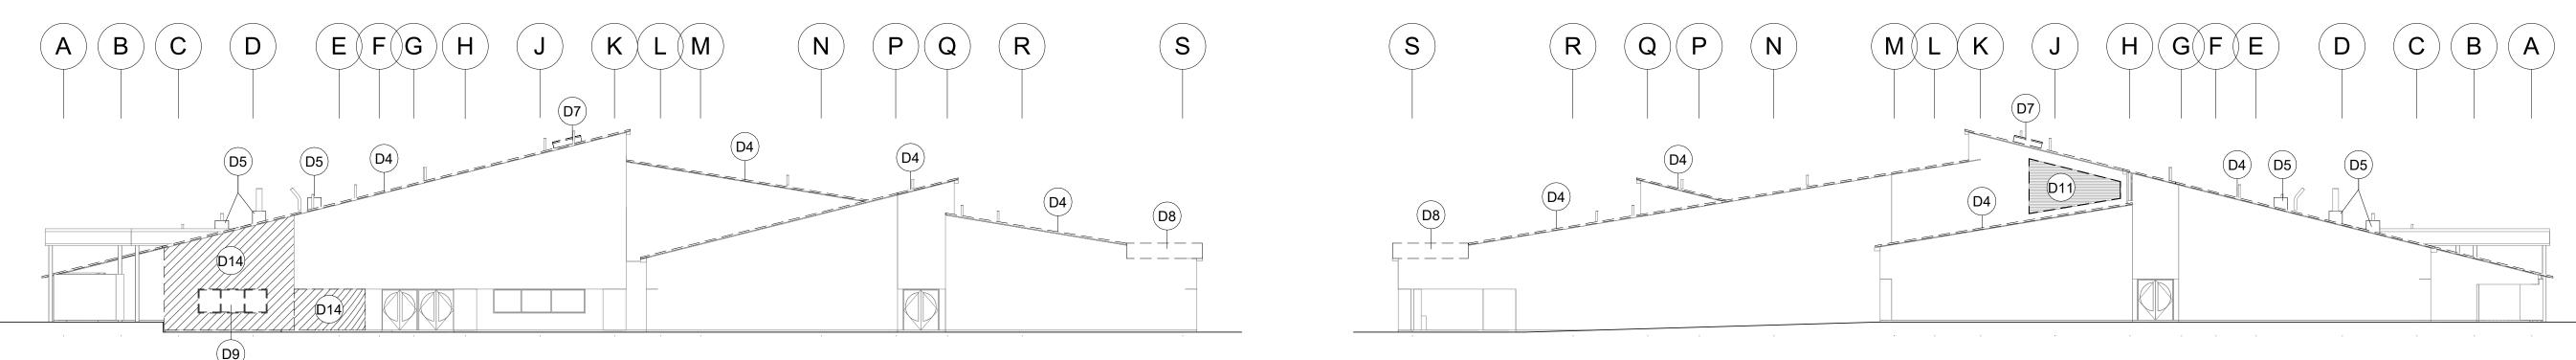

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ANCHORAGE SCHOOL DISTRICT

Spring Hill Elementary School Roof Replacement

9911 Lake Otis Pkwy, Anchorage, AK 99507

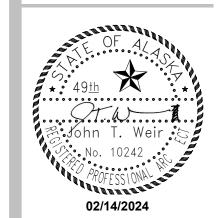100% BID DOCUMENTS

2023017	JOB NO.
02/14/2024	DATE:
JTW	PROJ. MGR.:
DD	DRAWN BY:
Checker	REVIEWED BY:
	REVISIONS:

DEMOLITION ELEVATIONS

SHEET NO.
AD107

16' - 0"

8

28' - 0"

\A301

20' - 0"

(13)

24' - 0"

A301

24' - 0"

15)

14' - 0" | 10' - 0" |

4' - 0"/ 14' - 0"

(15)

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6

24' - 0"

24' - 0"

5

24' - 0"

24' - 0"

PERMIT STAMP

24' - 0"

2

24' - 0"



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ANCHORAGE SCHOOL DISTRICT

Spring Hill Elementary School Roof Replacement


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PROJ. MGR.:	JTW
DRAWN BY:	DD
REVIEWED BY:	-
REVISIONS:	

REFERENCE FIRST FLOOR PLAN

> SHEET NO. A001



NOTIFICATION OF POTENTIAL HAZARD NOTIFICATION OF CHILD OCCUPIED FACILITY ASBESTOS, LEAD AND OTHER POTENTIALLY HAZARDOUS MATERIALS ARE PORTIONS OF THIS BUILDING ARE CLASSIFIED AS A CHILD SUBMITTAL PRESENT IN THE BUILDING THAT MAY IMPACT THE WORK OF ALL TRADES. OCCUPIED FACILITY IN ACCORDANCE WITH 40 CFR 745 AND PRICING REGULATED AIR CONTAMINANTS, INCLUDING ASBESTOS AND LEAD, ARE ALSO LEAD-BASED PAINTS MAY BE PRESENT ON COMPONENTS TO BE PRESENT IN SETTLED AND CONCEALED DUST IN AND ON ARCHITECTURAL, DISTURBED IN THOSE AREAS. PERSONNEL PERFORMING WORK IN THESE AREAS MUST COMPLY WITH THE REQUIREMENTS OF 40 STRUCTURAL, MECHANICAL AND ELECTRICAL COMPONENTS OR SYSTEMS THROUGHOUT THE BUILDING. ALL TRADES SHALL COORDINATE WITH OTHER CFR 745, INCLUDING TRAINING, WORK PRACTICES AND TRADES AND CONDUCT THEIR WORK TO PREVENT WORKER EXPOSURE OR CLEANING OF THE WORK AREA. REFER TO SPECIFICATION DIVISIONS 0, 1 AND 2 FOR SPECIFIC INFORMATION CONCERNING SITE CONTAMINATION. REFER TO SPECIFICATION DIVISIONS 0, 1 AND 2 FOR SPECIFIC INFORMATION CONCERNING DISTURBING, REMOVING AND DISTURBING, REMOVING AND DISPOSING OF LEAD MATERIALS DISPOSING OF THESE MATERIALS AND THE INSTALLATION OF NEW MATERIALS AND THE INSTALLATION OF NEW MATERIALS OR COMPONENTS. OR COMPONENTS. THIS NOTIFICATION IS PROVIDED IN ACCORDANCE WITH THIS NOTIFICATION IS PROVIDED IN ACCORDANCE WITH EPA PERMIT STAMP EPA AND OSHA REQUIREMENTS. AND OSHA REQUIREMENTS. (13) 5 8 2 64' - 3" +/-143' - 5" +/-60' - 2" +/-421 West 1st Avenue, Suite 300 $\begin{pmatrix} 1 \\ A104 \end{pmatrix}$ Anchorage, Alaska 99501 907.563.8474 | F 907.563.4572 explore design.com A301 SNOW GUARDS, **TYPICAL ANCHORAGE** Spring Hill ⊚ VTR © VTR 9911 Lake Otis Pkwy, Anchorage, AK 99507 100% BID DOCUMENTS 173' - 7" +/-LEGEND REVISIONS: SCUPPER 1 A103 **ROOF DRAIN** VENT THROUGH ROOF - SEE 8/A504 DIRECTION OF ROOF SLOPE ANTENNA MAST ELECTRICAL WEATHERHEAD SNOW GUARDS MECHANICAL STACK OR EXHAUST -SEE 7/A504 PLAN B A301 C 22X34 SHEET 11X17 SHEET 1/16" = 1'-0" 1/32" = 1'-0" NORTH

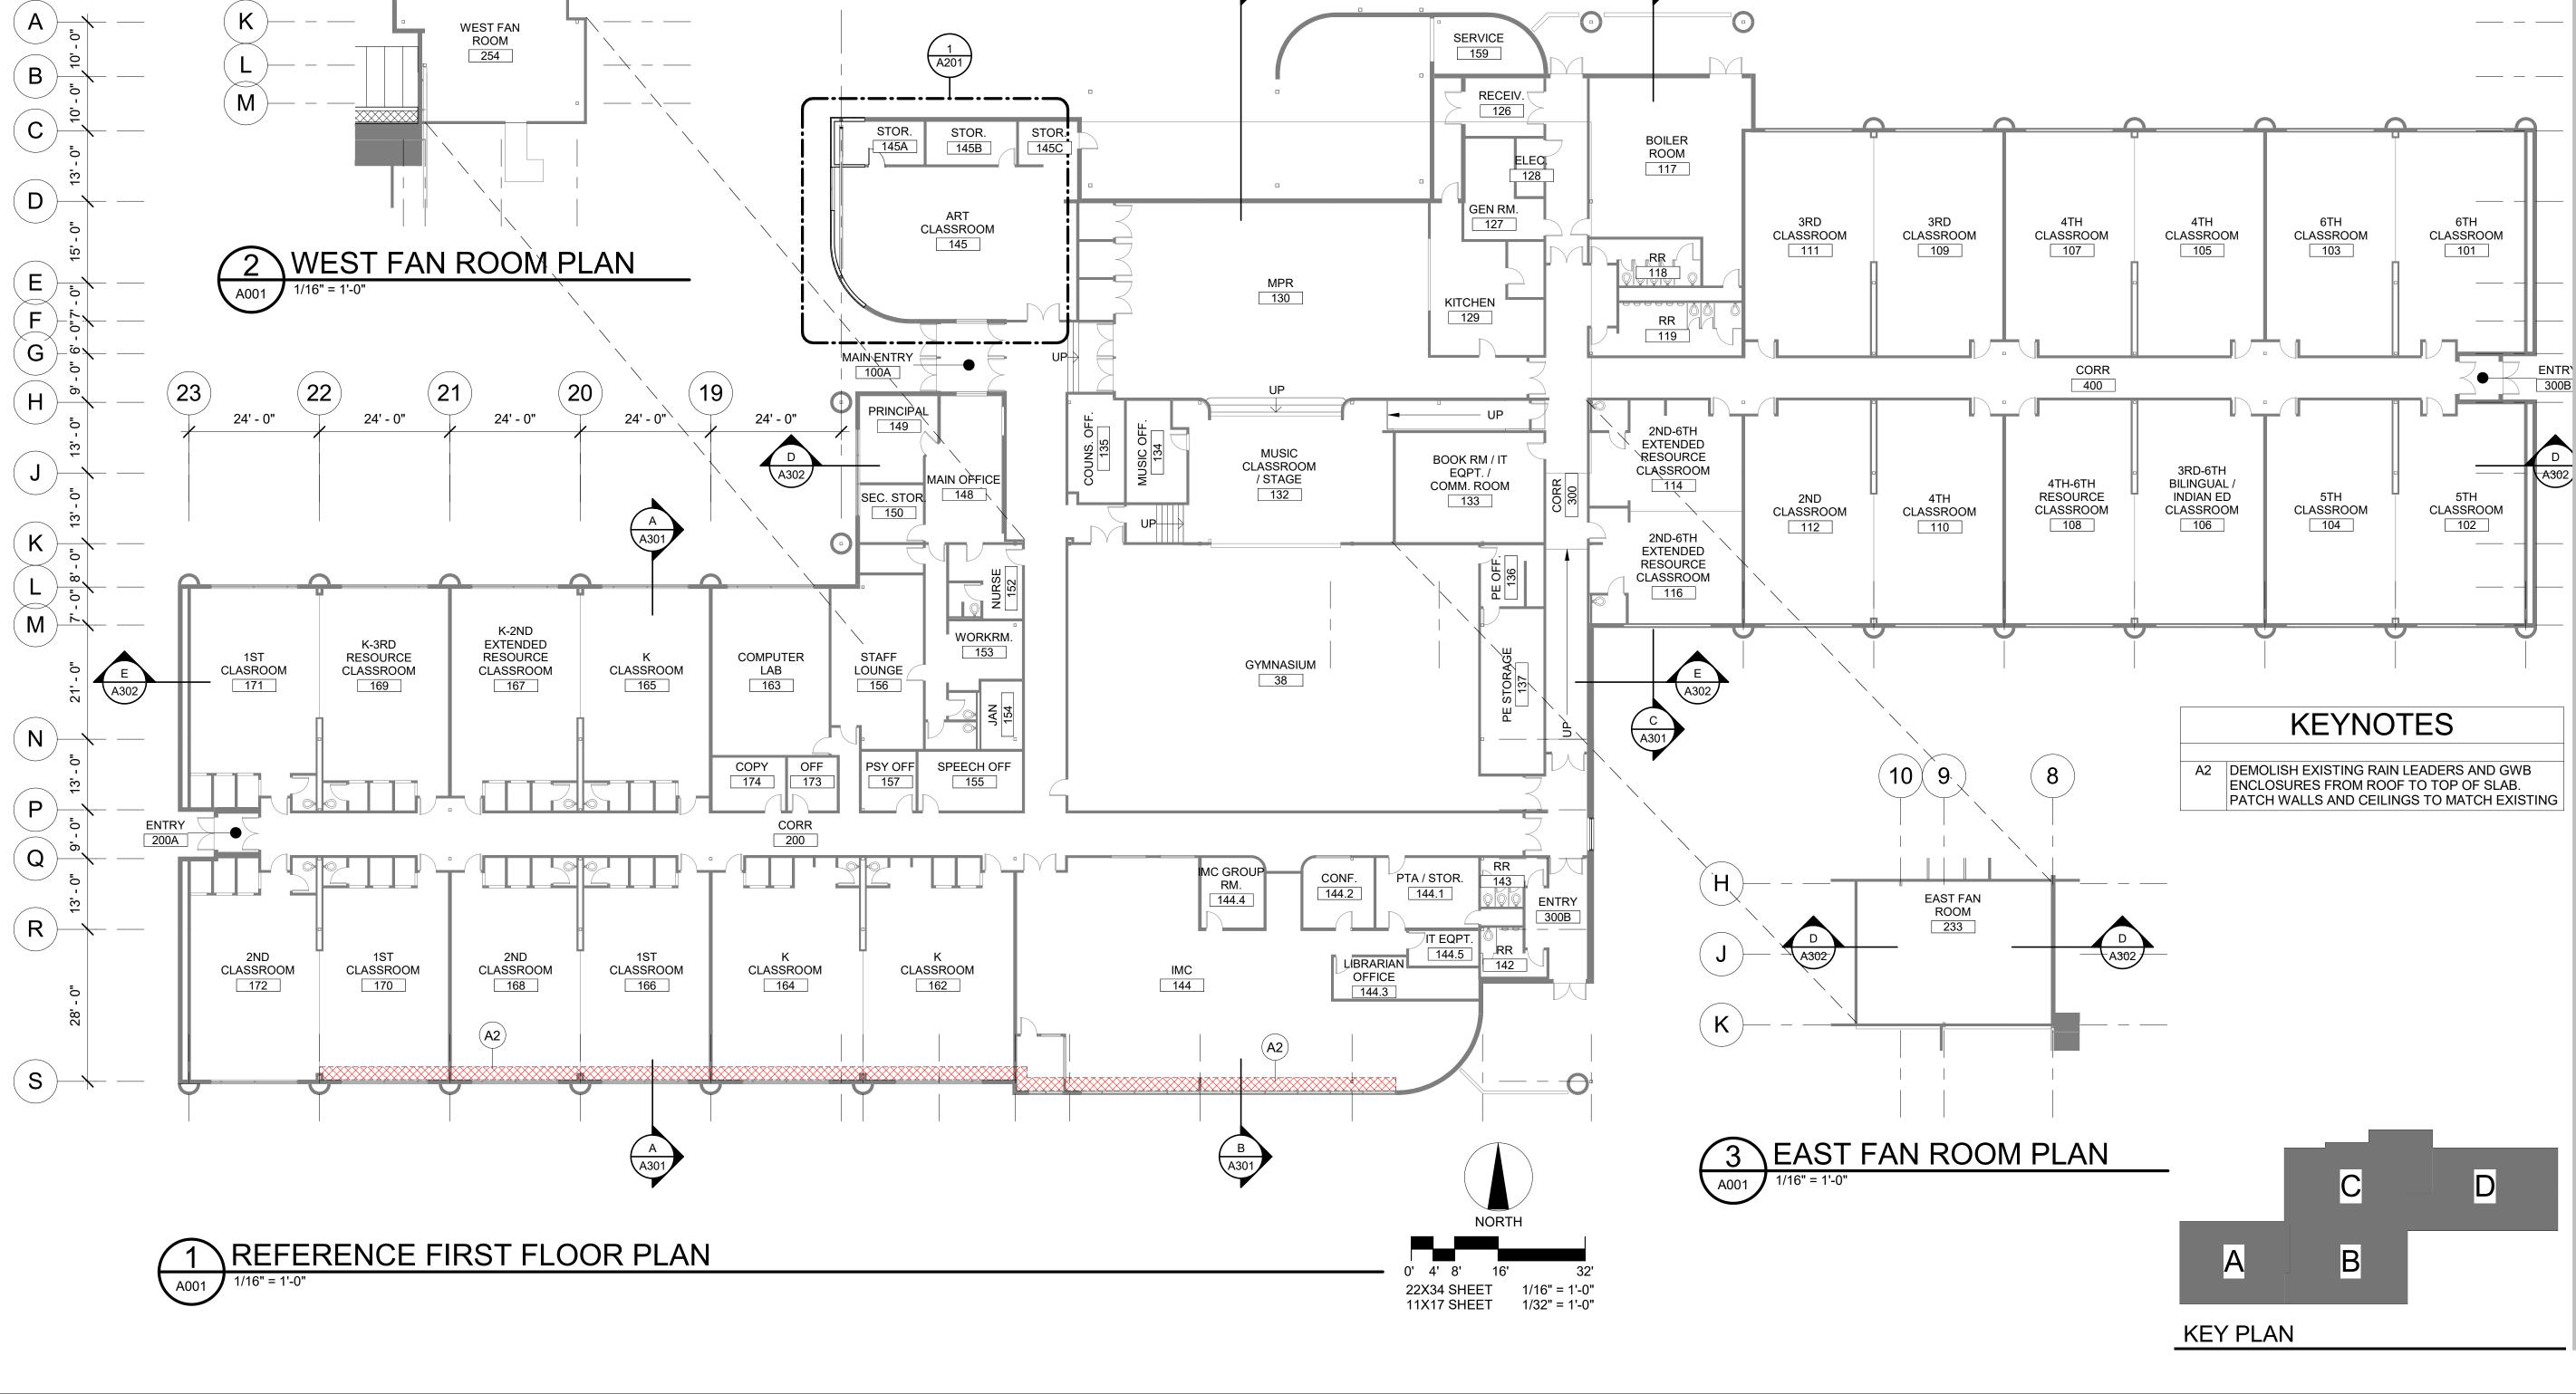(16)

SNOW GUARD

D A302

_⊚ VTR

A102

⊚ VTR

OVERALL ROOF PLAN

(22)

G

M

N

P

(Q)

R

S

46' - 2" +/-

(15)


<u></u> ⊚ VTR

_⊚ VTR

⊚ VTR

260' - 6" +/-

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SCHOOL DISTRICT

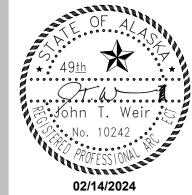Elementary **School Roof** Replacement

OB NO.	2023017
DATE:	02/14/2024
PROJ. MGR.:	JTW
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REVIEWED BY:	-

OVERALL ROOF

SHEET NO. A101

KEY PLAN

24' - 0"

A301

24' - 0"

(20)

(A8)

24' - 0"


NOTIFICATION OF CHILD OCCUPIED FACILITY PORTIONS OF THIS BUILDING ARE CLASSIFIED AS A CHILD OCCUPIED FACILITY IN ACCORDANCE WITH 40 CFR 745 AND LEAD-BASED PAINTS MAY BE PRESENT ON COMPONENTS TO BE DISTURBED IN THOSE AREAS. PERSONNEL PERFORMING WORK IN THESE AREAS MUST COMPLY WITH THE REQUIREMENTS OF 40 CFR 745, INCLUDING TRAINING, WORK PRACTICES AND CLEANING OF THE WORK AREA. REFER TO SPECIFICATION DIVISIONS 0, 1 AND 2 FOR SPECIFIC INFORMATION CONCERNING DISTURBING, REMOVING AND DISPOSING OF LEAD MATERIALS AND THE INSTALLATION OF NEW MATERIALS OR COMPONENTS. THIS NOTIFICATION IS PROVIDED IN ACCORDANCE WITH EPA AND OSHA REQUIREMENTS.


22X34 SHEET 11X17 SHEET

PERMIT STAMP


ROOF PLAN GENERAL NOTES

CONTRACTOR SHALL COORDINATE DRAINAGE OF ALL ROOFS DURING CONSTRUCTOIN

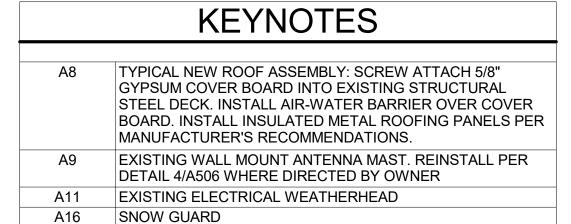

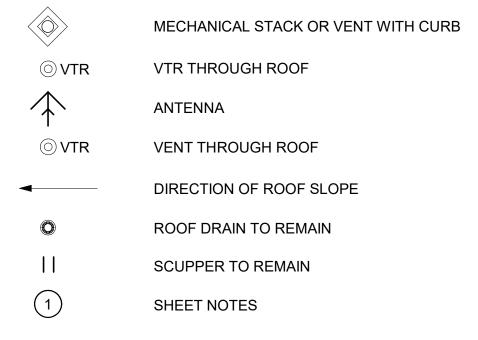

ROOF PLAN LEGEND

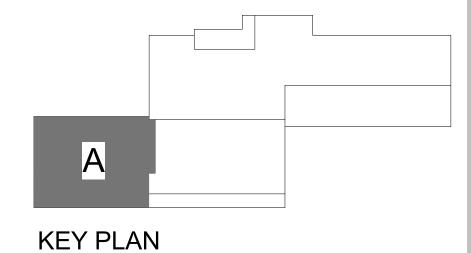

ROOF PLAN -AREA A

> SHEET NO. A102

A302 (P)© VTR | A16 A16 1 A501

24' - 0"

24' - 0"

ROOF PLAN - AREA A

Q

(R)

 $s \rightarrow$

A504

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02/14/2024

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DRAWN BY:	DD
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REVISIONS:	

16' - 0"

A502

(12)(11)

4' - 0"

24' - 0"

A301

(9)

20' - 0"

22X34 SHEET 11X17 SHEET 1/16" = 1'-0" 1/32" = 1'-0"

[10]

NOTIFICATION OF CHILD OCCUPIED FACILITY
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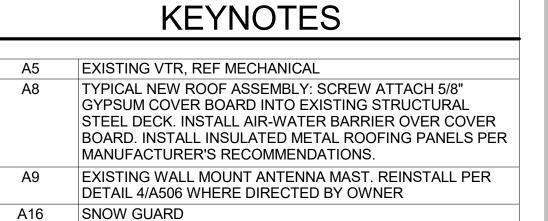
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ANCHORAGE SCHOOL DISTRICT

Spring Hill Elementary School Roof Replacement

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ROOF PLAN -


SHEET NO.


A103

AREA B

ROOF PLAN LEGEND

MECHANICAL STACK OR VENT WITH CURB
 ○ VTR
 ○ VTR
 VENT THROUGH ROOF
 ✓ DIRECTION OF ROOF SLOPE
 © ROOF DRAIN TO REMAIN
 II SCUPPER TO REMAIN
 ① SHEET NOTES

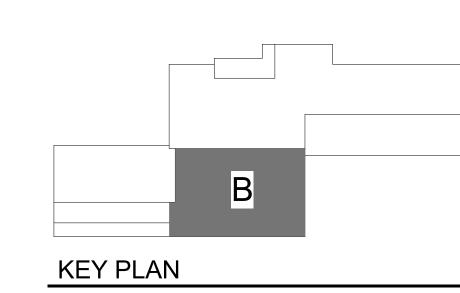

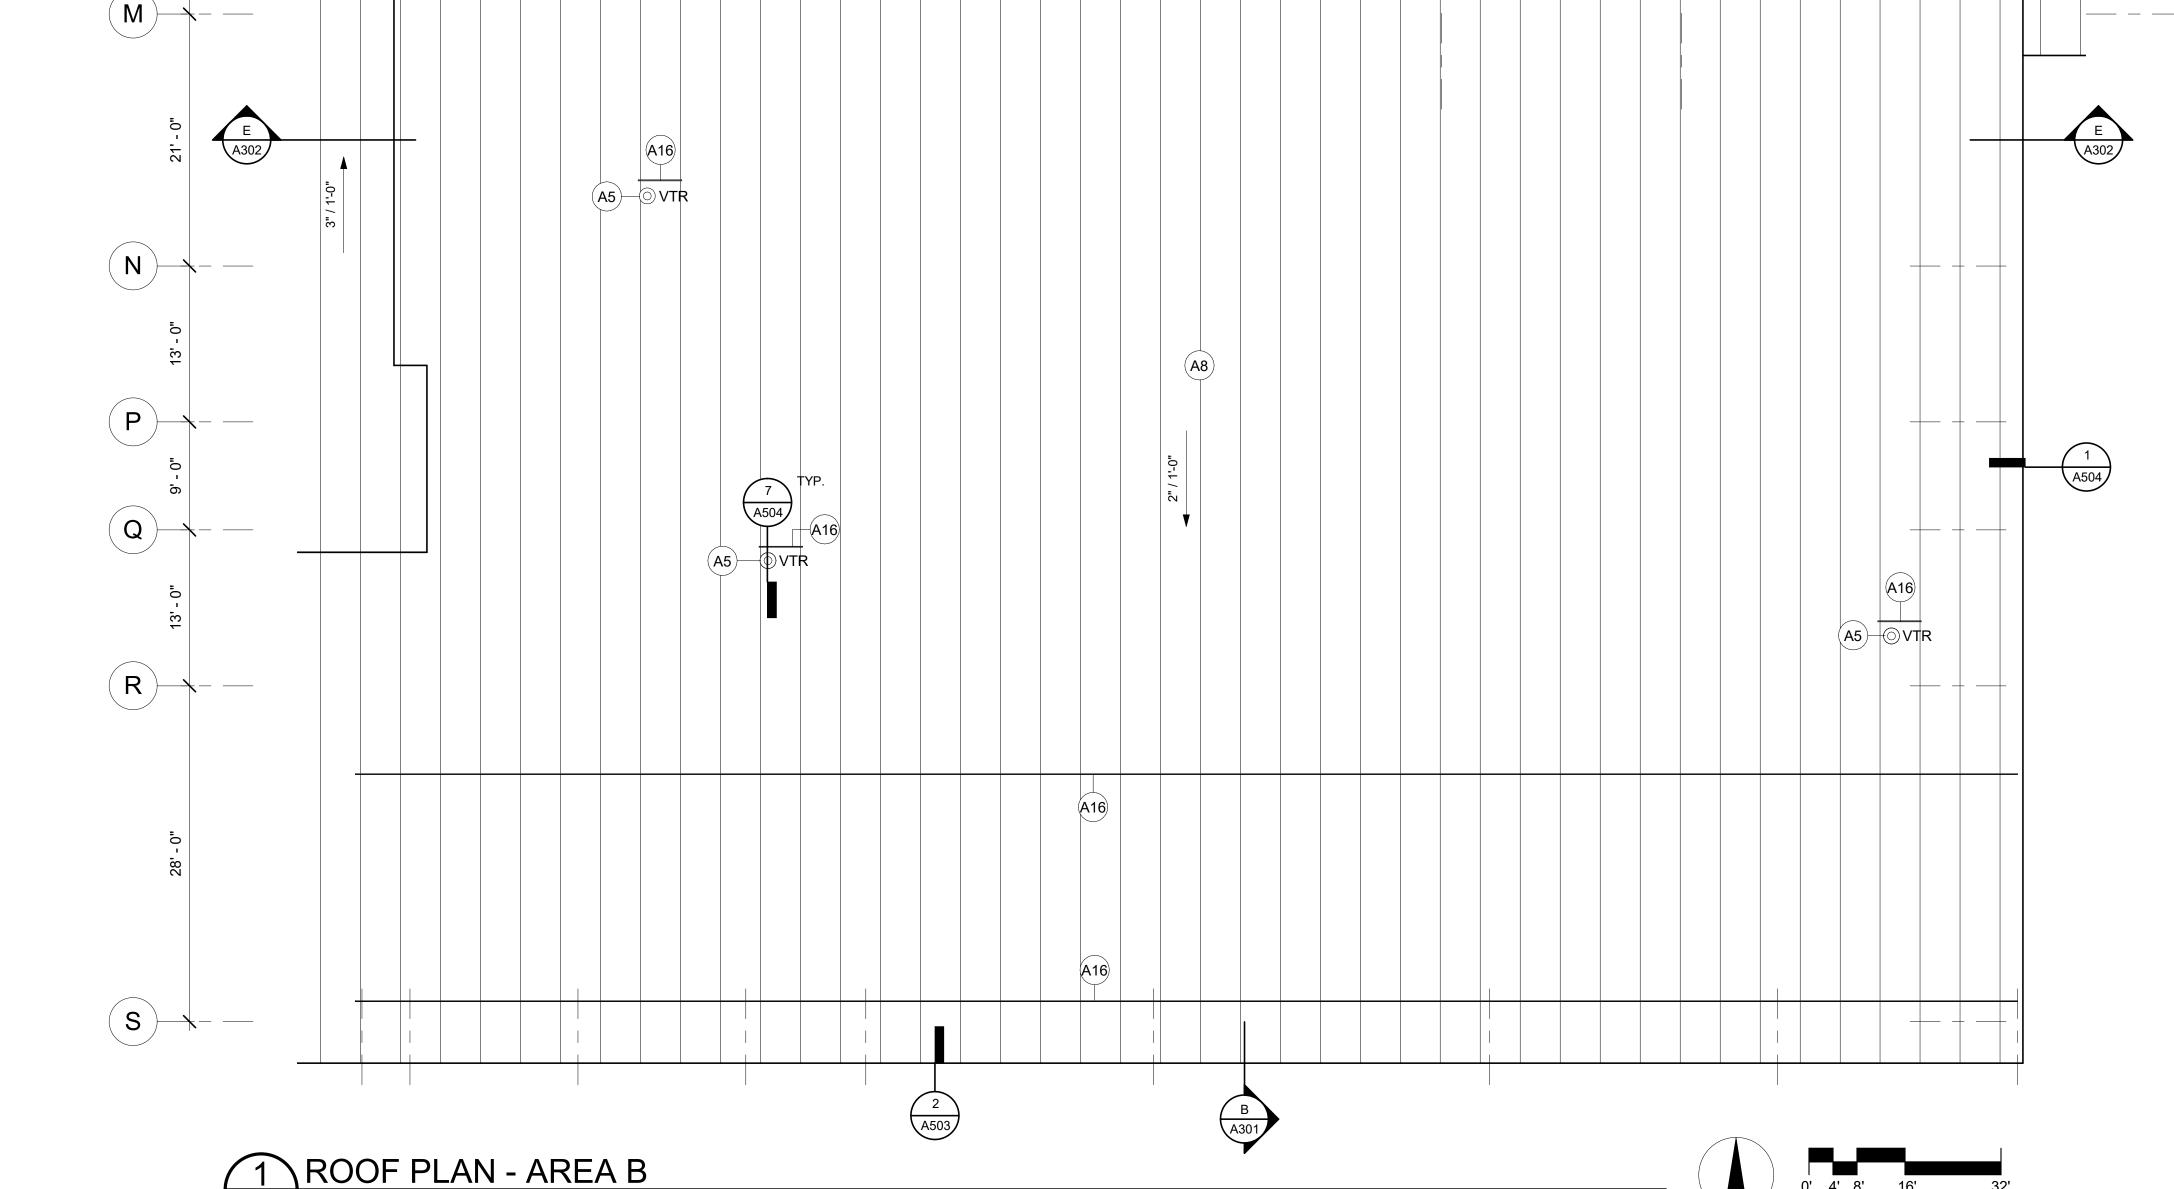

(18)(17)

4' - 0"

14' - 0"

A502

14' - 0"

10' - 0"

24' - 0"

A502

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ANCHORAGE

Spring Hill

Elementary

School Roof

Replacement

9911 Lake Otis Pkwy, Anchorage, AK 99507

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PROJ. MGR.:

DRAWN BY: REVIEWED BY: REVISIONS:

DOCUMENTS

2023017


DD

02/14/2024

SCHOOL DISTRICT

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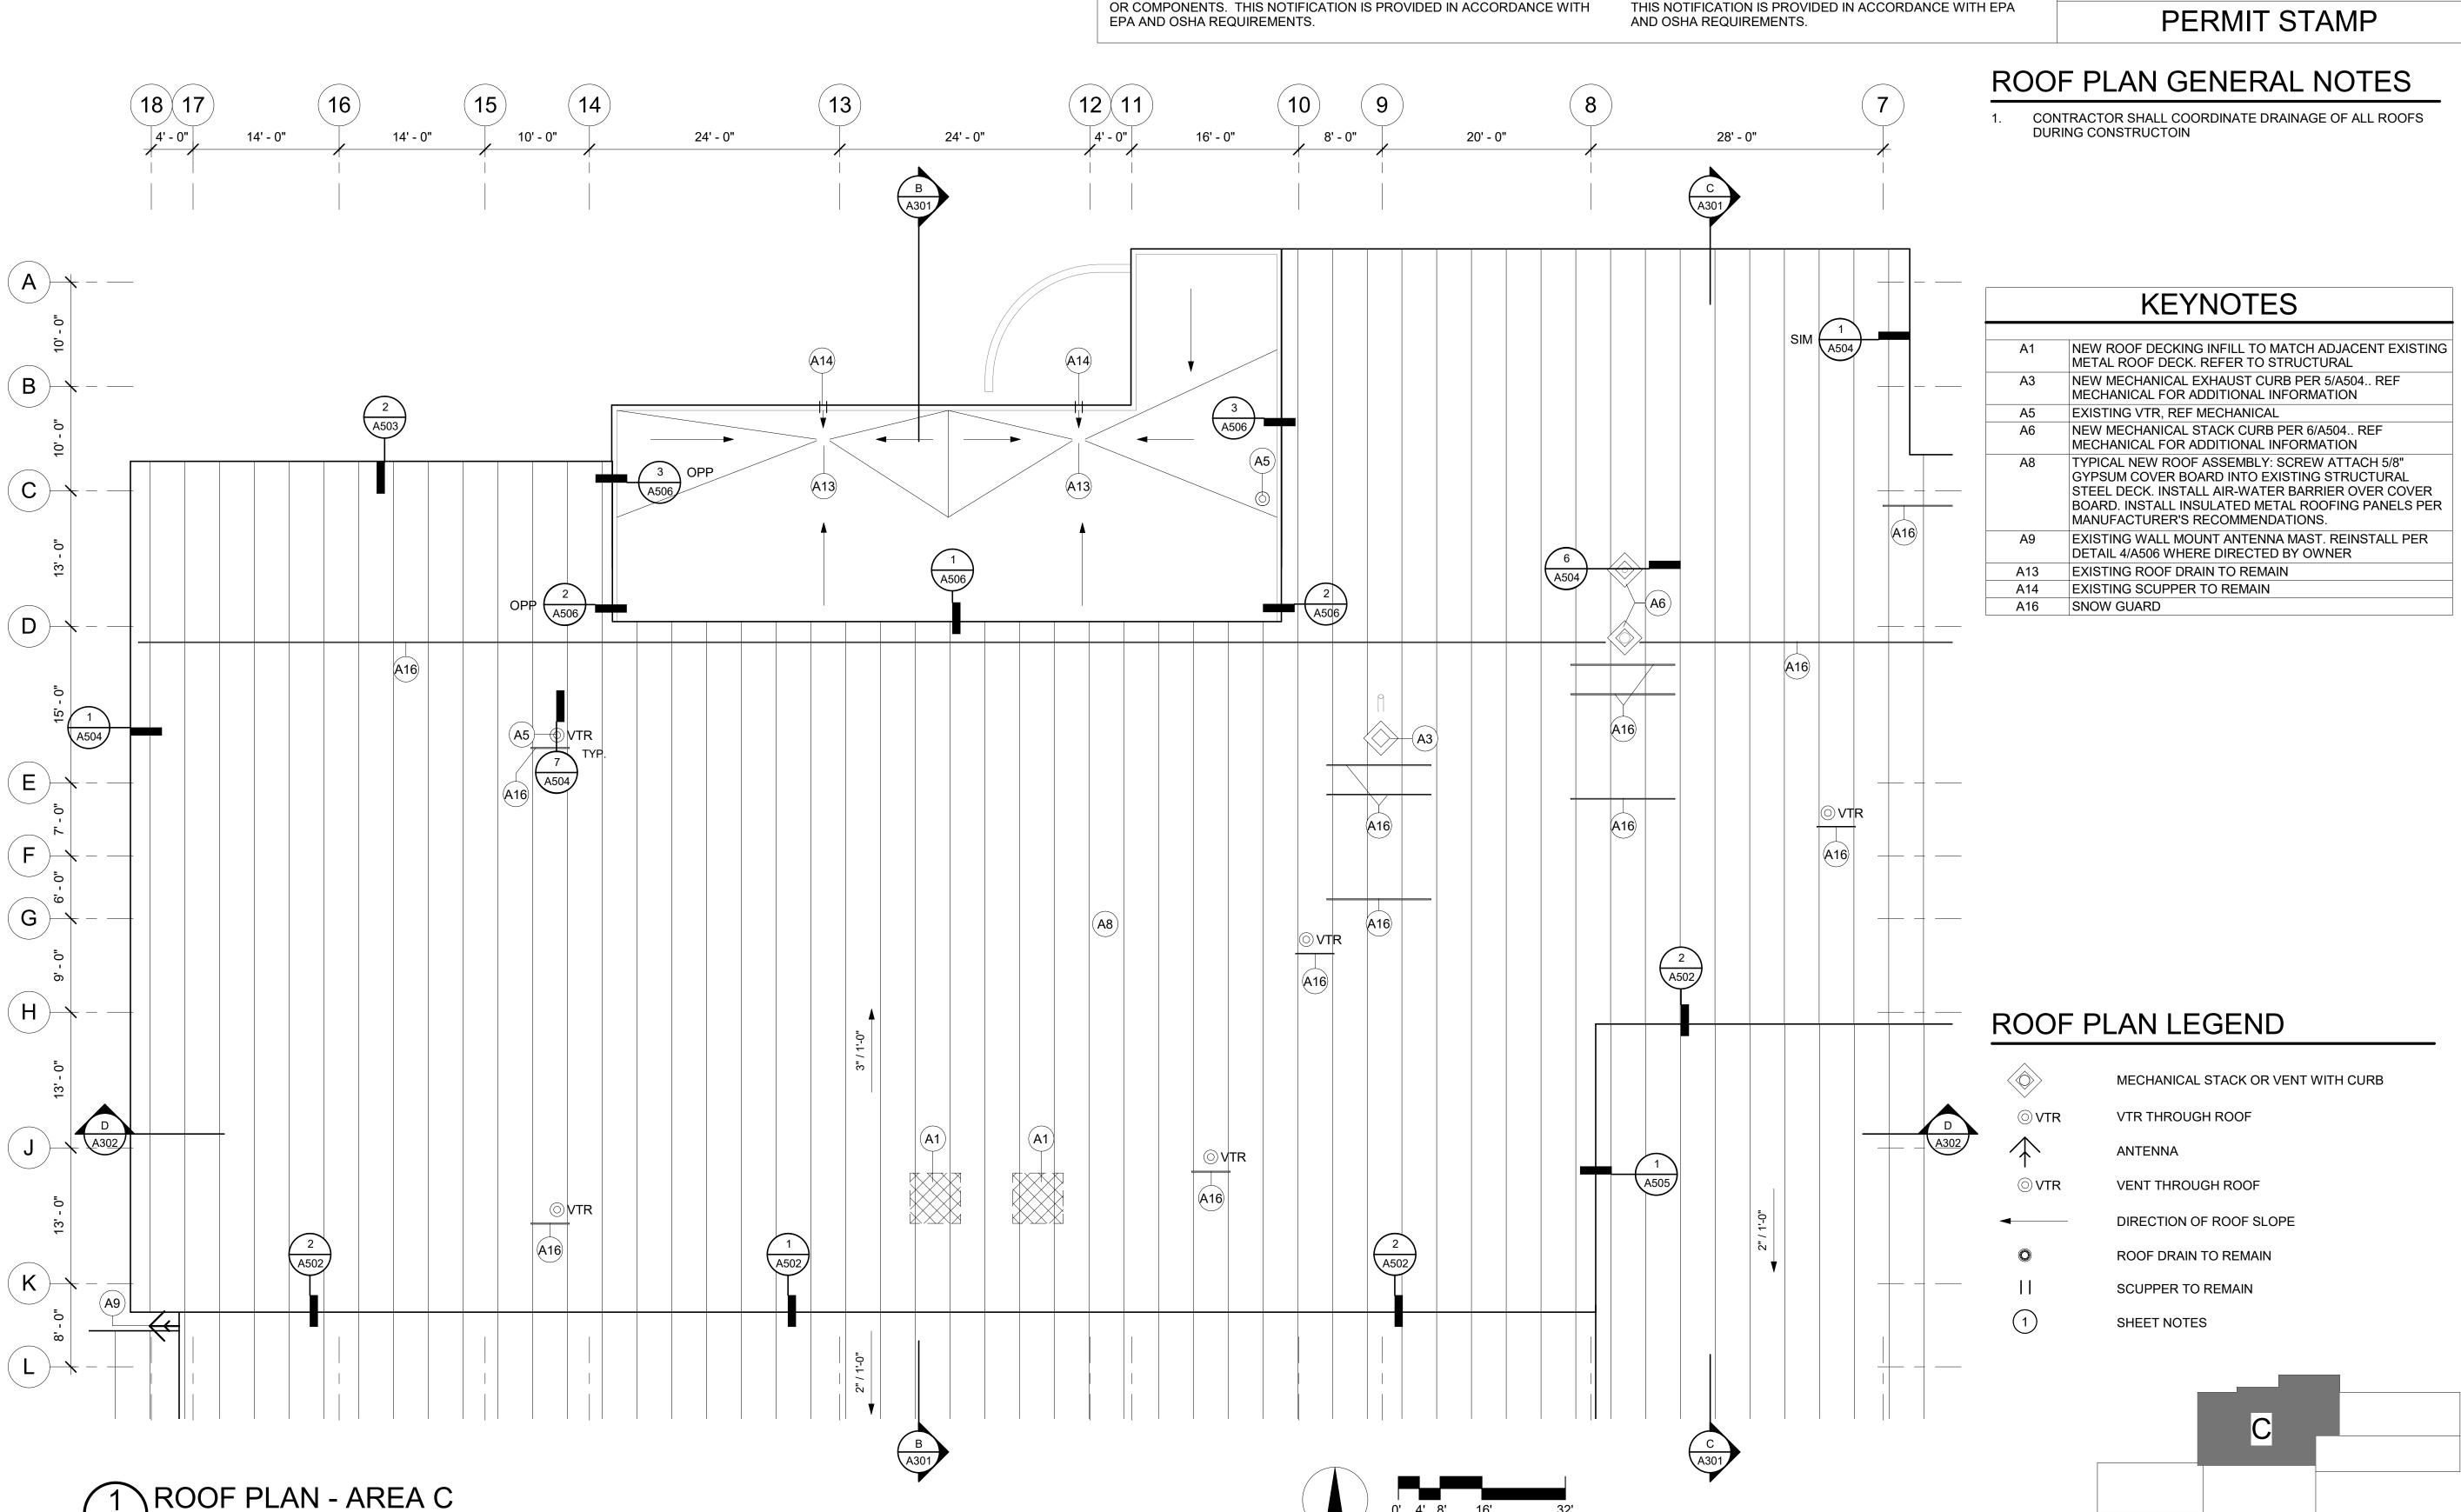


SHEET NO.

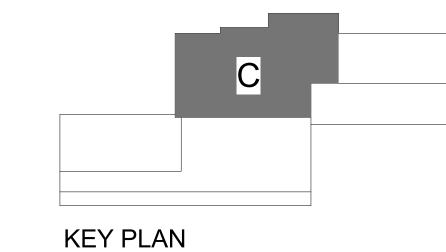ROOF PLAN -

AREA C

A104



22X34 SHEET 11X17 SHEET


NORTH

NOTIFICATION OF CHILD OCCUPIED FACILITY PORTIONS OF THIS BUILDING ARE CLASSIFIED AS A CHILD OCCUPIED FACILITY IN ACCORDANCE WITH 40 CFR 745 AND LEAD-BASED PAINTS MAY BE PRESENT ON COMPONENTS TO BE DISTURBED IN THOSE AREAS. PERSONNEL PERFORMING WORK IN THESE AREAS MUST COMPLY WITH THE REQUIREMENTS OF 40 CFR 745, INCLUDING TRAINING, WORK PRACTICES AND CLEANING OF THE WORK AREA. REFER TO SPECIFICATION DIVISIONS 0, 1 AND 2 FOR SPECIFIC INFORMATION CONCERNING DISTURBING, REMOVING AND DISPOSING OF LEAD MATERIALS AND THE INSTALLATION OF NEW MATERIALS OR COMPONENTS. THIS NOTIFICATION IS PROVIDED IN ACCORDANCE WITH EPA AND OSHA REQUIREMENTS.

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ROOF PLAN GENERAL NOTES

CONTRACTOR SHALL COORDINATE DRAINAGE OF ALL ROOFS

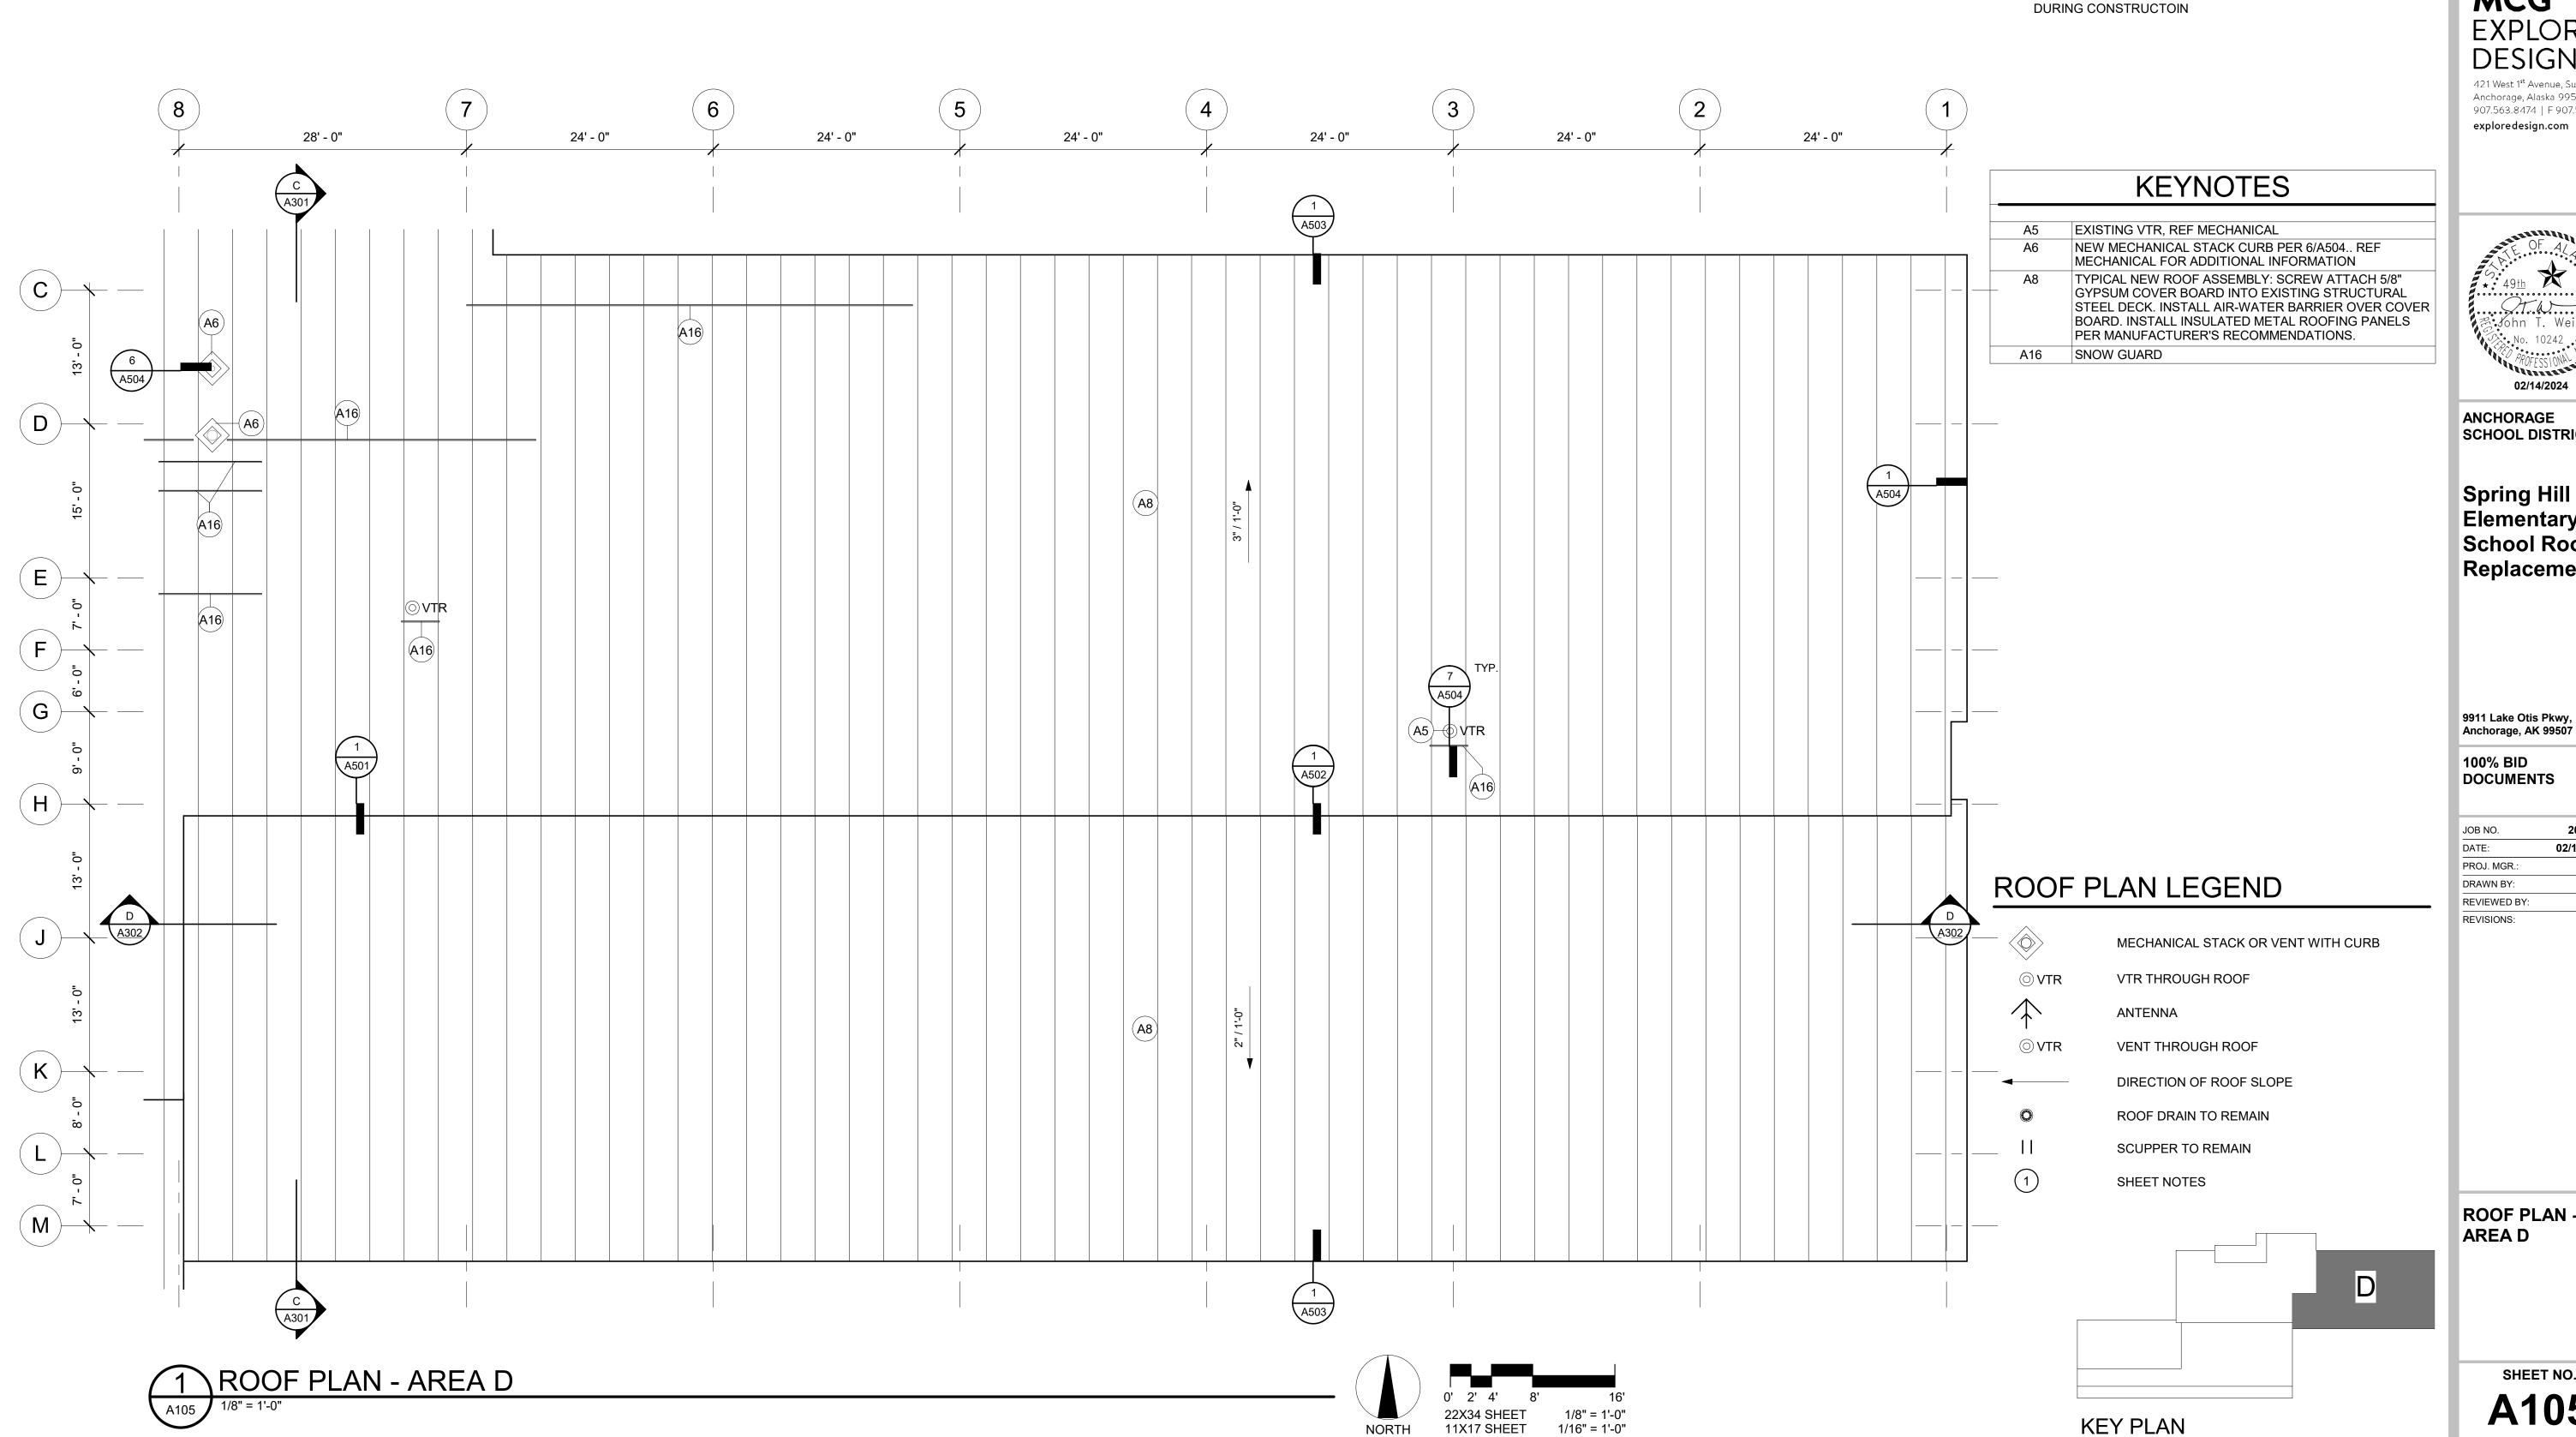

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ANCHORAGE SCHOOL DISTRICT

Spring Hill Elementary **School Roof** Replacement

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	02/14/2024
₹.:	JTW
' :	DD
BY:	-
S:	

ROOF PLAN -

SHEET NO.

A105


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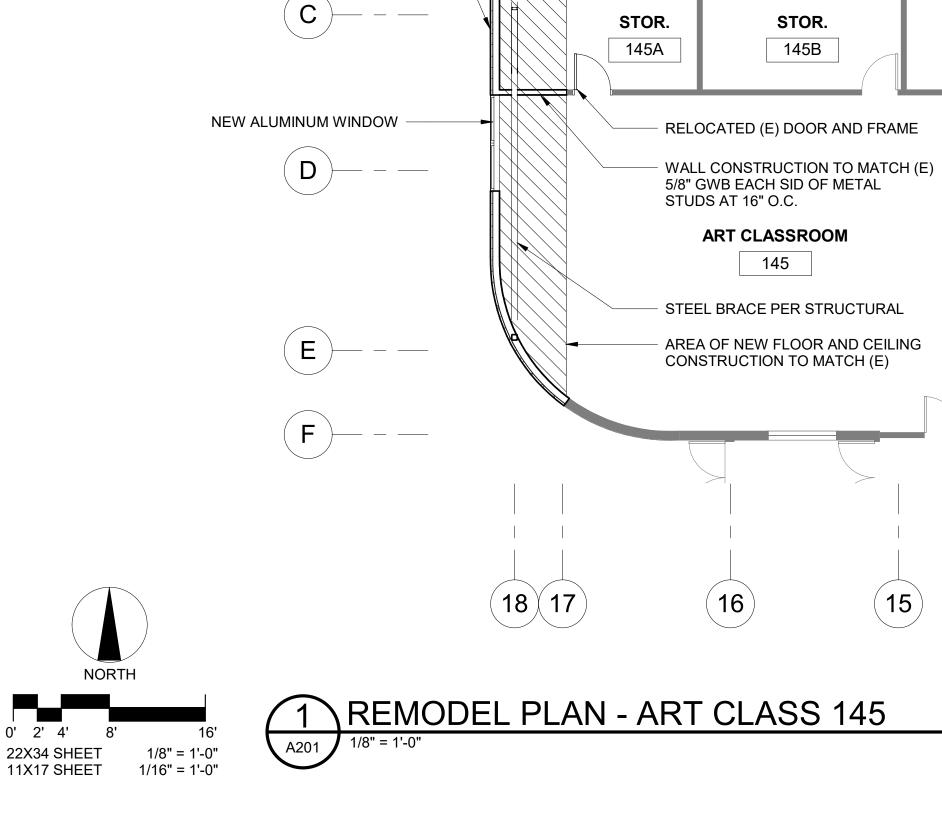
FLIXIVIII STAN

GENERAL NOTES-DEMOLITION

- 1. THE INFORMATION SHOWN IN THIS DRAWING IS TAKEN FROM RECORD DRAWINGS AND A WALK-THRU OF THE EXISTING FACILITY. THERE IS NO WARRANTY OR GUARANTEE AS OF THE ACCURACY OF THE INFORMATION SHOWN. THE CONTRACTOR SHALL FIELD VERIFY CRITCAL ITEMS, AREA, AND ASSEMBLIES SHOWN FOR DEMOLITION PRIOR TO START OF WORK
- CONTRACTOR SHALL FIELD VERIFY ALL DIMENSIONS
- 3. THE OWNER WILL MAINTAIN OCCUPANCY OF THE BUILDING DURING CONSTRUCTION. CONTRACTOR SHALL COORDINATE SITE ACCESS AND STAGING AREA WITH THE OWNER
- 6. REFER TO STRUCTURAL, MECHANICAL AND ELECTRICAL SHEETS FOR RELATED DEMOLITION INFORMATION



\DEMOLITION PLAN - ART CLASS 145

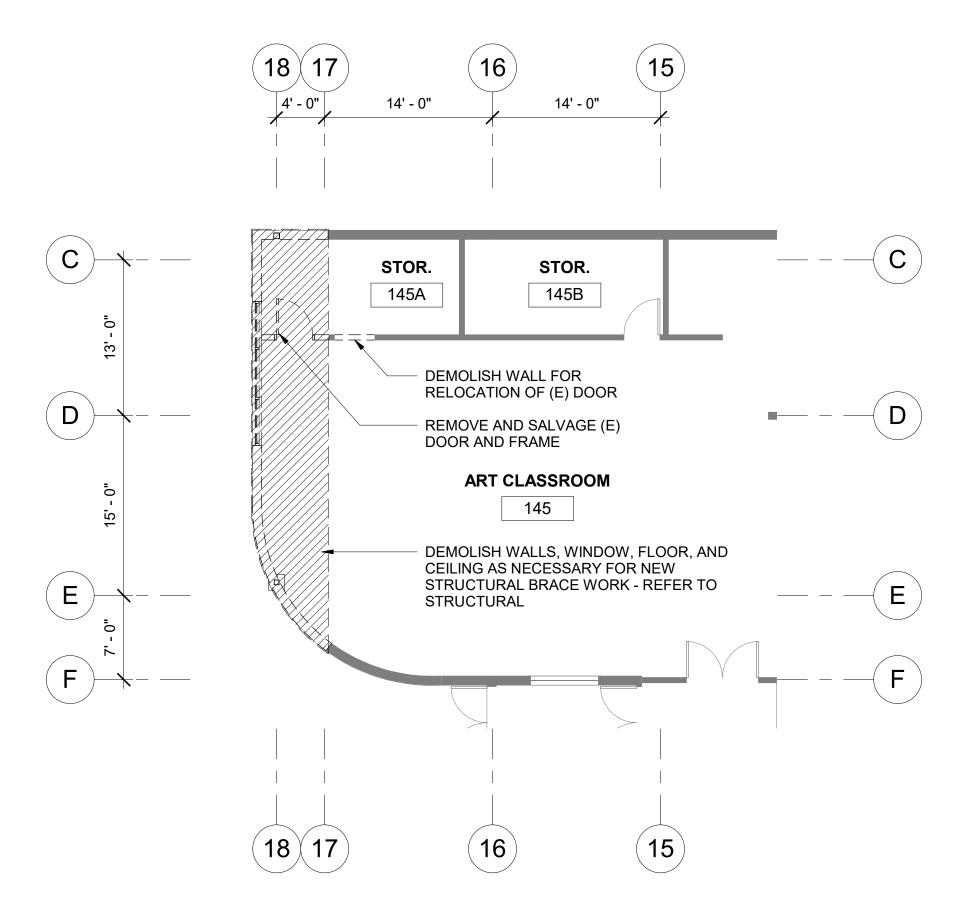

(18)(17)

NEW EXTERIOR WALL

(TO MATCH EXISTING):

1/2" GYPSUM SHEATHING 6" METAL STUDS AT 16" O.C. BATT INSULATION (R-19) 5/8" GYPSUM BOARD 16)

ANCHORAGE SCHOOL DISTRICT

Spring Hill Elementary School Roof Replacement

FOR:

SUBMITTAL

MCG EXPLORE

421 West 1st Avenue, Suite 300

Anchorage, Alaska 99501 907.563.8474 | F 907.563.4572

DESIGN

exploredesign.com

PRICING

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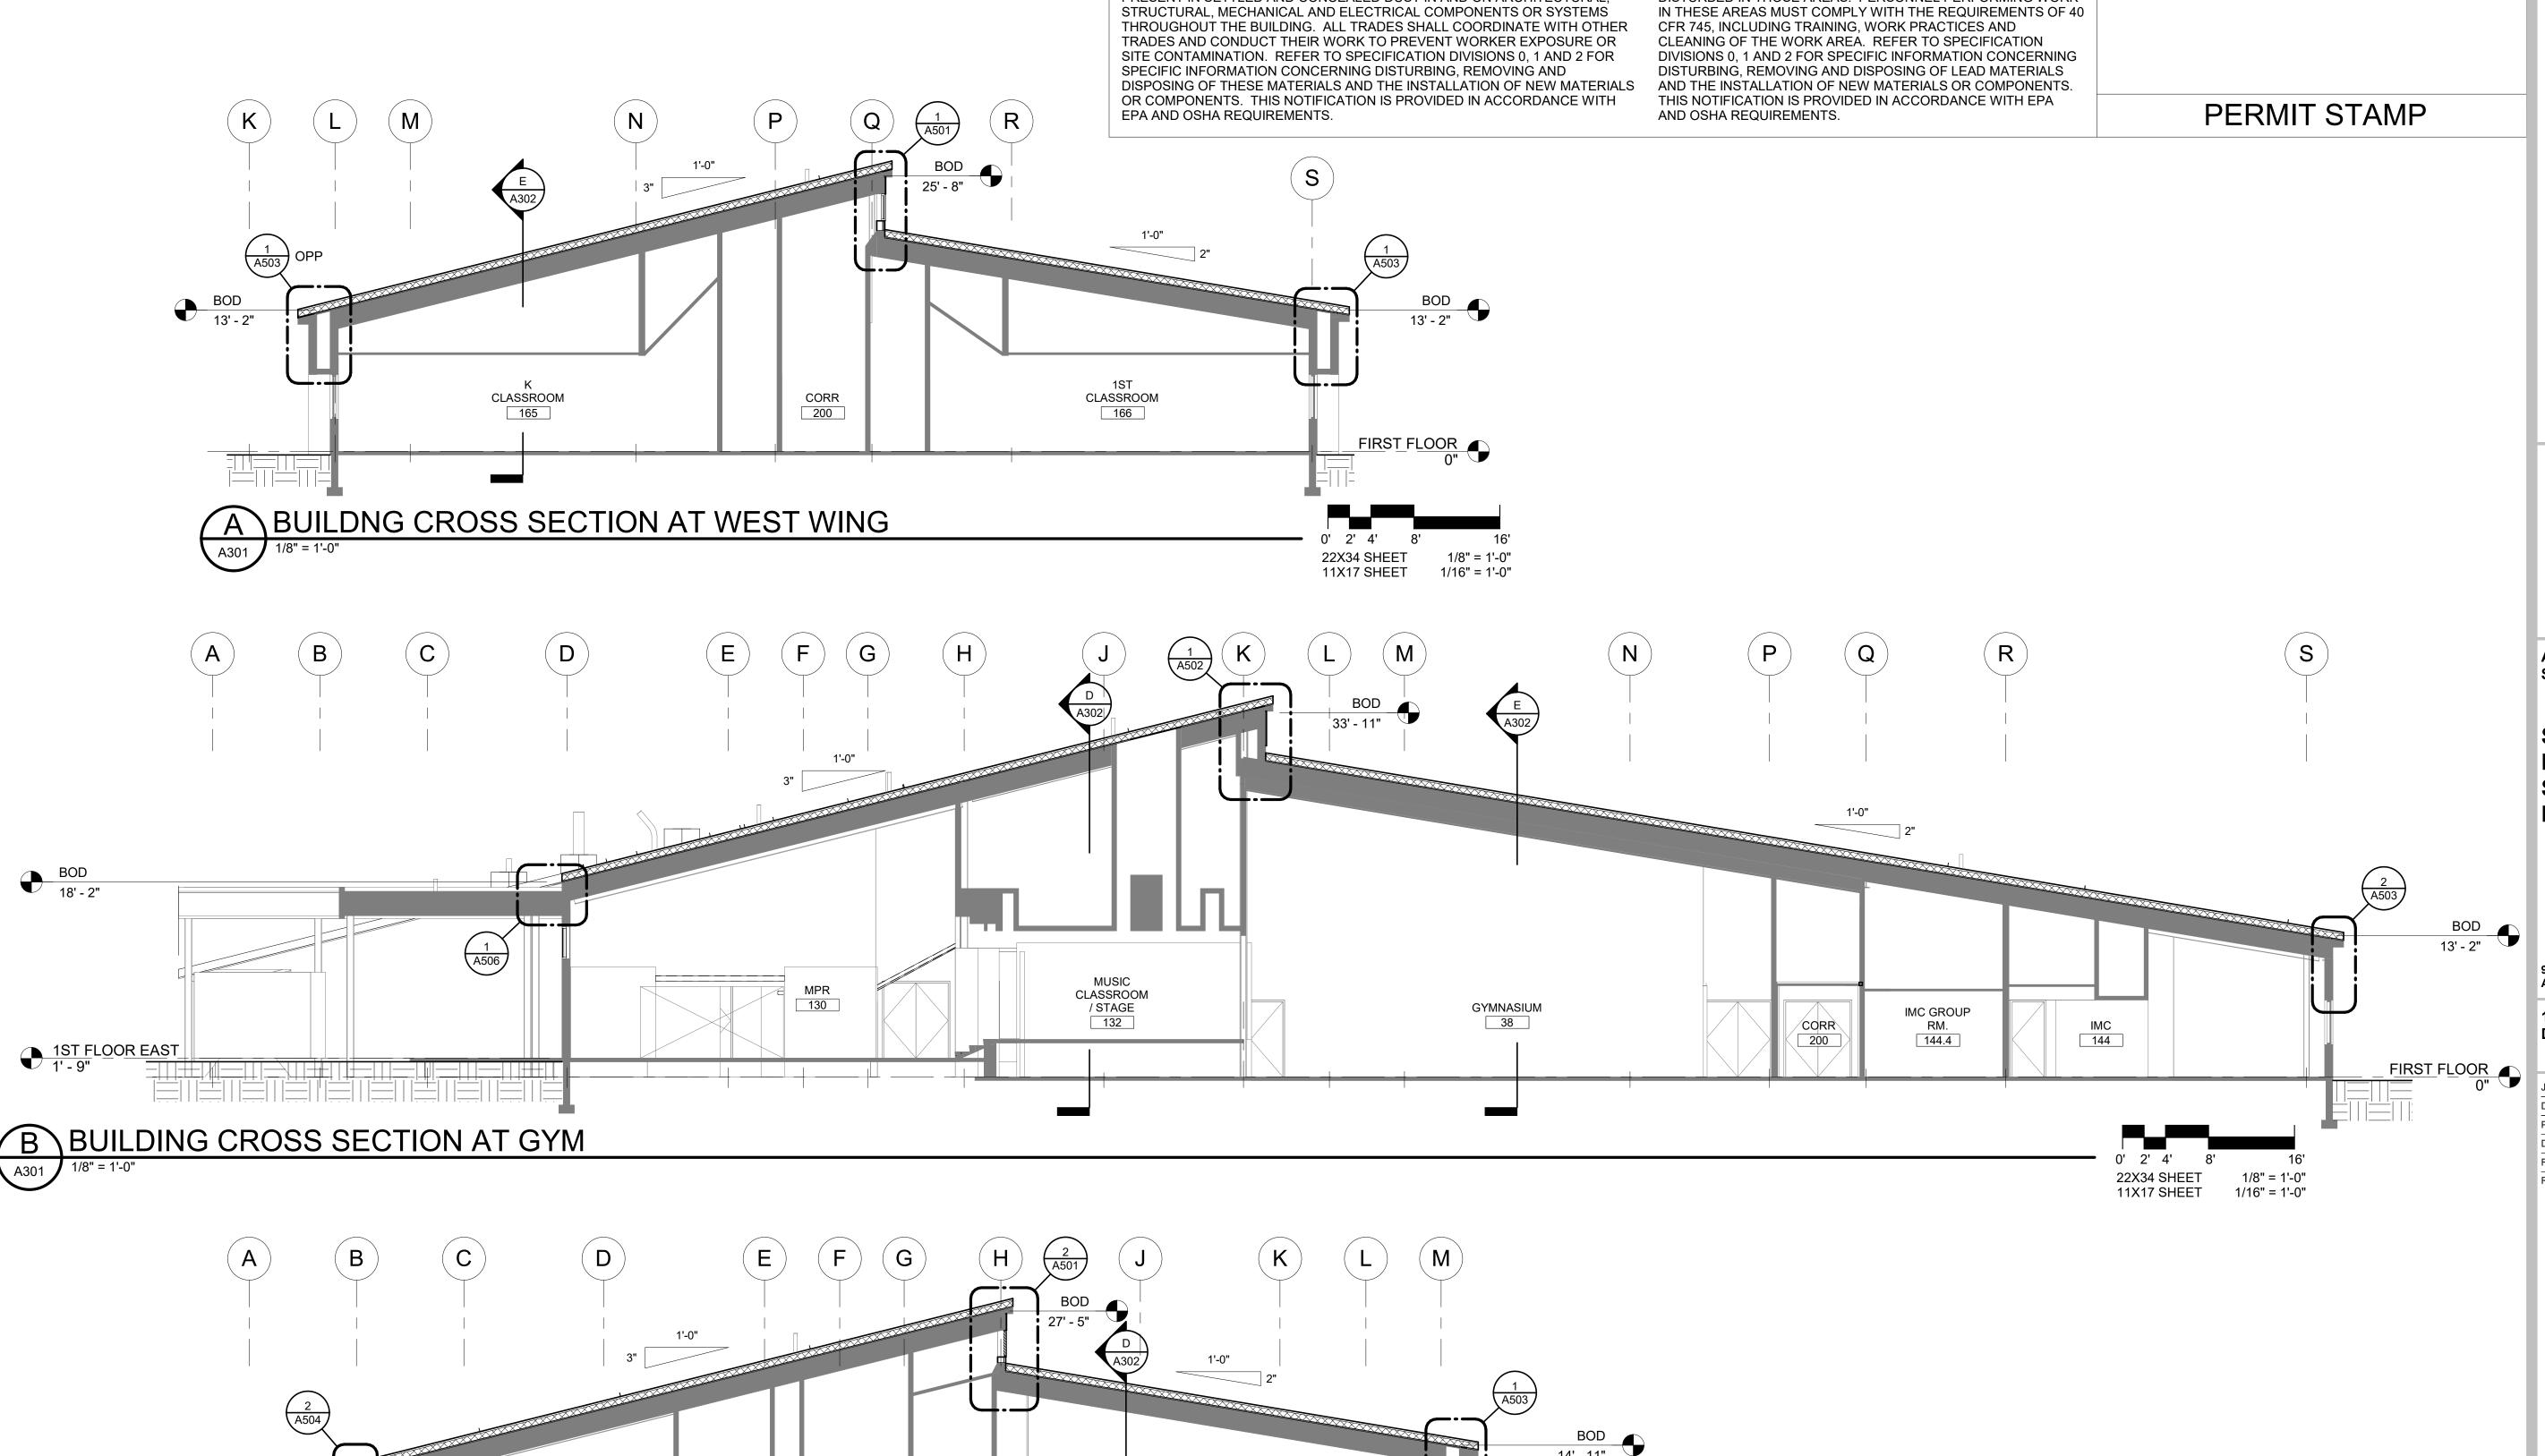
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DD	DRAWN BY:
Checker	REVIEWED BY:
	REVISIONS:

ENLARGED PLANS

SHEET NO. **A201**



2ND-6TH

EXTENDED RESOURCE

CLASSROOM

114

CORR

400

119

2ND-6TH

EXTENDED

RESOURCE

CLASSROOM

116

BOD 9' - 11"

BOILER

ROOM 117

C BUILDING CROSS SECTION AT EAST WING

118

14' - 11"

1ST FLOOR EAST 1' - 9"

22X34 SHEET 11X17 SHEET 1/8" = 1'-0"

1/16" = 1'-0"

NOTIFICATION OF POTENTIAL HAZARD

ASBESTOS, LEAD AND OTHER POTENTIALLY HAZARDOUS MATERIALS ARE

PRESENT IN THE BUILDING THAT MAY IMPACT THE WORK OF ALL TRADES.

PRESENT IN SETTLED AND CONCEALED DUST IN AND ON ARCHITECTURAL,

REGULATED AIR CONTAMINANTS, INCLUDING ASBESTOS AND LEAD, ARE ALSO

NOTIFICATION OF CHILD OCCUPIED FACILITY

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IN THESE AREAS MUST COMPLY WITH THE REQUIREMENTS OF 40

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BUILDING **SECTIONS**

SHEET NO.

A301

NOTIFICATION OF CHILD OCCUPIED FACILITY
PORTIONS OF THIS BUILDING ARE CLASSIFIED AS A CHILD
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ANCHORAGE SCHOOL DISTRICT

Spring Hill Elementary School Roof Replacement


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BUILDING SECTIONS

SHEET NO. **A302**




12 \(11

A301

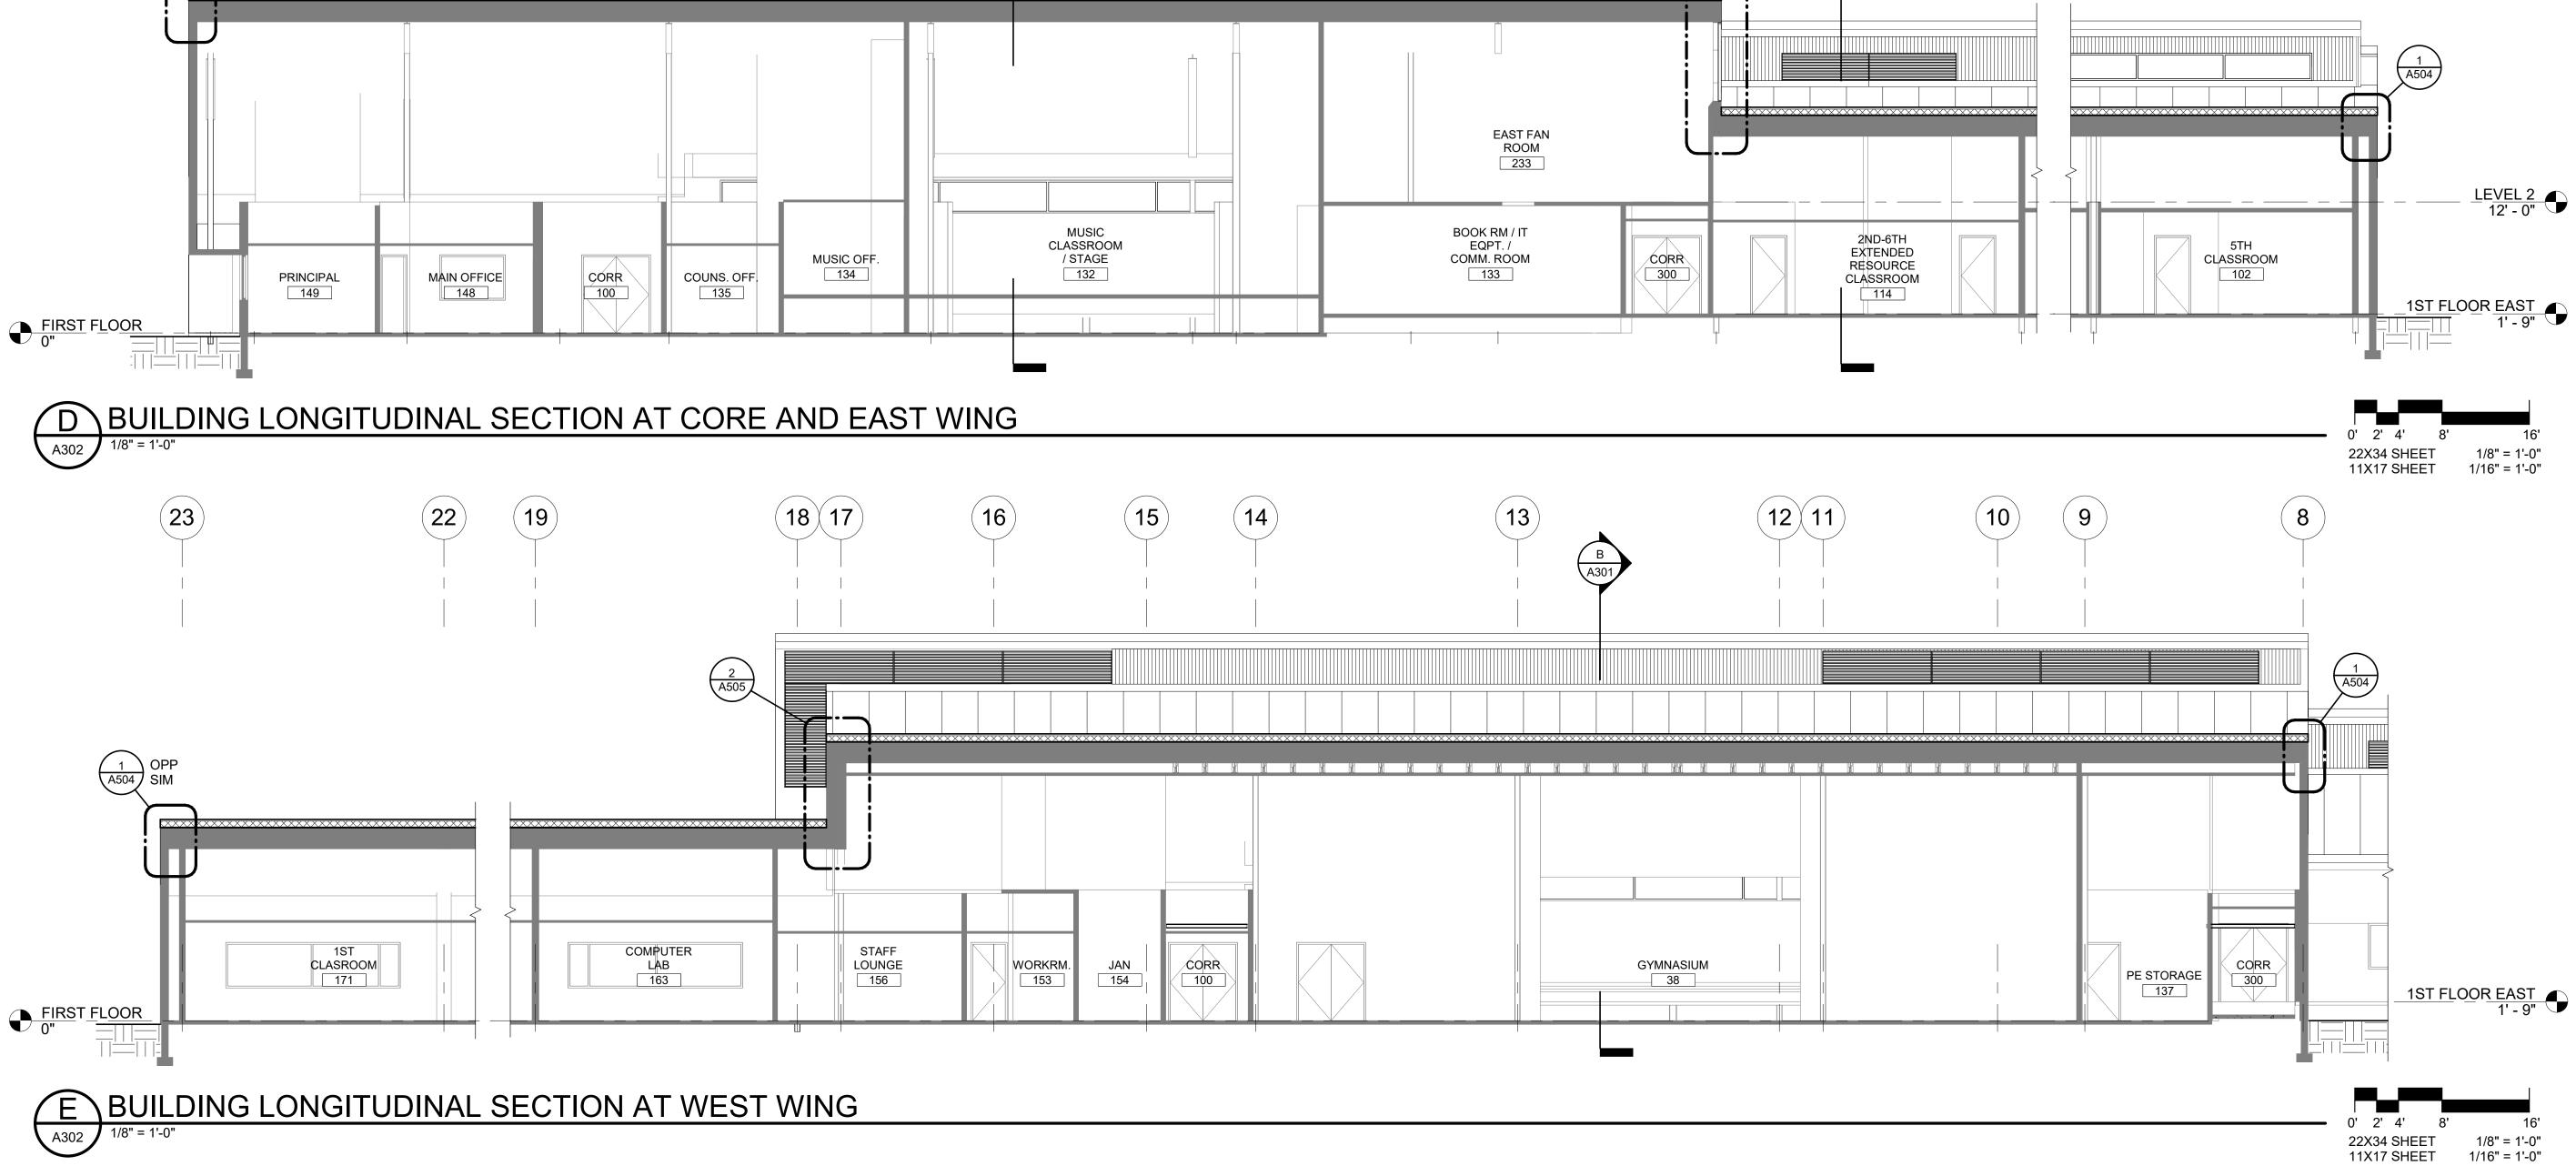15

16

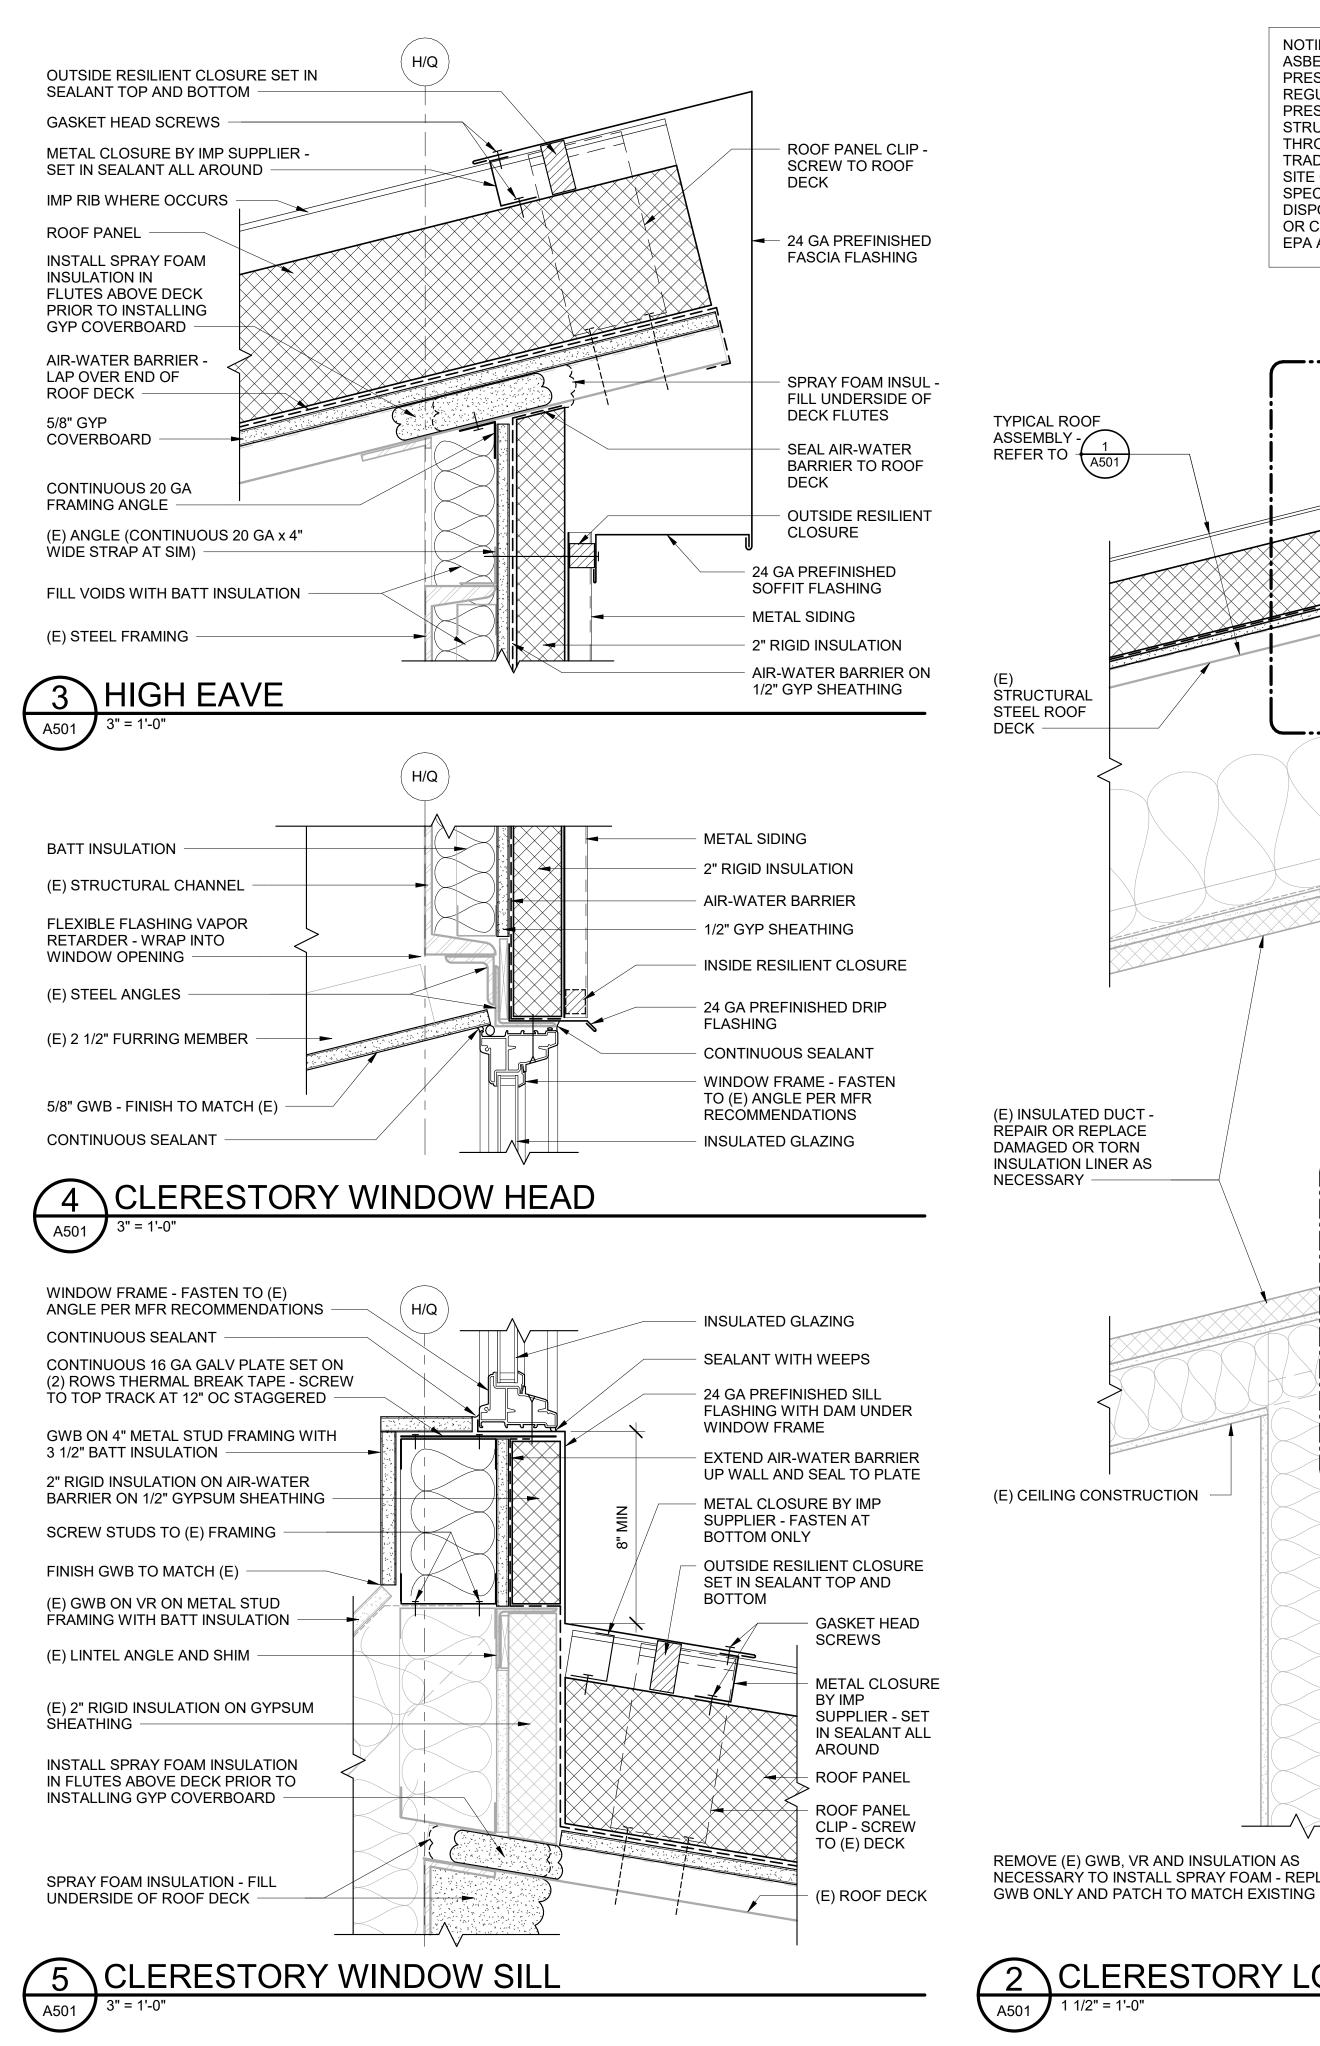

CLERESTORY LOUVER SECTION AT GRID H

NOTIFICATION OF CHILD OCCUPIED FACILITY PORTIONS OF THIS BUILDING ARE CLASSIFIED AS A CHILD OCCUPIED FACILITY IN ACCORDANCE WITH 40 CFR 745 AND LEAD-BASED PAINTS MAY BE PRESENT ON COMPONENTS TO BE DISTURBED IN THOSE AREAS. PERSONNEL PERFORMING WORK IN THESE AREAS MUST COMPLY WITH THE REQUIREMENTS OF 40 CFR 745, INCLUDING TRAINING, WORK PRACTICES AND CLEANING OF THE WORK AREA. REFER TO SPECIFICATION DIVISIONS 0, 1 AND 2 FOR SPECIFIC INFORMATION CONCERNING DISTURBING, REMOVING AND DISPOSING OF LEAD MATERIALS AND THE INSTALLATION OF NEW MATERIALS OR COMPONENTS. THIS NOTIFICATION IS PROVIDED IN ACCORDANCE WITH EPA AND OSHA REQUIREMENTS.

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02/14/2024

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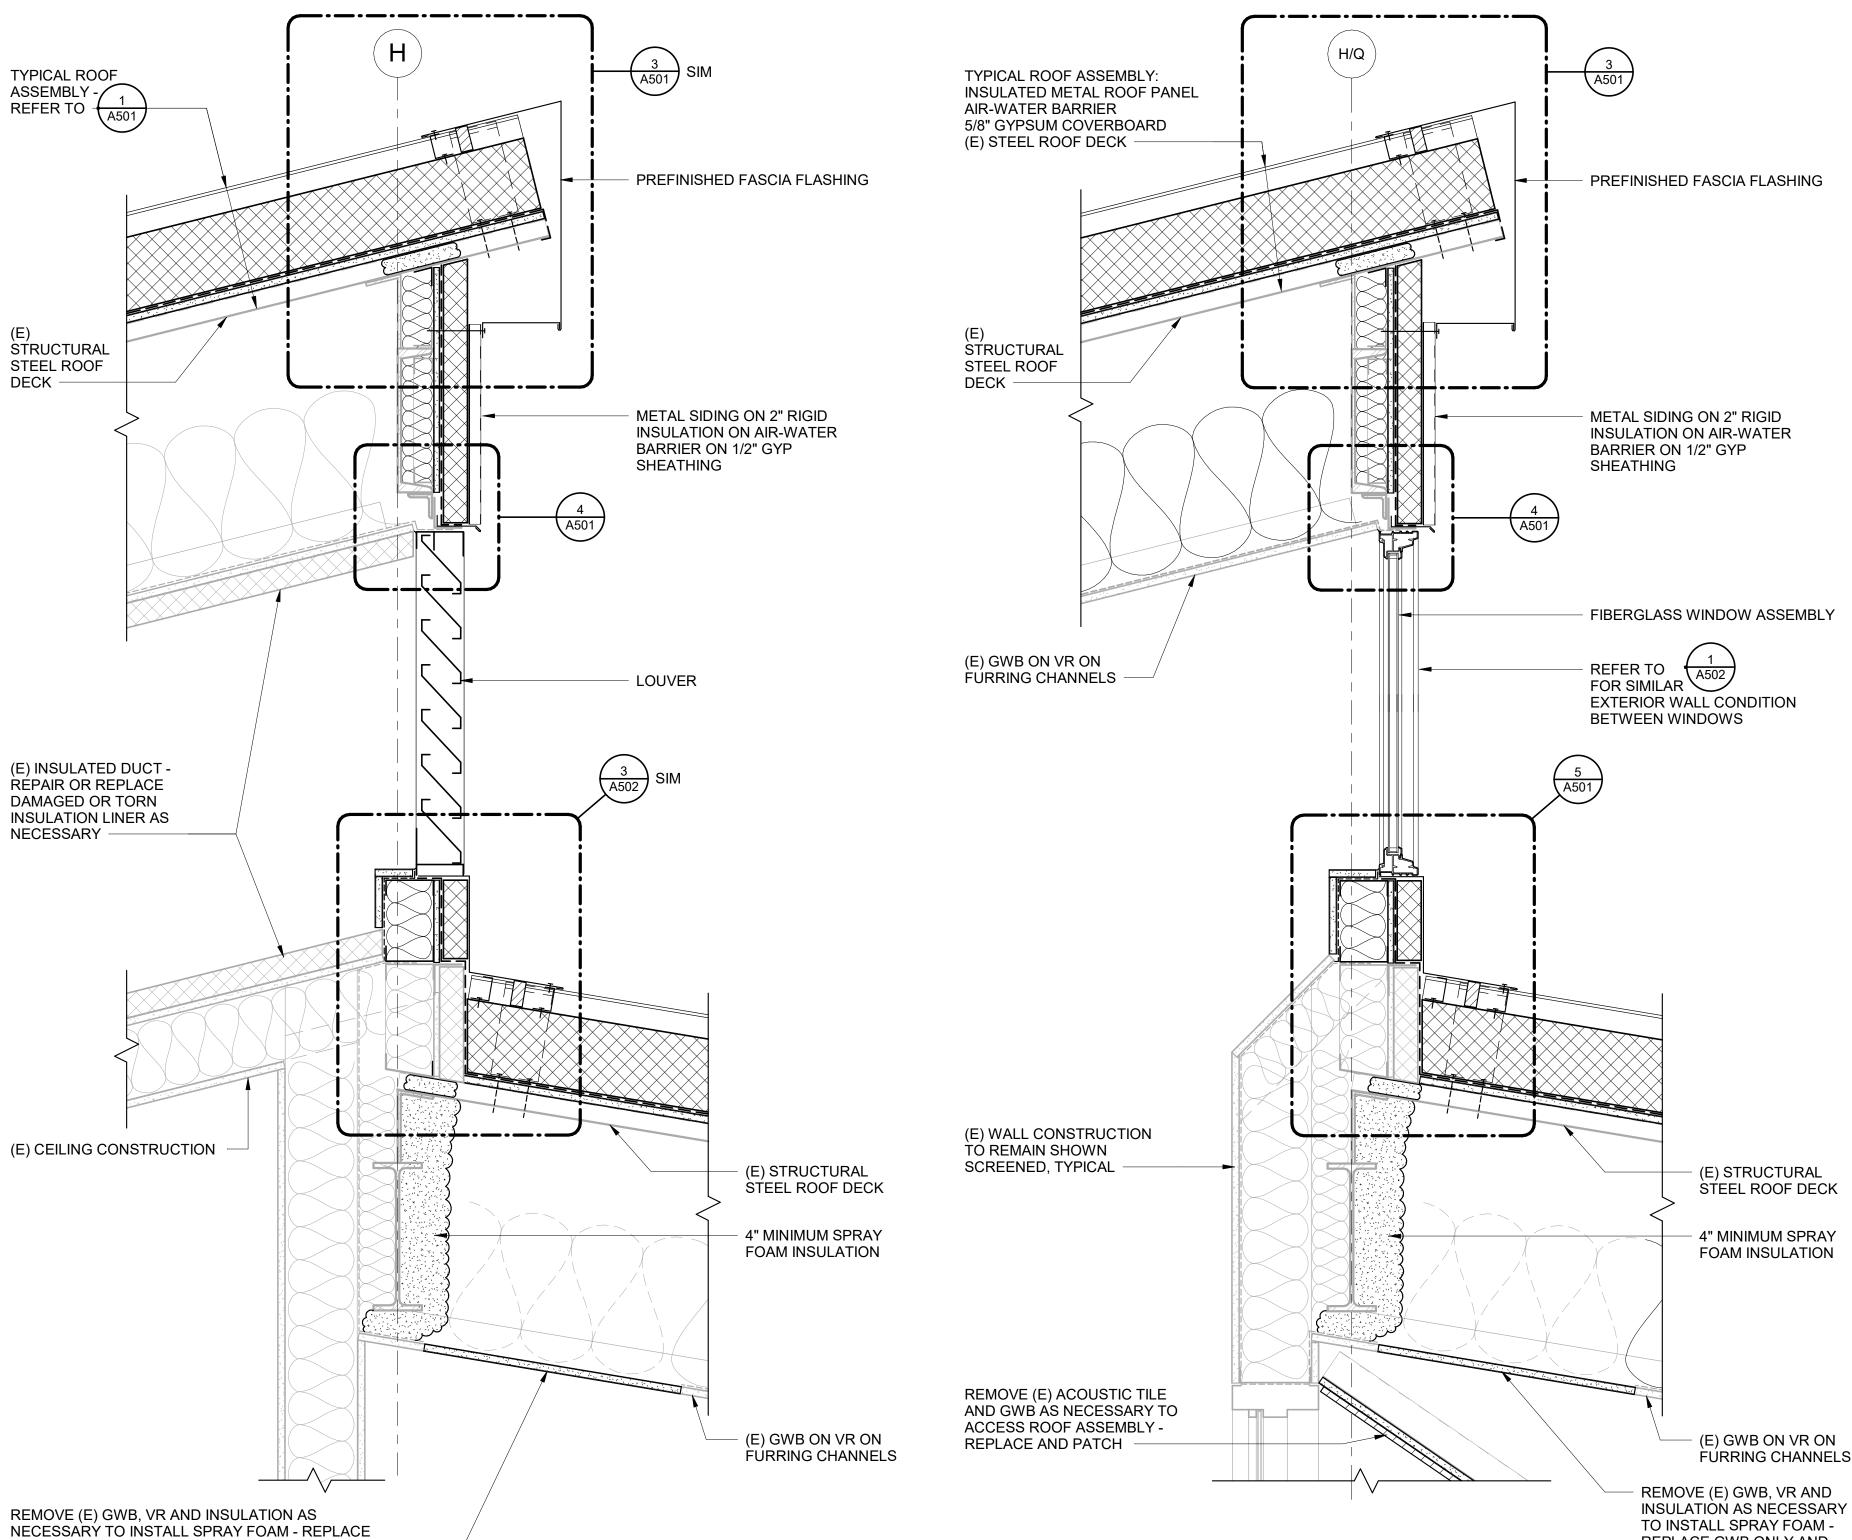
DETAILS

REPLACE GWB ONLY AND

PATCH TO MATCH EXISTING

SHEET NO. **A501**

CLERESTORY WINDOW SECTION AT GRIDS H & Q A501



METAL SIDING 2" RIGID INSULATION AIR-BARRIER - LAP OVER 3 1/2" FACED BATT INSULATION IN (E) STUD SPACES LAP LOWER AIR-WATER BARRIER ALIGN WITH WINDOW OR **UP INDER FLASHING** LOUVER SILL CONTINUOUS 20 GA x 4" WIDE 24 GA PREFINISHED FLASHING ACROSS FACE OF (E) STUDS EXTEND UP BEHIND UPPER RIGID INSUL AND SCREW INTO STRAP METAL CLOSURE BY IMP SUPPLIER - FASTEN AT (E) METAL STUD BLOCKING **BOTTOM ONLY OUTSIDE RESILIENT CLOSURE** SET IN SEALANT TOP AND (E) METAL STUD FRAMING BOTTOM GASKET HEAD **SCREWS** 1/2" GYP SHEATHING IMP RIB WHERE 2" RIGID INSULATION **OCCURS** AIR-WATER BARRIER **ROOF PANEL ROOF PANEL** CLIP - SCREW TO (E) DECK (E) ROOF DECK

CLERESTORY LOUVER SECTION AT GRID K

NOTIFICATION OF POTENTIAL HAZARD ASBESTOS, LEAD AND OTHER POTENTIALLY HAZARDOUS MATERIALS ARE PRESENT IN THE BUILDING THAT MAY IMPACT THE WORK OF ALL TRADES. REGULATED AIR CONTAMINANTS, INCLUDING ASBESTOS AND LEAD, ARE ALSO PRESENT IN SETTLED AND CONCEALED DUST IN AND ON ARCHITECTURAL, STRUCTURAL, MECHANICAL AND ELECTRICAL COMPONENTS OR SYSTEMS THROUGHOUT THE BUILDING. ALL TRADES SHALL COORDINATE WITH OTHER TRADES AND CONDUCT THEIR WORK TO PREVENT WORKER EXPOSURE OR SITE CONTAMINATION. REFER TO SPECIFICATION DIVISIONS 0, 1 AND 2 FOR SPECIFIC INFORMATION CONCERNING DISTURBING, REMOVING AND DISPOSING OF THESE MATERIALS AND THE INSTALLATION OF NEW MATERIALS OR COMPONENTS. THIS NOTIFICATION IS PROVIDED IN ACCORDANCE WITH

LOUVER - SEE

 $\begin{pmatrix} 3 \\ A502 \end{pmatrix}$

FÚRRING CHANNELS

(E) EXHAUST DUCT

4" MIN SPRAY FOAM

INSULATION

(E) WALL

CÓNSTRUCTION TO **REMAIN SHOWN** SCREENED, TYPICAL

MECHANICAL

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PERMIT STAMP

K TYPICAL ROOF ASSEMBLY -PREFINISHED FASCIA FLASHING METAL SIDING ON 2" RIGID INSULATION ON AIR-WATER BARRIER ON 1/2" GYP SHEATHING 3 1/2" FACED BATT INSULATION (E) GWB ON VR ON

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REVISIONS:

(E) STRUCTURAL

(E) STRUCTURAL

(E) GWB ON VR ON FURRING

CHANNELS

STEEL ROOF

STEEL BEAM

AND JOIST

DECK

DOCUMENTS

SUBMITTAL

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02/14/2024

ANCHORAGE

Spring Hill

Elementary

School Roof

Replacement

SCHOOL DISTRICT


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DETAILS

SHEET NO.

A502



4" MIN SPRAY FOAM INSULATION (E) STRUCTURAL STEEL BEAM AND JOIST

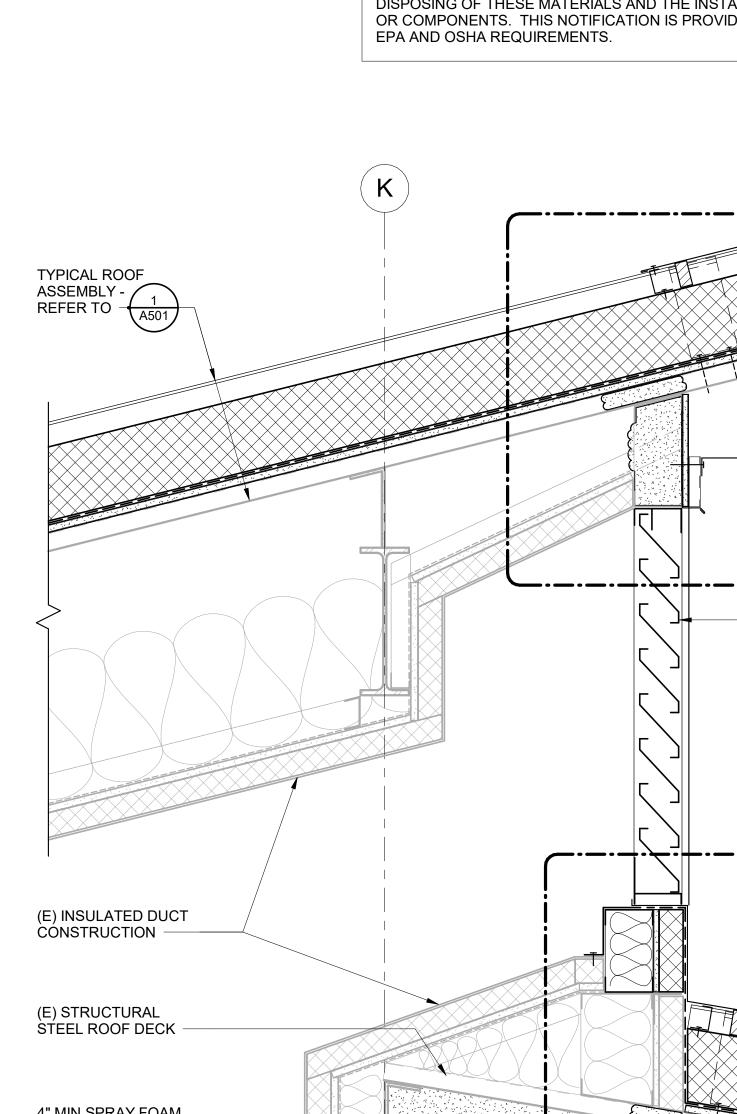REMOVE (E) GWB AND VR AS NECESSARY TO INSTALL SPRAY FOAM -REPLACE GWB ONLY AND PATCH TO MATCH EXISTING

(E) GWB ON VR ON FURRING CHANNELS

CLERESTORY WALL SECTION AT GRID K A502

REMOVE (E) GWB AND VR AS NECESSARY TO INSTALL SPRAY FOAM -

REPLACE GWB ONLY AND PATCH TO MATCH EXISTING

(E) ROOF JOIST

CLERESTORY LOUVER SILL

CLERESTORY WALL AT ROOF

ROOF PANEL CLIP **CUT BACK** PANEL FOAM AND LINER **AIR-WATER BARRIER** LAP OVER END OF ROOF DECK INSIDE RESILIENT CLOSURE GASKET HEAD SCREW AT 8" O.C. 24 GA **PREFINISHED FASCIA FLASHING** (E) ROOF **FRAMING AND** DECK (E) METAL STUD FRAMING —► (E) SOFFIT FLASHING (E) EIFS

_OW EAVE

INSTALL SPRAY FOAM INSULATION IN FLUTES ABOVE DECK PRIOR TO INSTALLING GYP COVERBOARD 4" MIN SPRAY FOAM **INSULATION - FILL** UNDERSIDE OF DECK FLUTES **INSTALL WIRE MESH** OR SIMILAR BACKING AT (E) 8" WIDE VENT SPACES PRIOR TO SPRAY FOAM (E) STEEL STRUCTURE REFER TO 3 FOR TYP A503 CALLOUTS SEAL SPRAY FOAM TO (E) VAPOR RETARDER

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TYPICAL ROOF

REFER TO (A501)

REMOVE (E) GWB, VR AND

EXISTING

INSULATION AS NÉCESSARY TO

INSTALL SPRAY FOAM - REPLACE GWB ONLY AND PATCH TO MATCH

(E) GWB ON VR ON FURRING CHANNELS

(E) EXTERIOR WALL CONSTRUCTION

ASSEMBLY -

PERMIT STAMP

SPRAY FOAM

INSULATION -/

REFER TO

4 (A503)

— (E) EIFS ON METAL

STUD FRAMING



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02/14/2024

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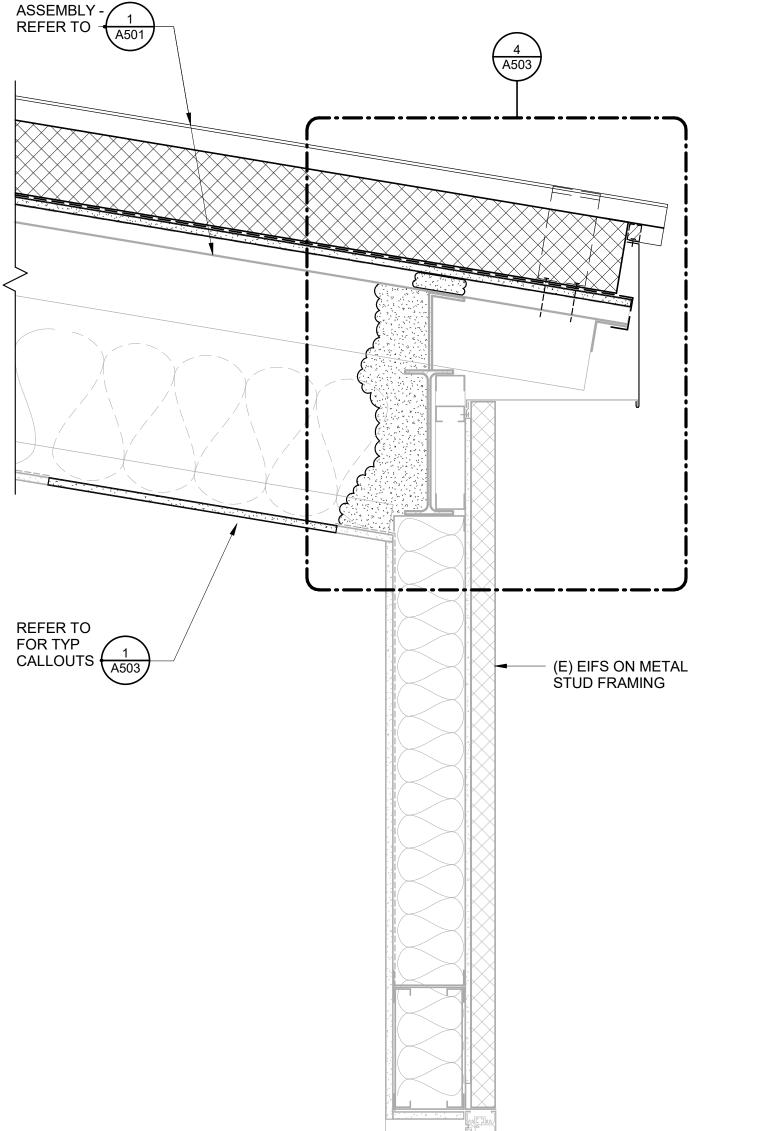
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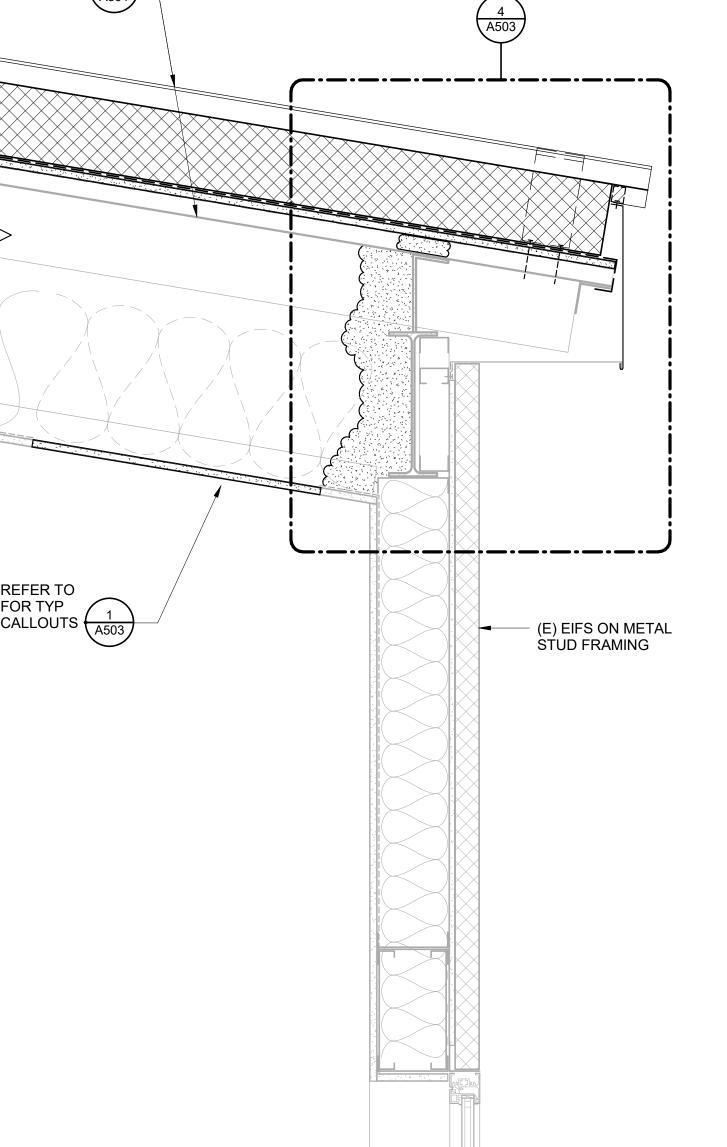
DETAILS

SHEET NO. **A503**

LOW EAVE SECTION AT IMC

LOW EAVE SECTION AT CLASSROOMS







TYPICAL ROOF

OW EAVE AT IMC

ROOF CURB AT KITCHEN EXHAUST HOOD

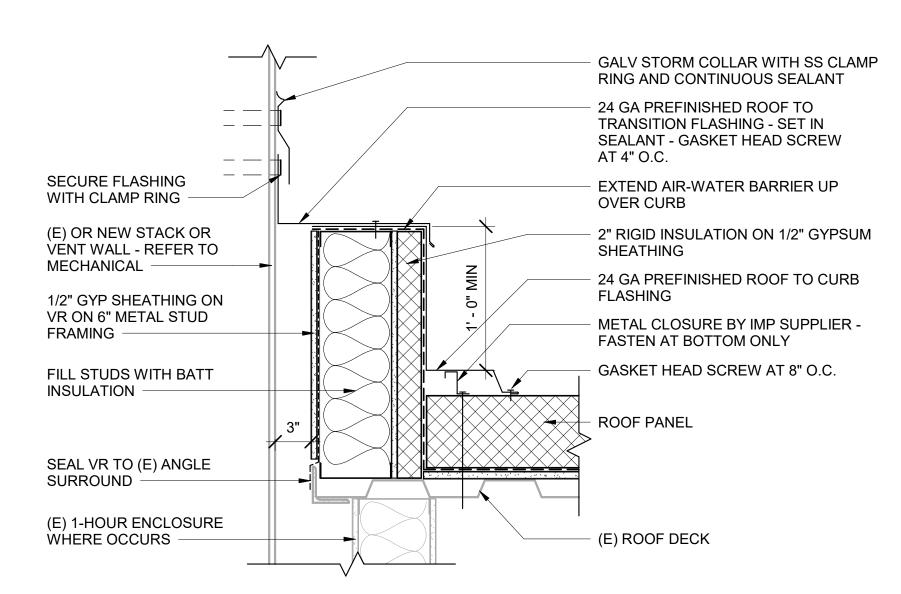

ROOF CURB AT STACK

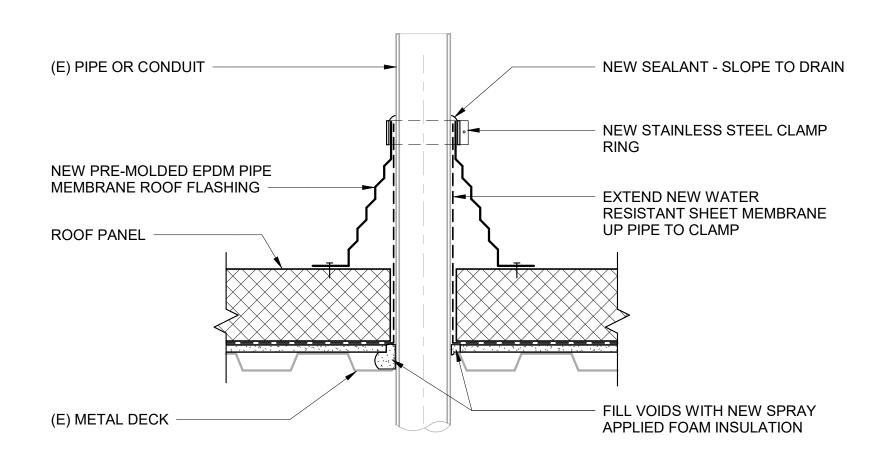



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METAL TRIM SUPPORT BY

24 GA PREFINISHED RAKE

DRILL 1" DIA ACCESS HOLES AT 8" O.C. IN (E)

DECK FOR SPRAY FOAM

SPRAY FOAM AT TOP OF

WRAP AIR-WATER BARRIER

OUTSIDE

METAL SIDING ON AIR-

GYP SHEATHING

FLASHING

WATER BARRIER ON 1/2"

INSIDE RESILIENT CLOSURE

24 GA PREFINISHED DRIP

CONTINUOUS SEALANT

RESILIENT CLOSURE

DOWN AND SEAL TO (E)

IMP SUPPLIER

INSTALLATION

DECK FLUTES

(E) FLASHING

ANGLE

(E) EIFS

FLASHING

GASKET HEAD SCREW

AT 8" O.C.

(E) ROOF DECK

(E) METAL STUDS AND INSULATION

TYPICAL RAKE FLASHING

SPRAY FOAM INSULATION

A504

REFER TO 3
FOR TYP
CALLOUTS

INSTALL SPRAY FOAM

FLUTES ABOVE DECK

4" MIN SPRAY FOAM

DECK

INSULATION - FILL UNDERSIDE OF ROOF

(E) INSULATED DUCT


CONSTRUCTION

PRIOR TO INSTALLING GYP COVERBOARD


INSULATION IN

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TYPICAL ROOF RAKE SECTION A504 1 1/2" = 1'-0"

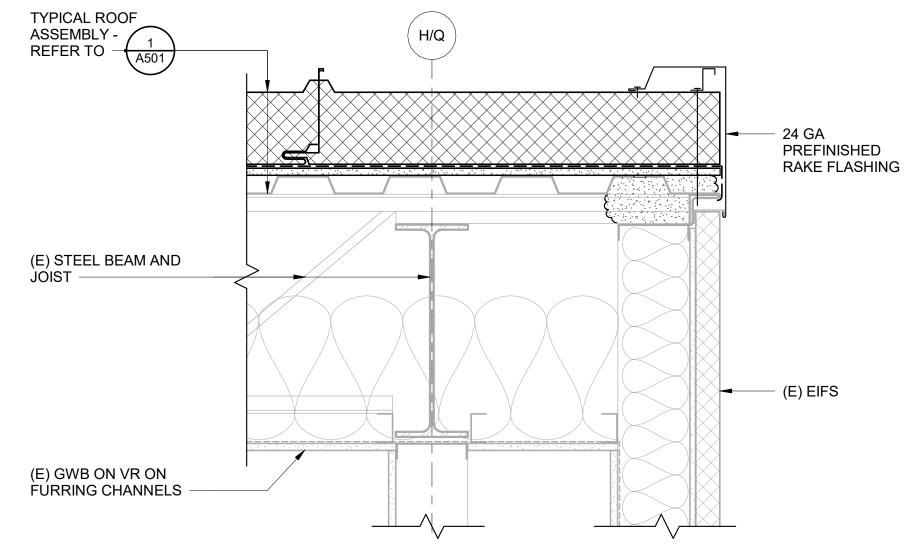

ROOF SECTION AT EXTERIOR SOFFIT

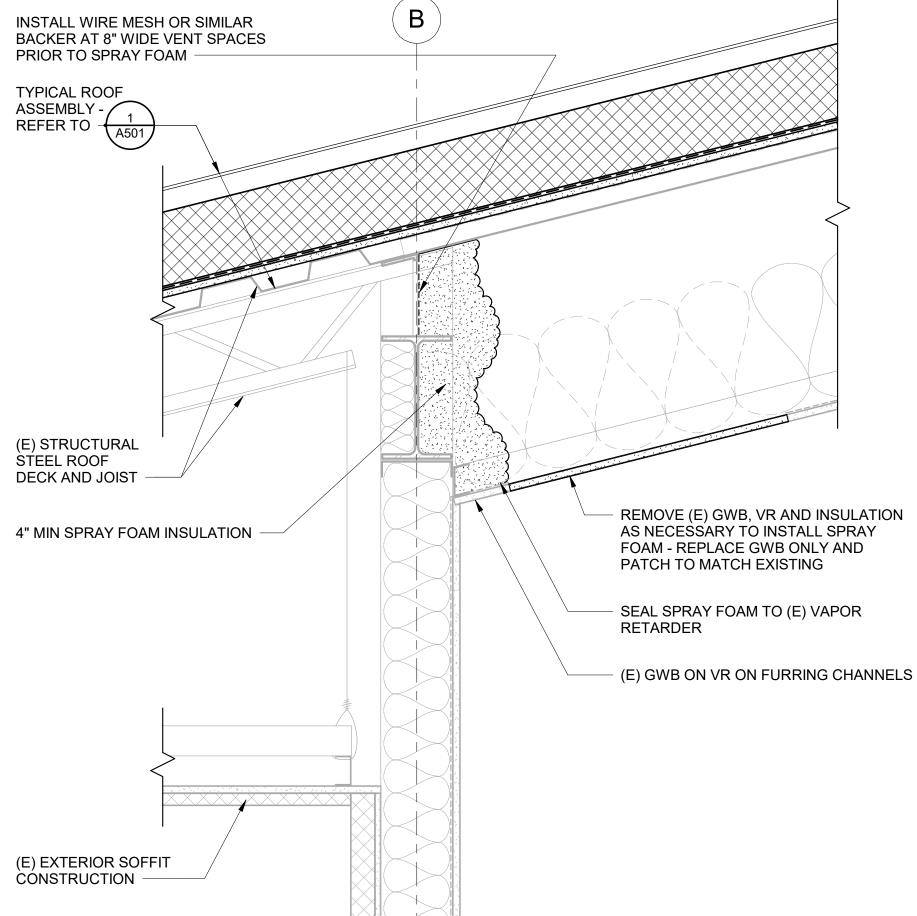

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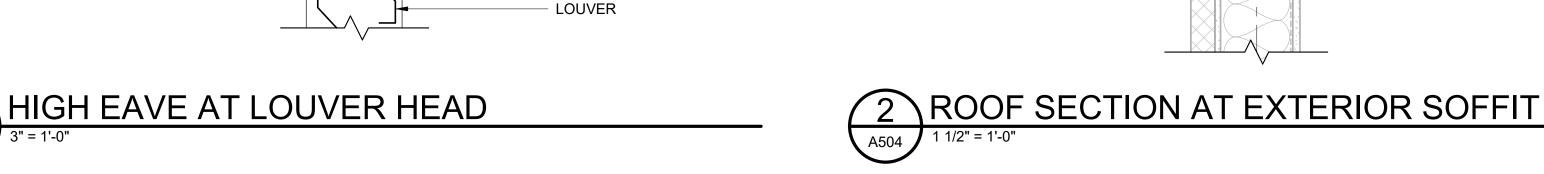
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DETAILS

SHEET NO. **A504**



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(E) CONSTRUCTION SHOWN SCREENED

ROOF TRANSITION AT GRID 8

PERMIT STAMP



RAKE FLASHING

(E) EIFS

LOUVER

A505

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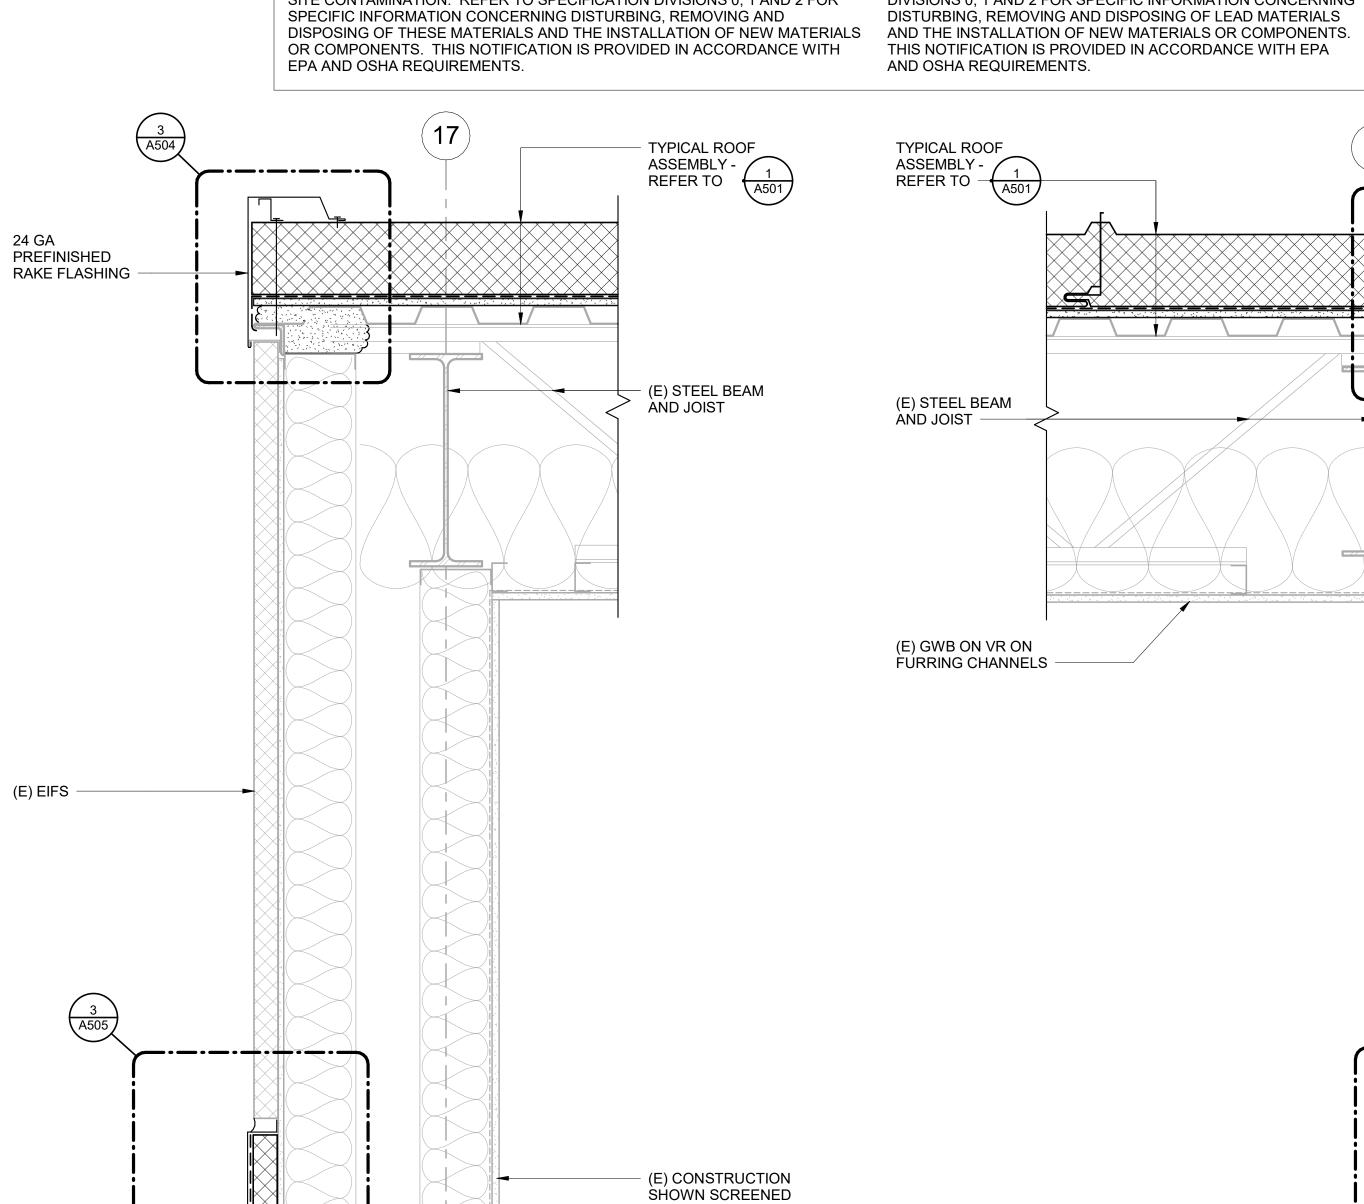
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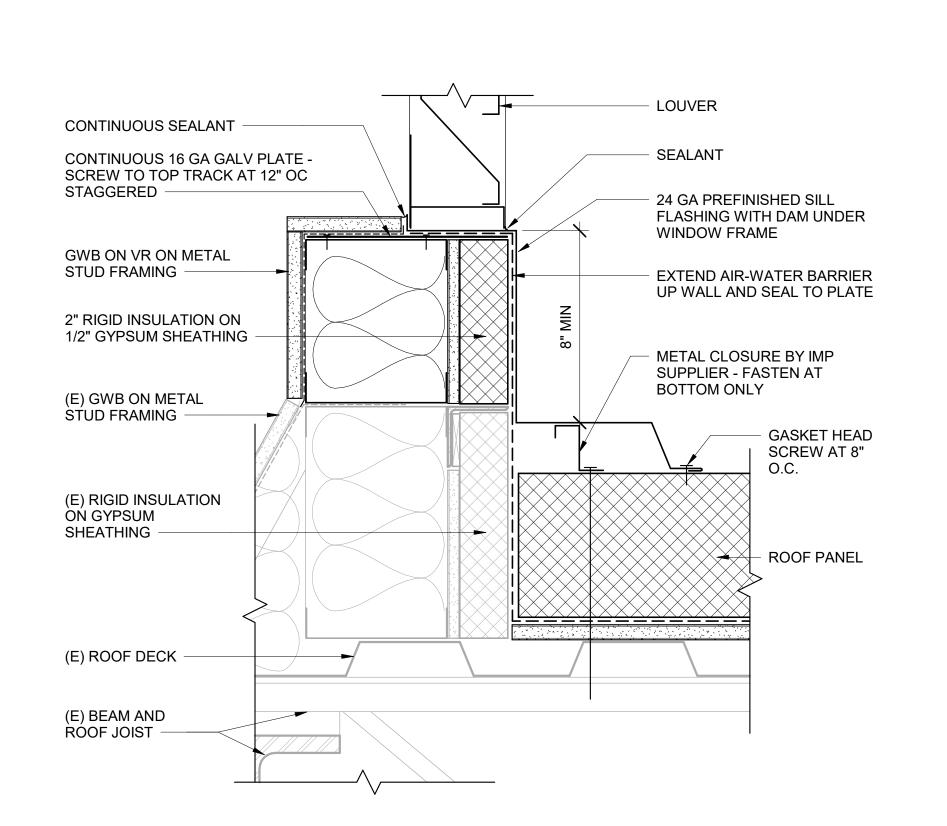
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Checker

DETAILS

SHEET NO. **A505**





SIDE WALL LOUVER SILL

CUT BACK (E) EIFS TO FACE OF

(E) INSULATION IN METAL

SHEATHING

SŤUDS

(E) EIFS

BACKER

CONTINUOUS SEALANT WITH

24 GA PREFINISHED FLASHING

3 ROOF AT SIDEWALL

METAL CLOSURE BY

GASKET HEAD SCREW AT 8" O.C.

IMP SUPPLIER






4 ANTENNA MAST MOUNT

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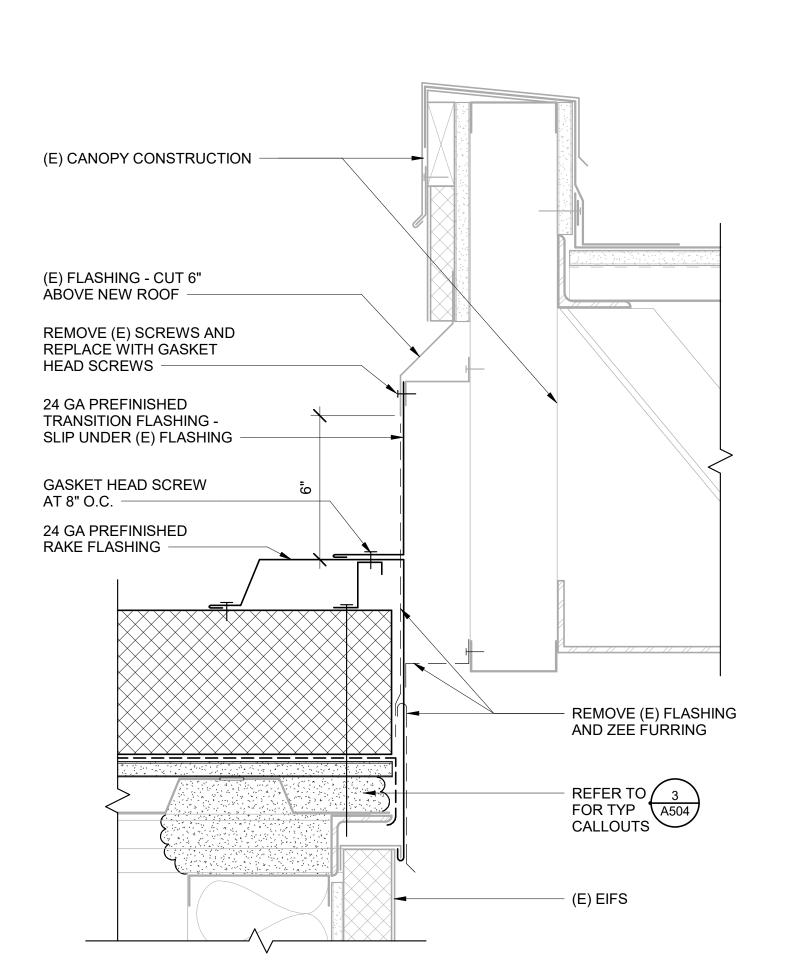
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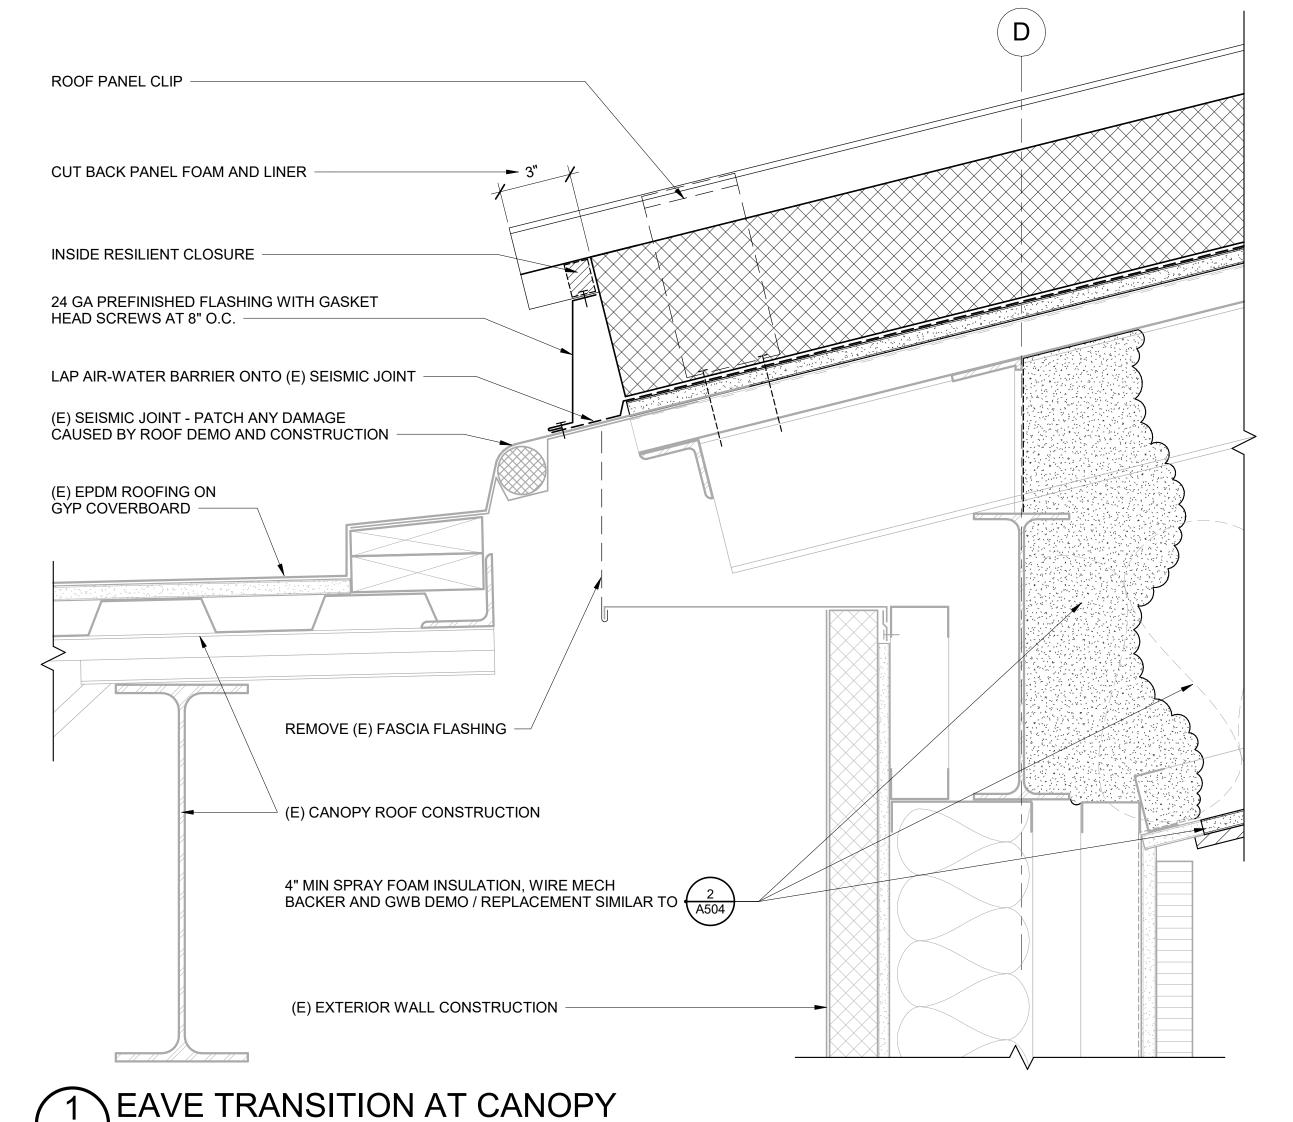


ROOF RAKE AT (E) CANOPY

3" = 1'-0"

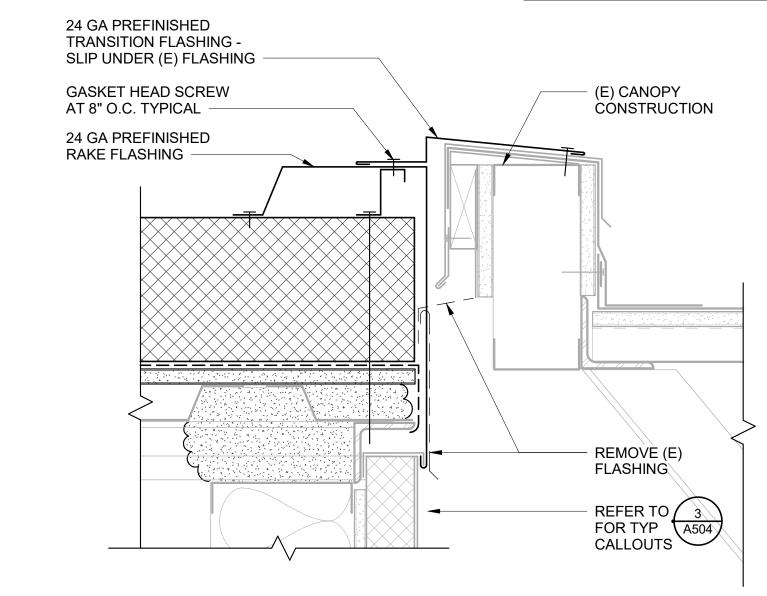





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02/14/2024

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DETAILS

SHEET NO.

A506

NOTIFICATION OF CHILD OCCUPIED FACILITY
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DISTURBING, REMOVING AND DISPOSING OF LEAD MATERIALS
AND THE INSTALLATION OF NEW MATERIALS OR COMPONENTS.
THIS NOTIFICATION IS PROVIDED IN ACCORDANCE WITH EPA
AND OSHA REQUIREMENTS.

PERMIT STAMP

ING LEGEND	LOGIC	A	BBR	EVIATIONS						
DENOTES DEMOLIT	ON POINT OF	CONNECTION AE	BV	ABOVE	DIA	DIAMETER	HP	HORSEPOWER	PH	PHASE
		AE	D	ACCESS DOOR	DIM	DIMENSION	HW	HOT WATER	RD-X	ROOF DRAIN DESIGNATOR
	X- DETAIL N	LIMBER AF	F	AIR FOIL	DN	DOWN	HWC	HOT WATER CIRCULATED	RL	RAINLEADER
VENT DIDING		AF	FF	ABOVE FINISHED FLOOR	DWG	DRAWING	IBC	INTERNATIONAL BUILDING CODE	RPM	REVOLUTIONS PER MINUTE
VENT PIPING	XX- SHEET LO		FG	ABOVE FINISHED GRADE	(E)	EXISTING EQUIPMENT DESIGNATOR	IN	INCHES	SP	STATIC PRESSURE
——————————————————————————————————————			FMS	AIR FLOW MONITORING STATION	E/A	EXHAUST AIR	INS.	INSULATION	SQ	SQUARE
XXX———————————————————————————————————	DIRECTIC	ON OF VIEW AF	HAP	AS HIGH AS POSSIBLE	EAT	ENTERING AIR TEMPERATURE	LAT	LEAVING AIR TEMPERATURE	TEMP	TEMPERATURE
PIPE UP	OF OTHER	AL		ALUMINUM	EFF	EFFICIENCY	LF	LINEAL FEET	TOD	TOP OF DUCT
	X SECTION	NUMBER	MPS	AMPERES	EF-X	EXHAUST FAN DESIGNATOR	LWT	LEAVING WATER TEMPERATURE	TSP	TOTAL STATIC PRESSURE
PIPE DOWN	XX- SHEET LO		PD	AIR PRESSURE DROP	EGT	ENTERING GLYCOL TEMPERATURE	MAX	MAXIMUM	T'STAT	THERMOSTAT
TEE UP		AF	RCH	ARCHITECTURAL	ENT	ENTERING	MBH	THOUSAND BTUH	TTL	TOTAL
TEE OI	,	B-		BOILER DESIGNATOR	ESP	EXTERNAL STATIC PRESSURE	MCA	MINIMUM CIRCUIT AMPACITY	TYP/TYP.	TYPICAL
TEE DOWN	X SHEET N		DD	BACKDRAFT DAMPER	EXIST	EXISTING	MFGR	MANUFACTURER	UPC	UNIFORM PLUMBING CODE
TEE DOWN		BL	LDG	BUILDING	EXH	EXHAUST	MIN/MIN.	MINIMUM	V	VENT
			OD	BOTTOM OF DUCT	F	FAHRENHEIT	MTD	MOUNTED	VAC	VOLT-AC
		BT	TUH	BRITISH THERMAL UNIT/HOUR	FCO	FLOOR CLEAN OUT	NC	NOISE CRITERIA	VEL	VELOCITY
CLEANOUT	DUCTWORK LEGE		AP	CAPACITY	FIN	FINISHED	NO.	NUMBER	VDC	VOLT-DC
I OLLANOOT			FM	CUBIC FEET PER MINUTE	FLA	FULL LOAD AMPS	NTS	NOT TO SCALE	VTR	VENT THRU ROOF
		CI	IRC	CIRCULATING	FLR	FLOOR	O/A	OUTSIDE AIR	W	WASTE
FLOOR CLEANOUT	SUPPLY A	AIR UP & DOWN CL	LG	CEILING	FT	FEET	O.D.	OUTSIDE DIAMETER	W/	WITH
		((ONT	CONTINUED	G	NATURAL GAS	OC	ON CENTER	W/O	WITHOUT
() ROOF DRAIN			.O./CO	CLEANOUT	GAL	GALLONS	OD	OUTSIDE DAMPER	W.C.	WATER COLUMN
ROOF BRAIN		AIR UP & DOWN	ONN	CONNECTION	GALV	GALVANIZED	OD-X	OVERFLOW DRAIN DESIGNATOR	WCO	WALL CLEAN OUT
		Cl		COPPER	GPM	GALLONS PER MINUTE	OL	OVERFLOW RAINLEADER	WHA	WATER HAMMER ARRESTOR
DETAILED PIPE UP	R DOWN	CV		COLD WATER	GT-X	GLYCOL TANK DESIGNATOR	P-X	PLUMBING FIXTURE DESIGNATOR	WPD	WATER PRESSURE DROP
		dB		DECIBELS	GTD	GLYCOL TEMPERATURE DROP	PD	PRESSURE DROP	YCO	YARD CLEAN OUT
	$ \hspace{.06cm}\rangle\hspace{.06cm} \hspace{.06cm}\rangle\hspace{.06cm} \hspace{.06cm}\rangle\hspace{.06cm} \hspace{.06cm}\rangle\hspace{.06cm}\rangle\hspace{.06cm} \hspace{.06cm}\rangle\hspace{.06cm} \hspace{.06cm}\rangle\hspace{.06cm}\rangle\hspace{.06cm} \hspace{.06cm}\rangle\hspace{.06cm}\rangle\hspace{.06cm} \hspace{.06cm}\rangle$	AIR UP & DOWN DE	EG	DEGREE	HD	HEAD	PG/P.G.	PROPYLENE GLYCOL		

FINTUBE RADIATION SCHEDULE															
					ELEMENT		FIN				EWT	LWT	EAT		
SYMB	OL MANUFA	ACTURER	MODEL	# ROWS	MODEL	SIZE	MATERIAL	FPF (GPM	MEDIUM	DEG F	DEG F	DEG F	BTUH/LF	REMARKS
FT-1	RITTLIN	lG	BG-20	1		4-1/4"x4-1/4"	ALUMINUM	48 F	PER PLANS	WATER	180	160	65	1,427	20" TALL FLAT TOP ENCLOSURE, LOUVERED TOP OUTLET, CUSTOM CURVED ENCLOSURE TO MATCH WALL.


ROOF HOOD	CCHEDIII	⊏			
ROOF HOOD	SCHEDUL				
SYMBOL MANUFACTURER	MODEL	SERVICE	MATERIAL	FINISH	THROAT (IN.) REMARKS
RH-1 GREENHECK	FGR-22x22	KITCHEN	ALUMINUM	MILL	22"x22" INTEGRAL 1/2" BIRDSCREEN, PROVIDE WITH GRAVITY BACKDRAFT DAMPER

LO	UVER SCH	HEDULE					
SYMBOL	MANUFACTURER	MODEL	SERVICE	MATERIAL	FINISH	SIZE (IN.)	REMARKS
L-1	RUSKIN	ELF-6375-DX	INTAKE	ALUMINUM	PER ARCH	PER PLANS	6" DEEP, DRAINABLE BLADES, FINISH COLOR PER ARCH.
L-2	RUSKIN	ELF-6375-DX	EXHAUST	ALUMINUM	PER ARCH	PER PLANS	6" DEEP, DRAINABLE BLADES, FINISH COLOR PER ARCH.

FOR:
SUBMITTAL
PRICING

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ANCHORAGE SCHOOL DISTRICT

SPRING HILL ELEMENTARY SCHOOL ROOF REPLACEMENT

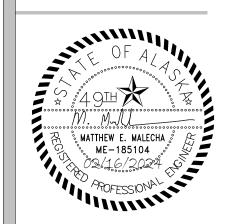9911 LAKE OTIS PKWY ANCHORAGE, AK

100% PERMIT DOCUMENTS

M3177	JOB NO.
02/14/2024	DATE:
MEM	PROJ. MGR.:
JMC	DRAWN BY:
DRM	REVIEWED BY:
	REVISIONS:

MECHANICAL LEGEND, ABBREVIATIONS, AND SCHEDULES

GENERAL NOTES:

10'-0"

'3'-6"'

NOT TO SCALE

LOUVER DEMOLITION ELEVATION #1

- THE INFORMATION SHOWN ON THIS DRAWING IS TAKEN FROM A NON-DESTRUCTIVE WALK-THROUGH OF THE FACILITY. THERE IS NO WARRANTY OR GUARANTEE AS TO THE ACCURACY OF THE INFORMATION SHOWN HEREIN. THE CONTRACTOR SHALL FIELD VERIFY ALL ITEMS SHOWN FOR DEMOLITION PRIOR TO START OF WORK.
- B. THE OWNER SHALL HAVE FIRST RIGHT OF REFUSAL ON ALL SALVAGEABLE MATERIALS. THE CONTRACTOR SHALL DELIVER SALVAGED MATERIALS TO A LOCATION AS DIRECTED BY THE OWNER IN ACCORDANCE WITH THE CONTRACT DOCUMENTS.
- C. DASHED OR DOTTED BOLD LINES INDICATE ITEMS TO BE REMOVED. UNBOLDED LINES INDICATE EXISTING ITEMS TO REMAIN.

NOTIFICATION OF POTENTIAL HAZARD
ASBESTOS, LEAD AND OTHER POTENTIALLY HAZARDOUS MATERIALS ARE
PRESENT IN THE BUILDING THAT MAY IMPACT THE WORK OF ALL TRADES.
REGULATED AIR CONTAMINANTS, INCLUDING ASBESTOS AND LEAD, ARE ALSO
PRESENT IN SETTLED AND CONCEALED DUST IN AND ON ARCHITECTURAL,
STRUCTURAL, MECHANICAL AND ELECTRICAL COMPONENTS OR SYSTEMS
THROUGHOUT THE BUILDING. ALL TRADES SHALL COORDINATE WITH OTHER
TRADES AND CONDUCT THEIR WORK TO PREVENT WORKER EXPOSURE OR
SITE CONTAMINATION. REFER TO SPECIFICATION DIVISIONS 0, 1 AND 2 FOR
SPECIFIC INFORMATION CONCERNING DISTURBING, REMOVING AND
DISPOSING OF THESE MATERIALS AND THE INSTALLATION OF NEW MATERIALS
OR COMPONENTS. THIS NOTIFICATION IS PROVIDED IN ACCORDANCE WITH
EPA AND OSHA REQUIREMENTS.

NOTIFICATION OF CHILD OCCUPIED FACILITY
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PERMIT STAMP

SHEET NOTES:

- 1. DEMOLISH ROOF DRAIN AND ASSOCIATED RAINLEADER PIPING.
- . DEMOLISH VTR DOWN TO 12" BELOW ROOF DECK. EXISTING VENT PIPING BELOW SHALL REMAIN FOR RECONNECTION DURING REMODEL.
- DEMOLISH FUEL OIL TANK VENT TO EXTENT NECESSARY TO ACCOMMODATE REMODEL WORK. EXISTING FUEL TANK VENT PIPING BELOW FLAT ROOF SHALL REMAIN FOR RECONNECTION DURING REMODEL.
- 4. DEMOLISH 24/24 TYPE II KITCHEN EXHAUST HOOD AND ROOF CURB. EXISTING TYPE II KITCHEN EXHAUST DUCTWORK BELOW SHALL REMAIN FOR RECONNECTION DURING REMODEL.
- 5. DEMOLISH EXISTING GENERATOR EXHAUST PIPE DOWN TO 12" BELOW ROOF DECK. EXISTING GENERATOR EXHAUST PIPING BELOW SHALL REMAIN FOR RECONNECTION DURING REMODEL.
- DEMOLISH BOILER FLUE CURB. DISASSEMBLE BOILER FLUE THROUGH ROOF AND SALVAGE FOR REINSTALLATION.
- DEMOLISH WATER HEATER ROOF CURB AND PVC WATER HEATER FLUE IN ITS ENTIRETY.
- DEMOLISH OUTSIDE AIR AND RELIEF AIR LOUVERS, EXISTING DUCTWORK INSIDE BUILDING TO REMAIN FOR RECONNECTION.

MATTHEW E. MALECHA

ME – 185104

AOFESSIONA

FOR:

SUBMITTAL

MCG

EXPLORE

421 West 1st Avenue, Suite 300

907.563.8474 | F 907.563.4572

Anchorage, Alaska 99501

DESIGN

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PRICING

ANCHORAGE SCHOOL DISTRICT

SPRING HILL ELEMENTARY SCHOOL ROOF REPLACEMENT


9911 LAKE OTIS PKWY

100% PERMIT DOCUMENTS

ANCHORAGE, AK

JOB NO.	M3177
DATE:	02/14/2024
PROJ. MGR.:	MEM
DRAWN BY:	JMC
REVIEWED BY:	DRM
REVISIONS:	

MECHANICAL DEMOLITION ROOF PLAN

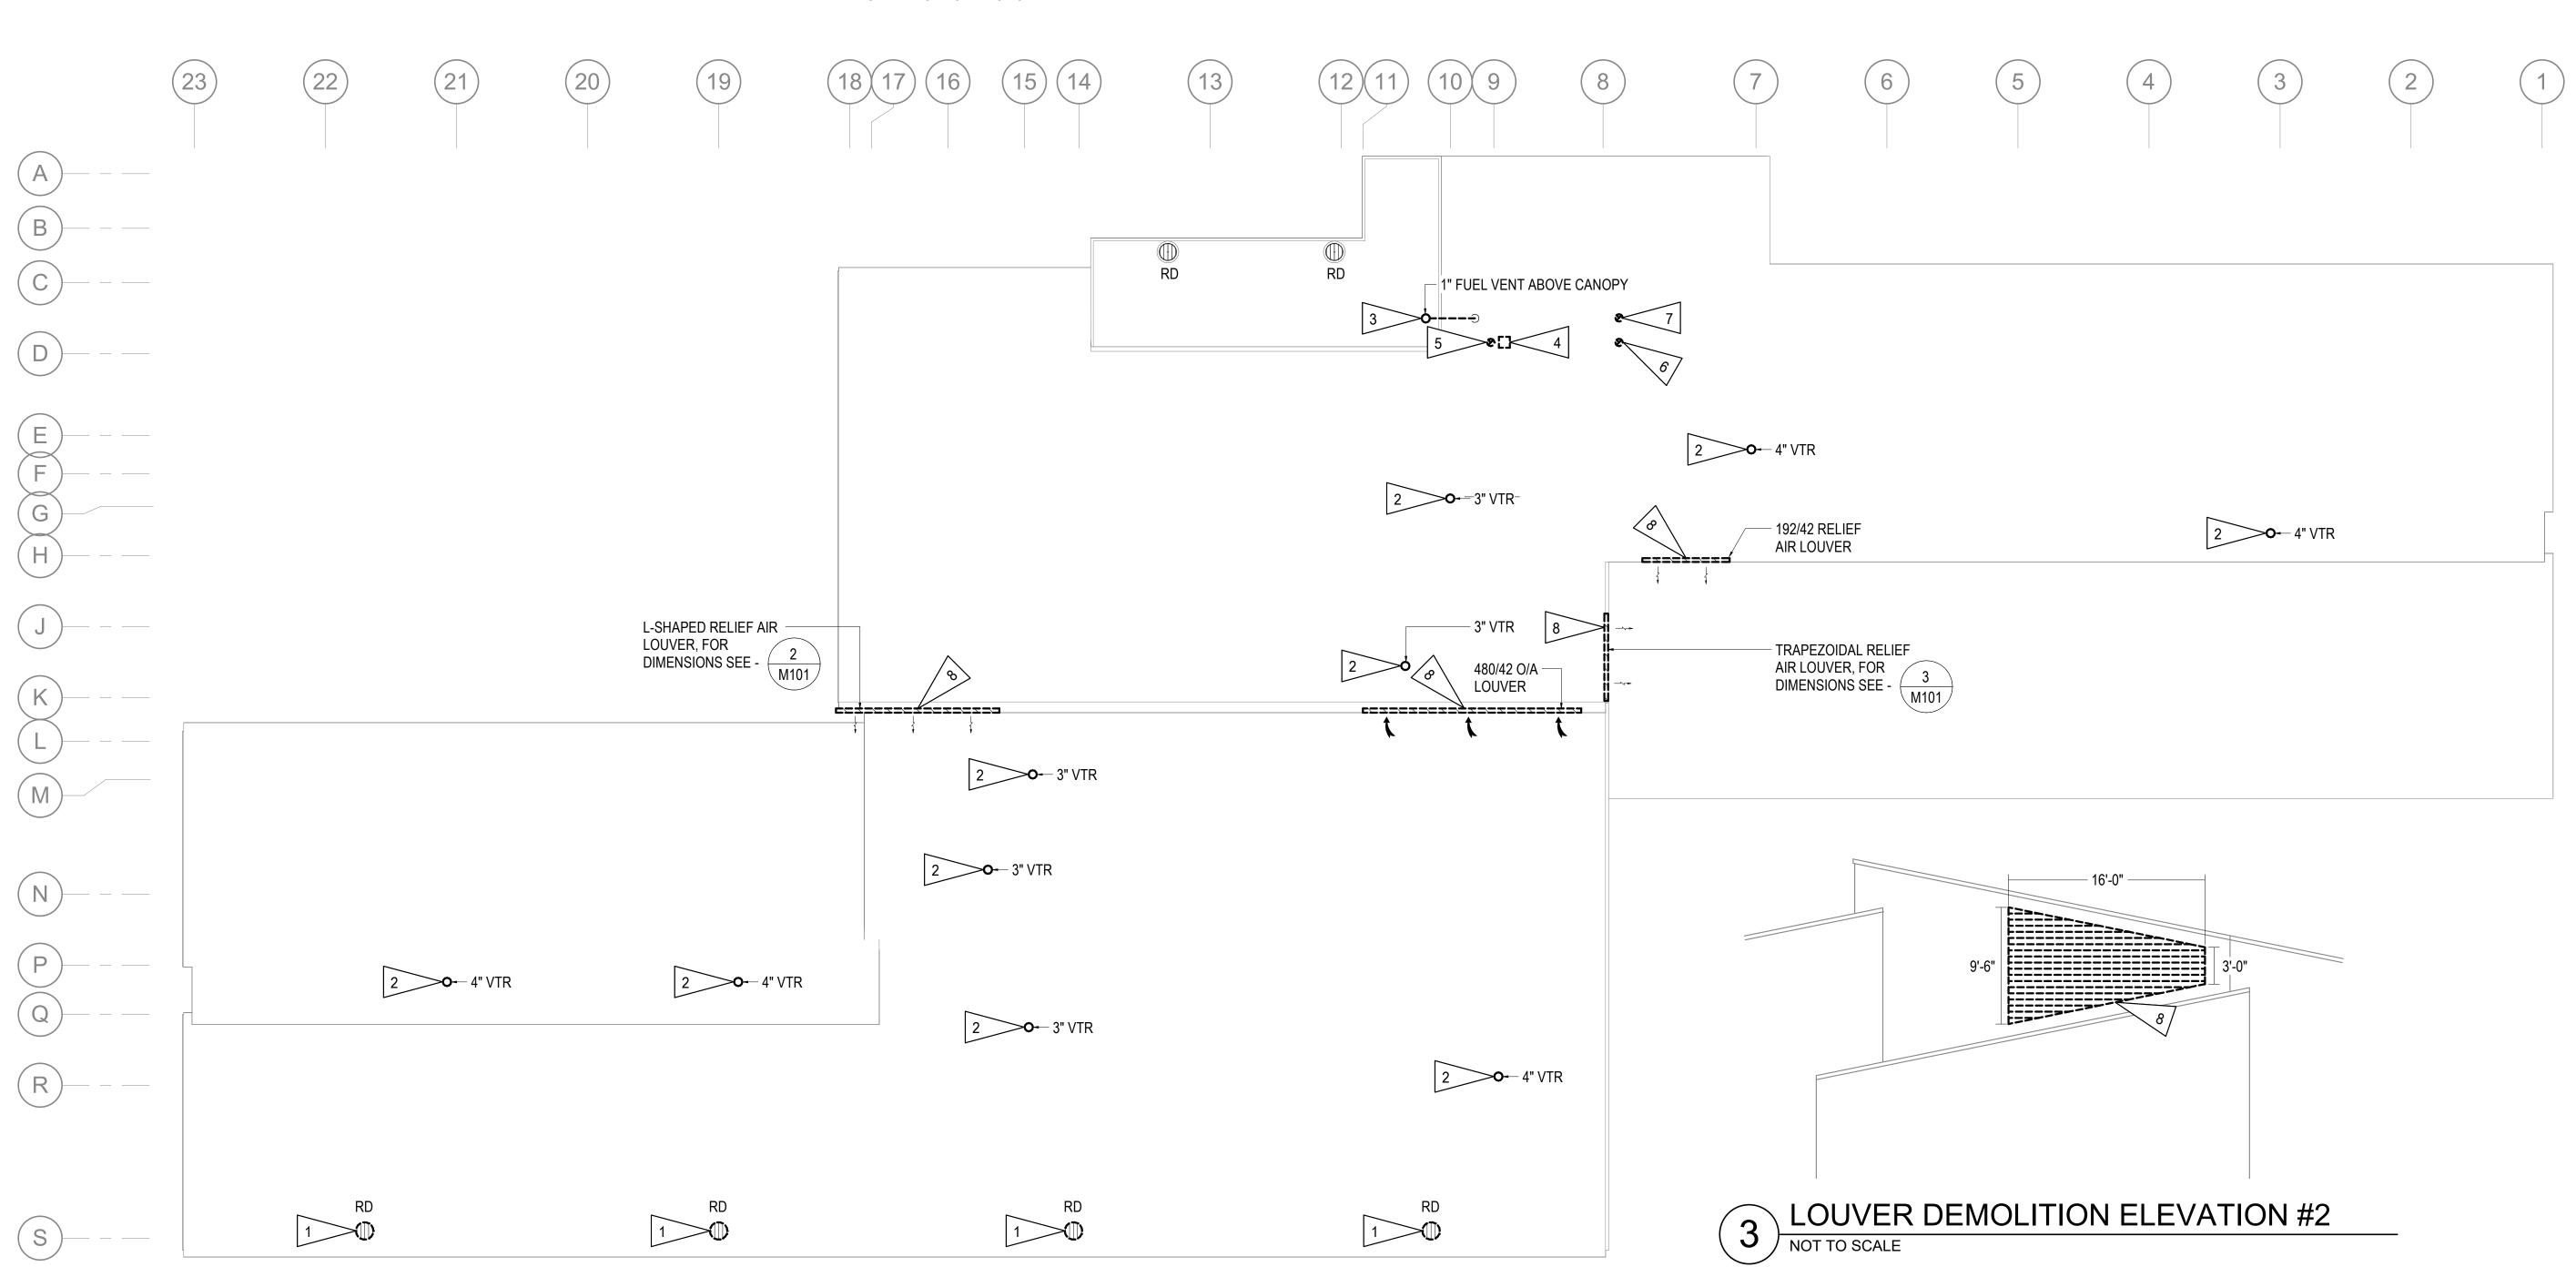

NOTIFICATION OF CHILD OCCUPIED FACILITY
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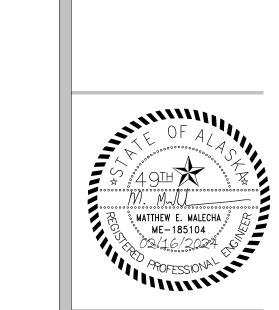
PERMIT STAMP

GENERAL NOTES:

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- C. DASHED OR DOTTED BOLD LINES INDICATE ITEMS TO BE REMOVED. UNBOLDED LINES INDICATE EXISTING ITEMS TO REMAIN.

SHEET NOTES:

- DEMOLISH ROOF DRAIN DRAIN AND RAINLEADER PIPING ABOVE CEILING. CAP ABANDONED RAINLEADER PIPING IN CEILING. EXISTING RAINLEADER PIPING THROUGH WALL AND BELOW GRADE SHALL BE ABANDONED IN PLACE.
- 2. DEMOLISH VTR DOWN TO 12" BELOW ROOF DECK. EXISTING VENT PIPING SHALL REMAIN FOR RECONNECTION DURING REMODEL.



MCG EXPLORE

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Anchorage, Alaska 99501

DESIGN

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SUBMITTAL

PRICING

ANCHORAGE SCHOOL DISTRICT

SPRING HILL ELEMENTARY SCHOOL ROOF REPLACEMENT


9911 LAKE OTIS PKWY ANCHORAGE, AK


100% PERMIT DOCUMENTS

JOB NO.	M3177
DATE:	02/14/2024
PROJ. MGR.:	MEM
DRAWN BY:	JMC
REVIEWED BY:	DRM
REVISIONS:	

MECHANICAL DEMOLITION ROOF PLAN -AREA A

SHEET NO.
M102

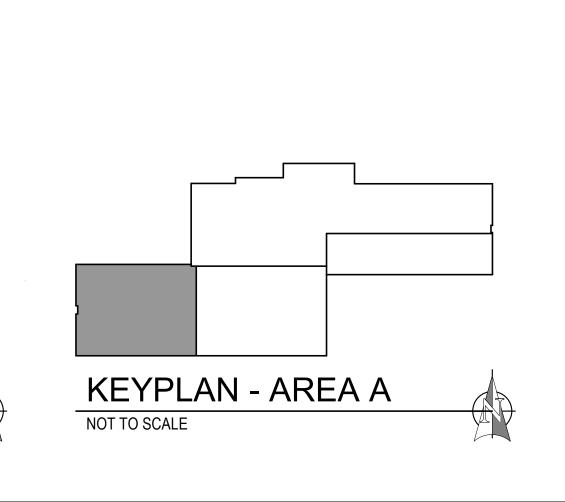

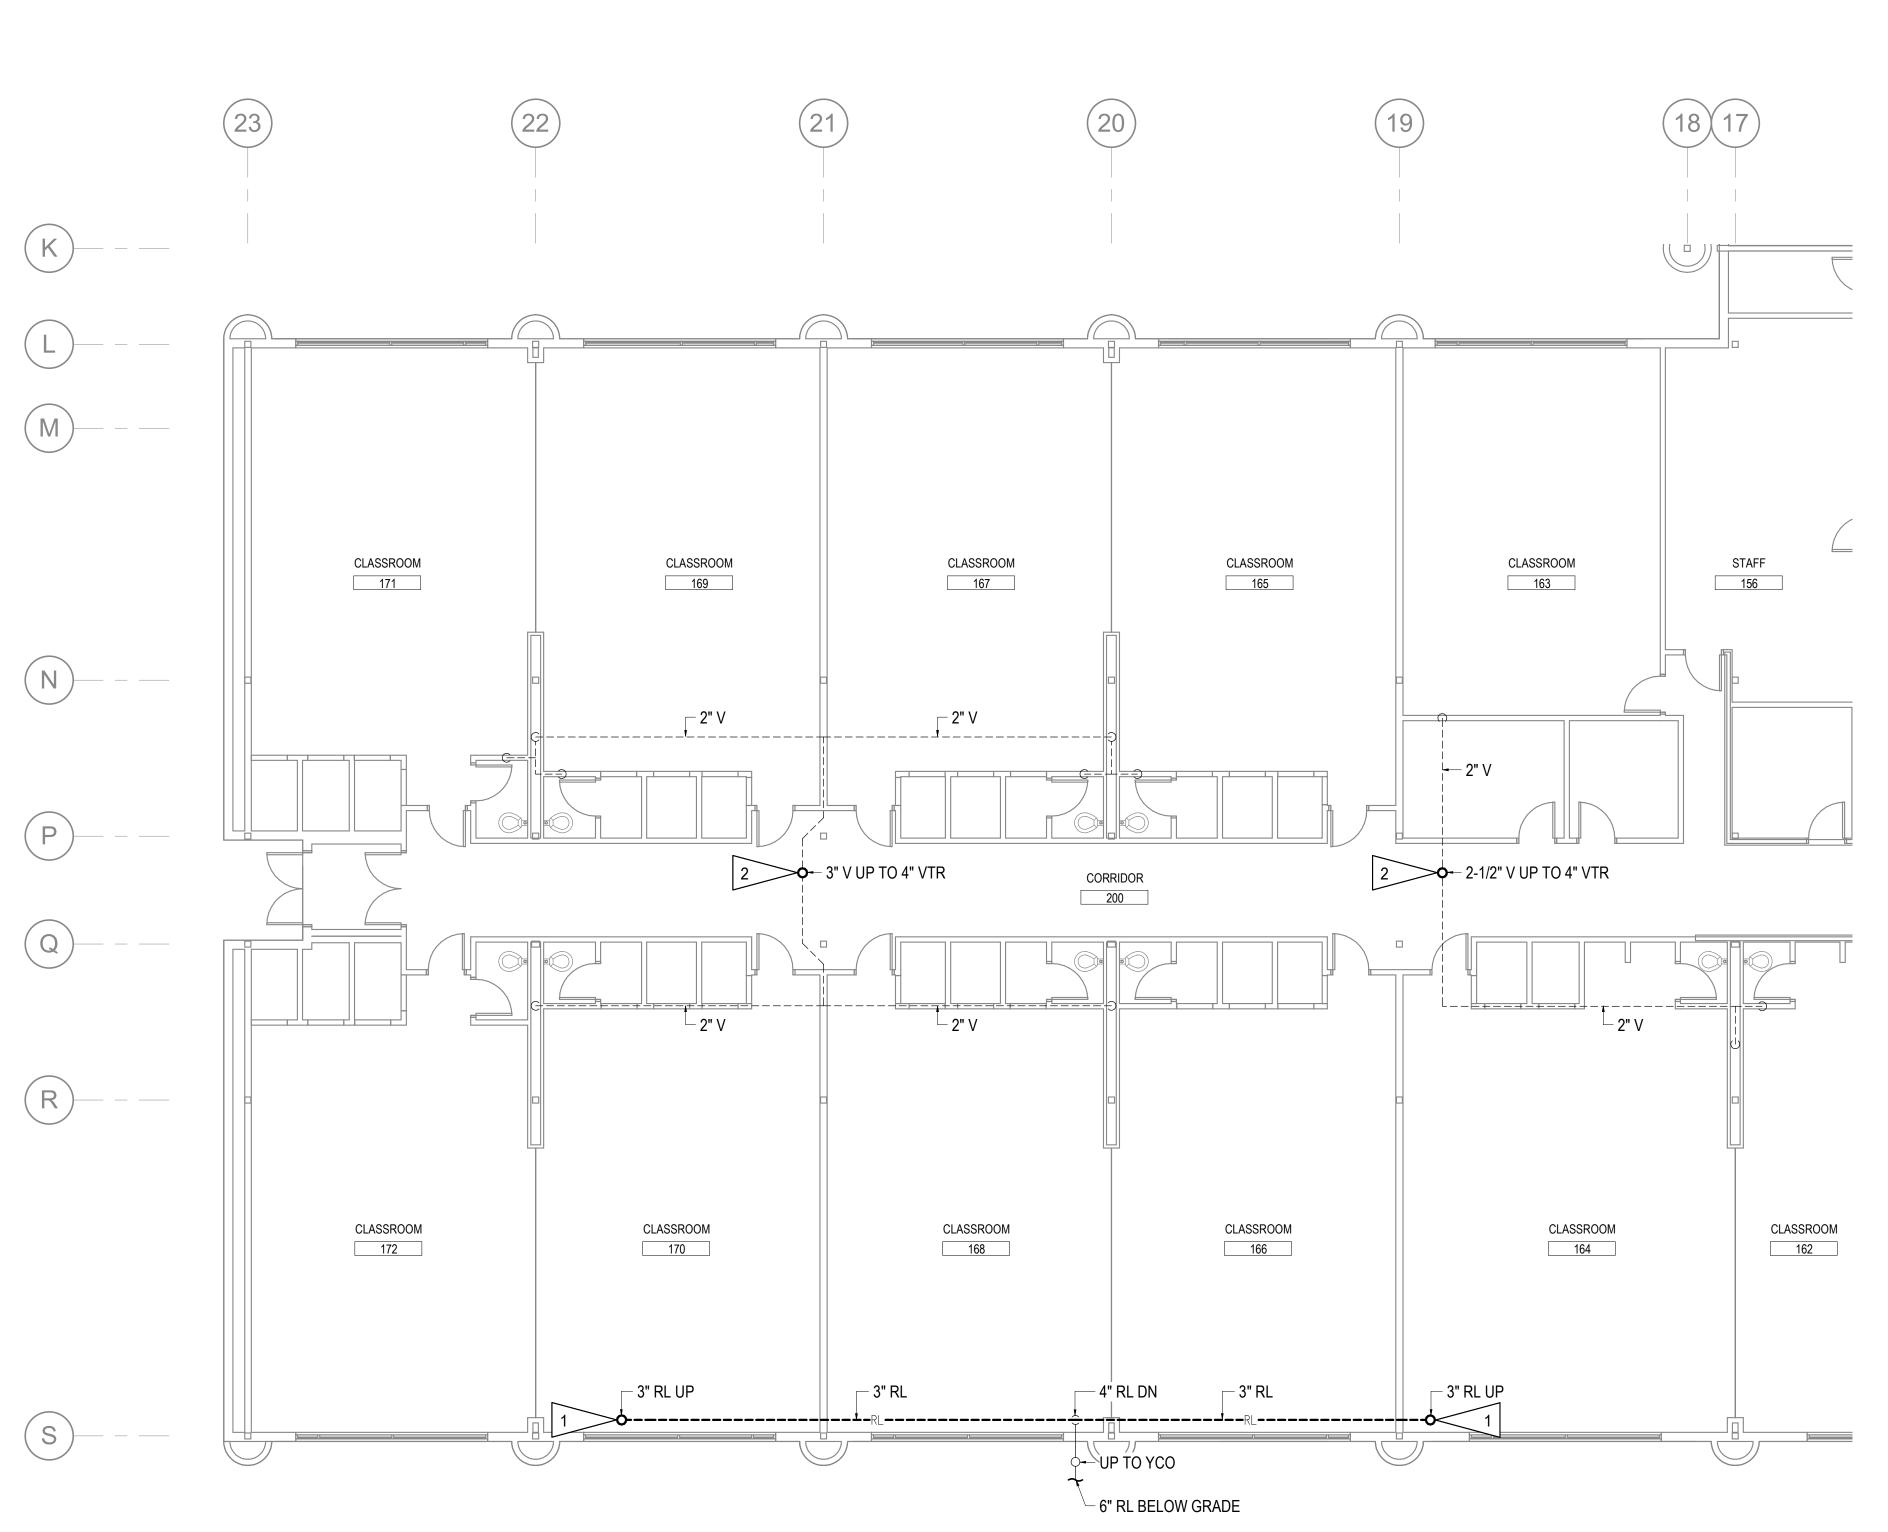

1 MECHANICAL DEMOLITION PLAN - AREA A

NOTIFICATION OF CHILD OCCUPIED FACILITY
PORTIONS OF THIS BUILDING ARE CLASSIFIED AS A CHILD
OCCUPIED FACILITY IN ACCORDANCE WITH 40 CFR 745 AND
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PERMIT STAMP

GENERAL NOTES:

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SHEET NOTES:


- DEMOLISH ROOF DRAIN DRAIN AND RAINLEADER PIPING ABOVE CEILING. CAP ABANDONED RAINLEADER PIPING IN CEILING. EXISTING RAINLEADER PIPING THROUGH WALL AND BELOW GRADE SHALL BE ABANDONED IN PLACE.
- 2. DEMOLISH VTR DOWN TO 12" BELOW ROOF DECK. EXISTING VENT PIPING SHALL REMAIN FOR RECONNECTION DURING REMODEL.



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PRICING

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ANCHORAGE SCHOOL DISTRICT

SPRING HILL ELEMENTARY SCHOOL ROOF REPLACEMENT

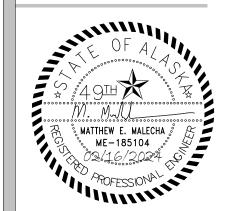
9911 LAKE OTIS PKWY ANCHORAGE, AK

100% PERMIT DOCUMENTS

JOB NO.	M3177
DATE:	02/14/2024
PROJ. MGR.:	MEM
DRAWN BY:	JMC
REVIEWED BY:	DRM
REVISIONS:	

MECHANICAL DEMOLITION ROOF PLAN -AREA B

SHEET NO. **M103**

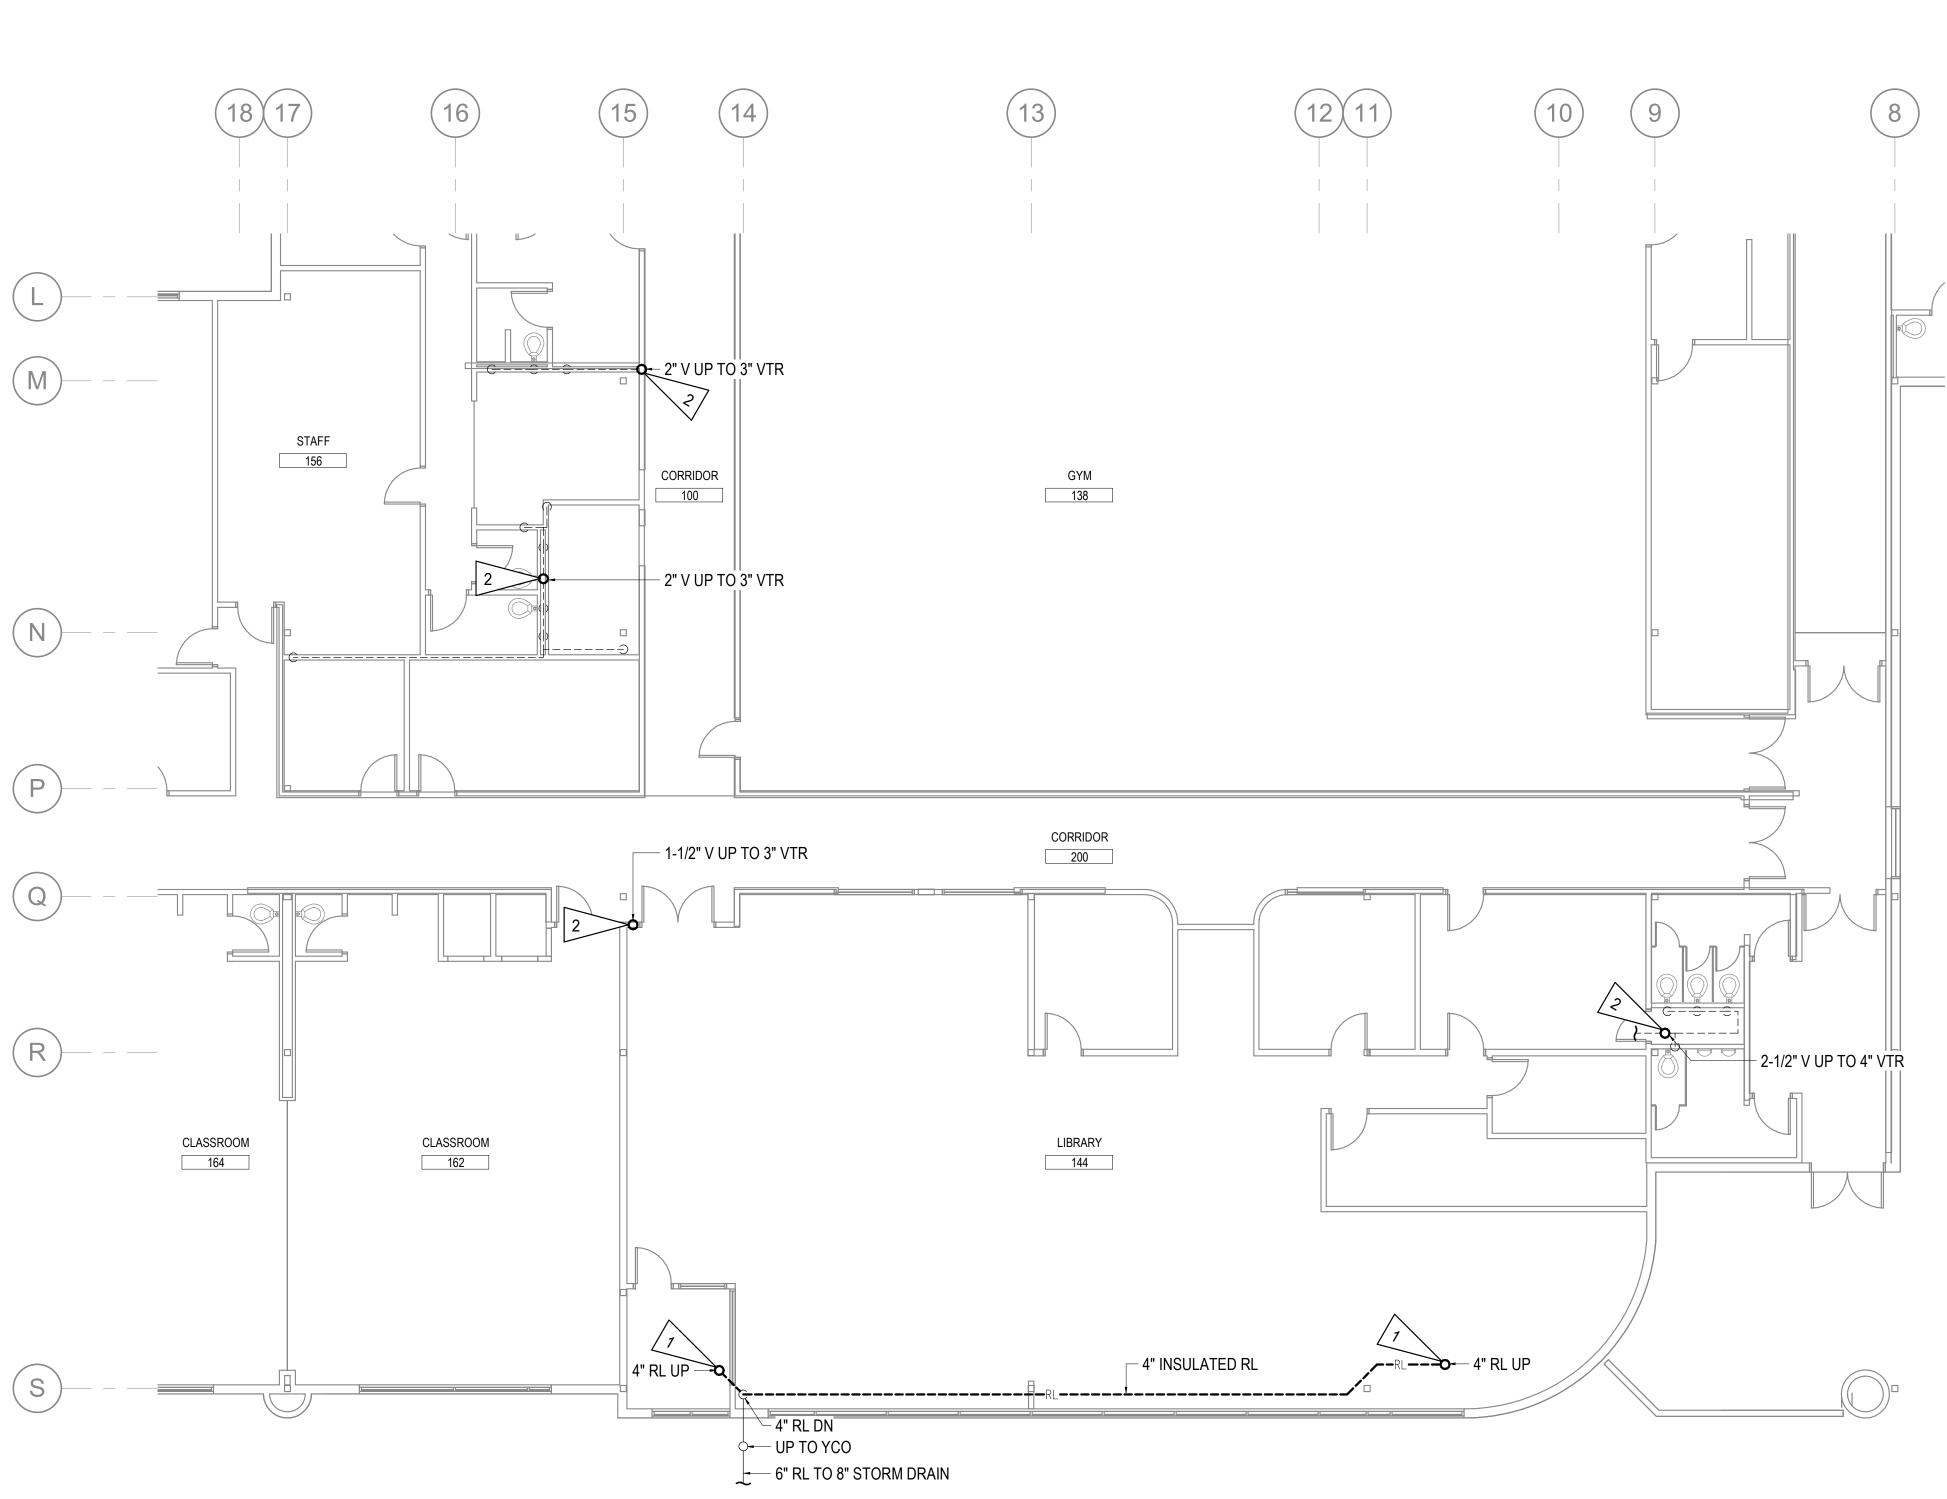

MECHANICAL DEMOLITION PLAN - AREA B

1/8" = 1'-0"

KEYPLAN - AREA B

NOT TO SCALE

(9)

8


NOTIFICATION OF CHILD OCCUPIED FACILITY PORTIONS OF THIS BUILDING ARE CLASSIFIED AS A CHILD OCCUPIED FACILITY IN ACCORDANCE WITH 40 CFR 745 AND LEAD-BASED PAINTS MAY BE PRESENT ON COMPONENTS TO BE DISTURBED IN THOSE AREAS. PERSONNEL PERFORMING WORK IN THESE AREAS MUST COMPLY WITH THE REQUIREMENTS OF 40 CFR 745, INCLUDING TRAINING, WORK PRACTICES AND CLEANING OF THE WORK AREA. REFER TO SPECIFICATION DIVISIONS 0, 1 AND 2 FOR SPECIFIC INFORMATION CONCERNING DISTURBING, REMOVING AND DISPOSING OF LEAD MATERIALS AND THE INSTALLATION OF NEW MATERIALS OR COMPONENTS. THIS NOTIFICATION IS PROVIDED IN ACCORDANCE WITH EPA AND OSHA REQUIREMENTS.

PERMIT STAMP

- EXISTING RAINLEADER PIPING UP TO EXISTING ROOF DRAINS TO
- DEMOLISH VTR DOWN TO 12" BELOW ROOF DECK. EXISTING VENT PIPING BELOW SHALL REMAIN FOR RECONNECTION DURING REMODEL
- DEMOLISH FINTUBE ENCLOSURE, PIPING, AND VALVES AS INDICATED. EXISTING HEATING MAINS ABOVE CEILING TO REMAIN FOR

GENERAL NOTES:

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REOCNNECITON.

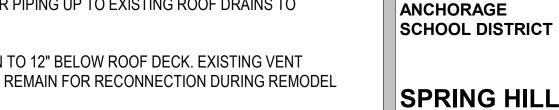9911 LAKE OTIS PKWY ANCHORAGE, AK

FOR:

SUBMITTAL

MCG EXPLORE

DESIGN

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MATTHEW E. MALECHA & B. ME-185104 & ME-185

ELEMENTARY

REPLACEMENT

SCHOOL

ROOF

Anchorage, Alaska 99501

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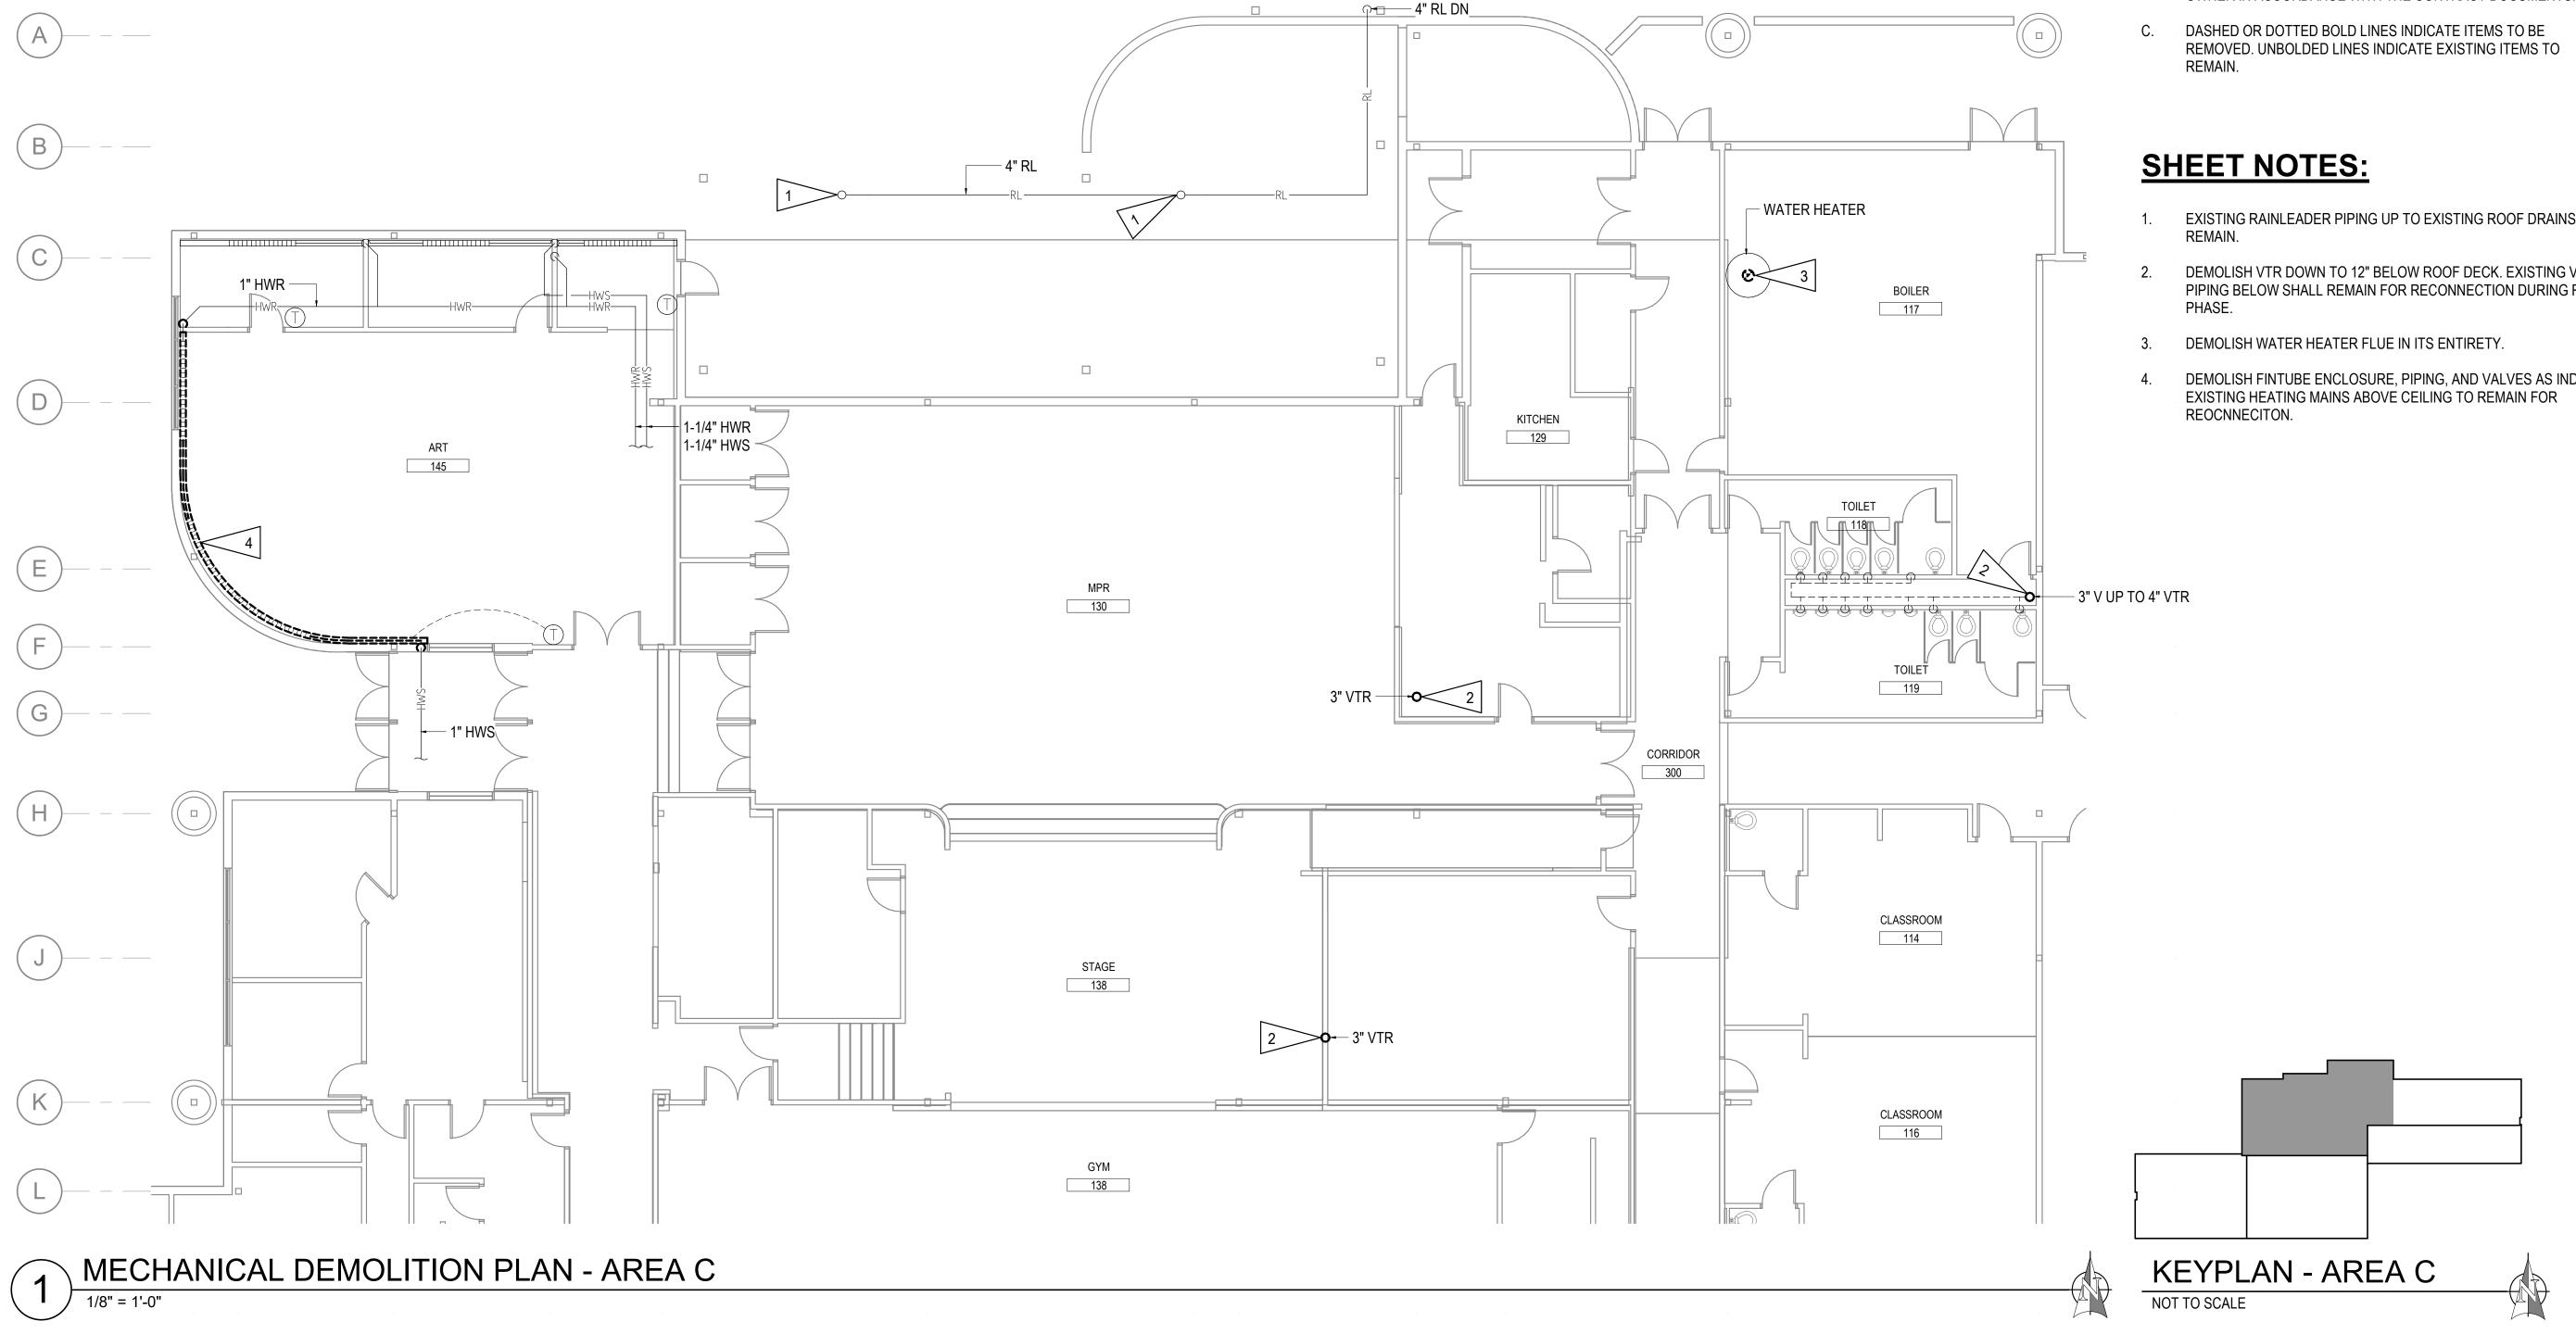
PRICING

100% PERMIT DOCUMENTS

M3177	JOB NO.
02/14/2024	DATE:
MEM	PROJ. MGR.:
JMC	DRAWN BY:
DRM	REVIEWED BY:
	DEVISIONS:

MECHANICAL DEMOLITION **ROOF PLAN -**AREA C

> SHEET NO. M104



(16)

(14)

(13)

NOTIFICATION OF CHILD OCCUPIED FACILITY PORTIONS OF THIS BUILDING ARE CLASSIFIED AS A CHILD OCCUPIED FACILITY IN ACCORDANCE WITH 40 CFR 745 AND LEAD-BASED PAINTS MAY BE PRESENT ON COMPONENTS TO BE DISTURBED IN THOSE AREAS. PERSONNEL PERFORMING WORK IN THESE AREAS MUST COMPLY WITH THE REQUIREMENTS OF 40 CFR 745. INCLUDING TRAINING, WORK PRACTICES AND CLEANING OF THE WORK AREA. REFER TO SPECIFICATION DIVISIONS 0, 1 AND 2 FOR SPECIFIC INFORMATION CONCERNING DISTURBING, REMOVING AND DISPOSING OF LEAD MATERIALS AND THE INSTALLATION OF NEW MATERIALS OR COMPONENTS. THIS NOTIFICATION IS PROVIDED IN ACCORDANCE WITH EPA AND OSHA REQUIREMENTS.

FOR: SUBMITTAL PRICING

PERMIT STAMP

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SHEET NOTES:

DEMOLISH VTR DOWN TO 12" BELOW ROOF DECK. EXISTING VENT PIPING BELOW SHALL REMAIN FOR RECONNECTION DURING REMODEL PHASE.

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ANCHORAGE SCHOOL DISTRICT

SPRING HILL ELEMENTARY SCHOOL ROOF REPLACEMENT


9911 LAKE OTIS PKWY ANCHORAGE, AK


100% PERMIT DOCUMENTS

JOB NO.	M3177
DATE:	02/14/2024
PROJ. MGR.:	MEM
DRAWN BY:	JMC
REVIEWED BY:	DRM
REVISIONS:	

MECHANICAL DEMOLITION ROOF PLAN -AREA D

SHEET NO. M105

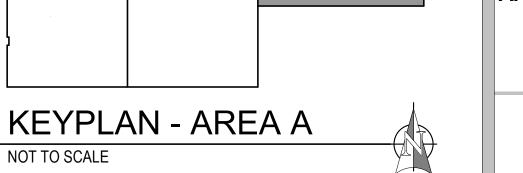

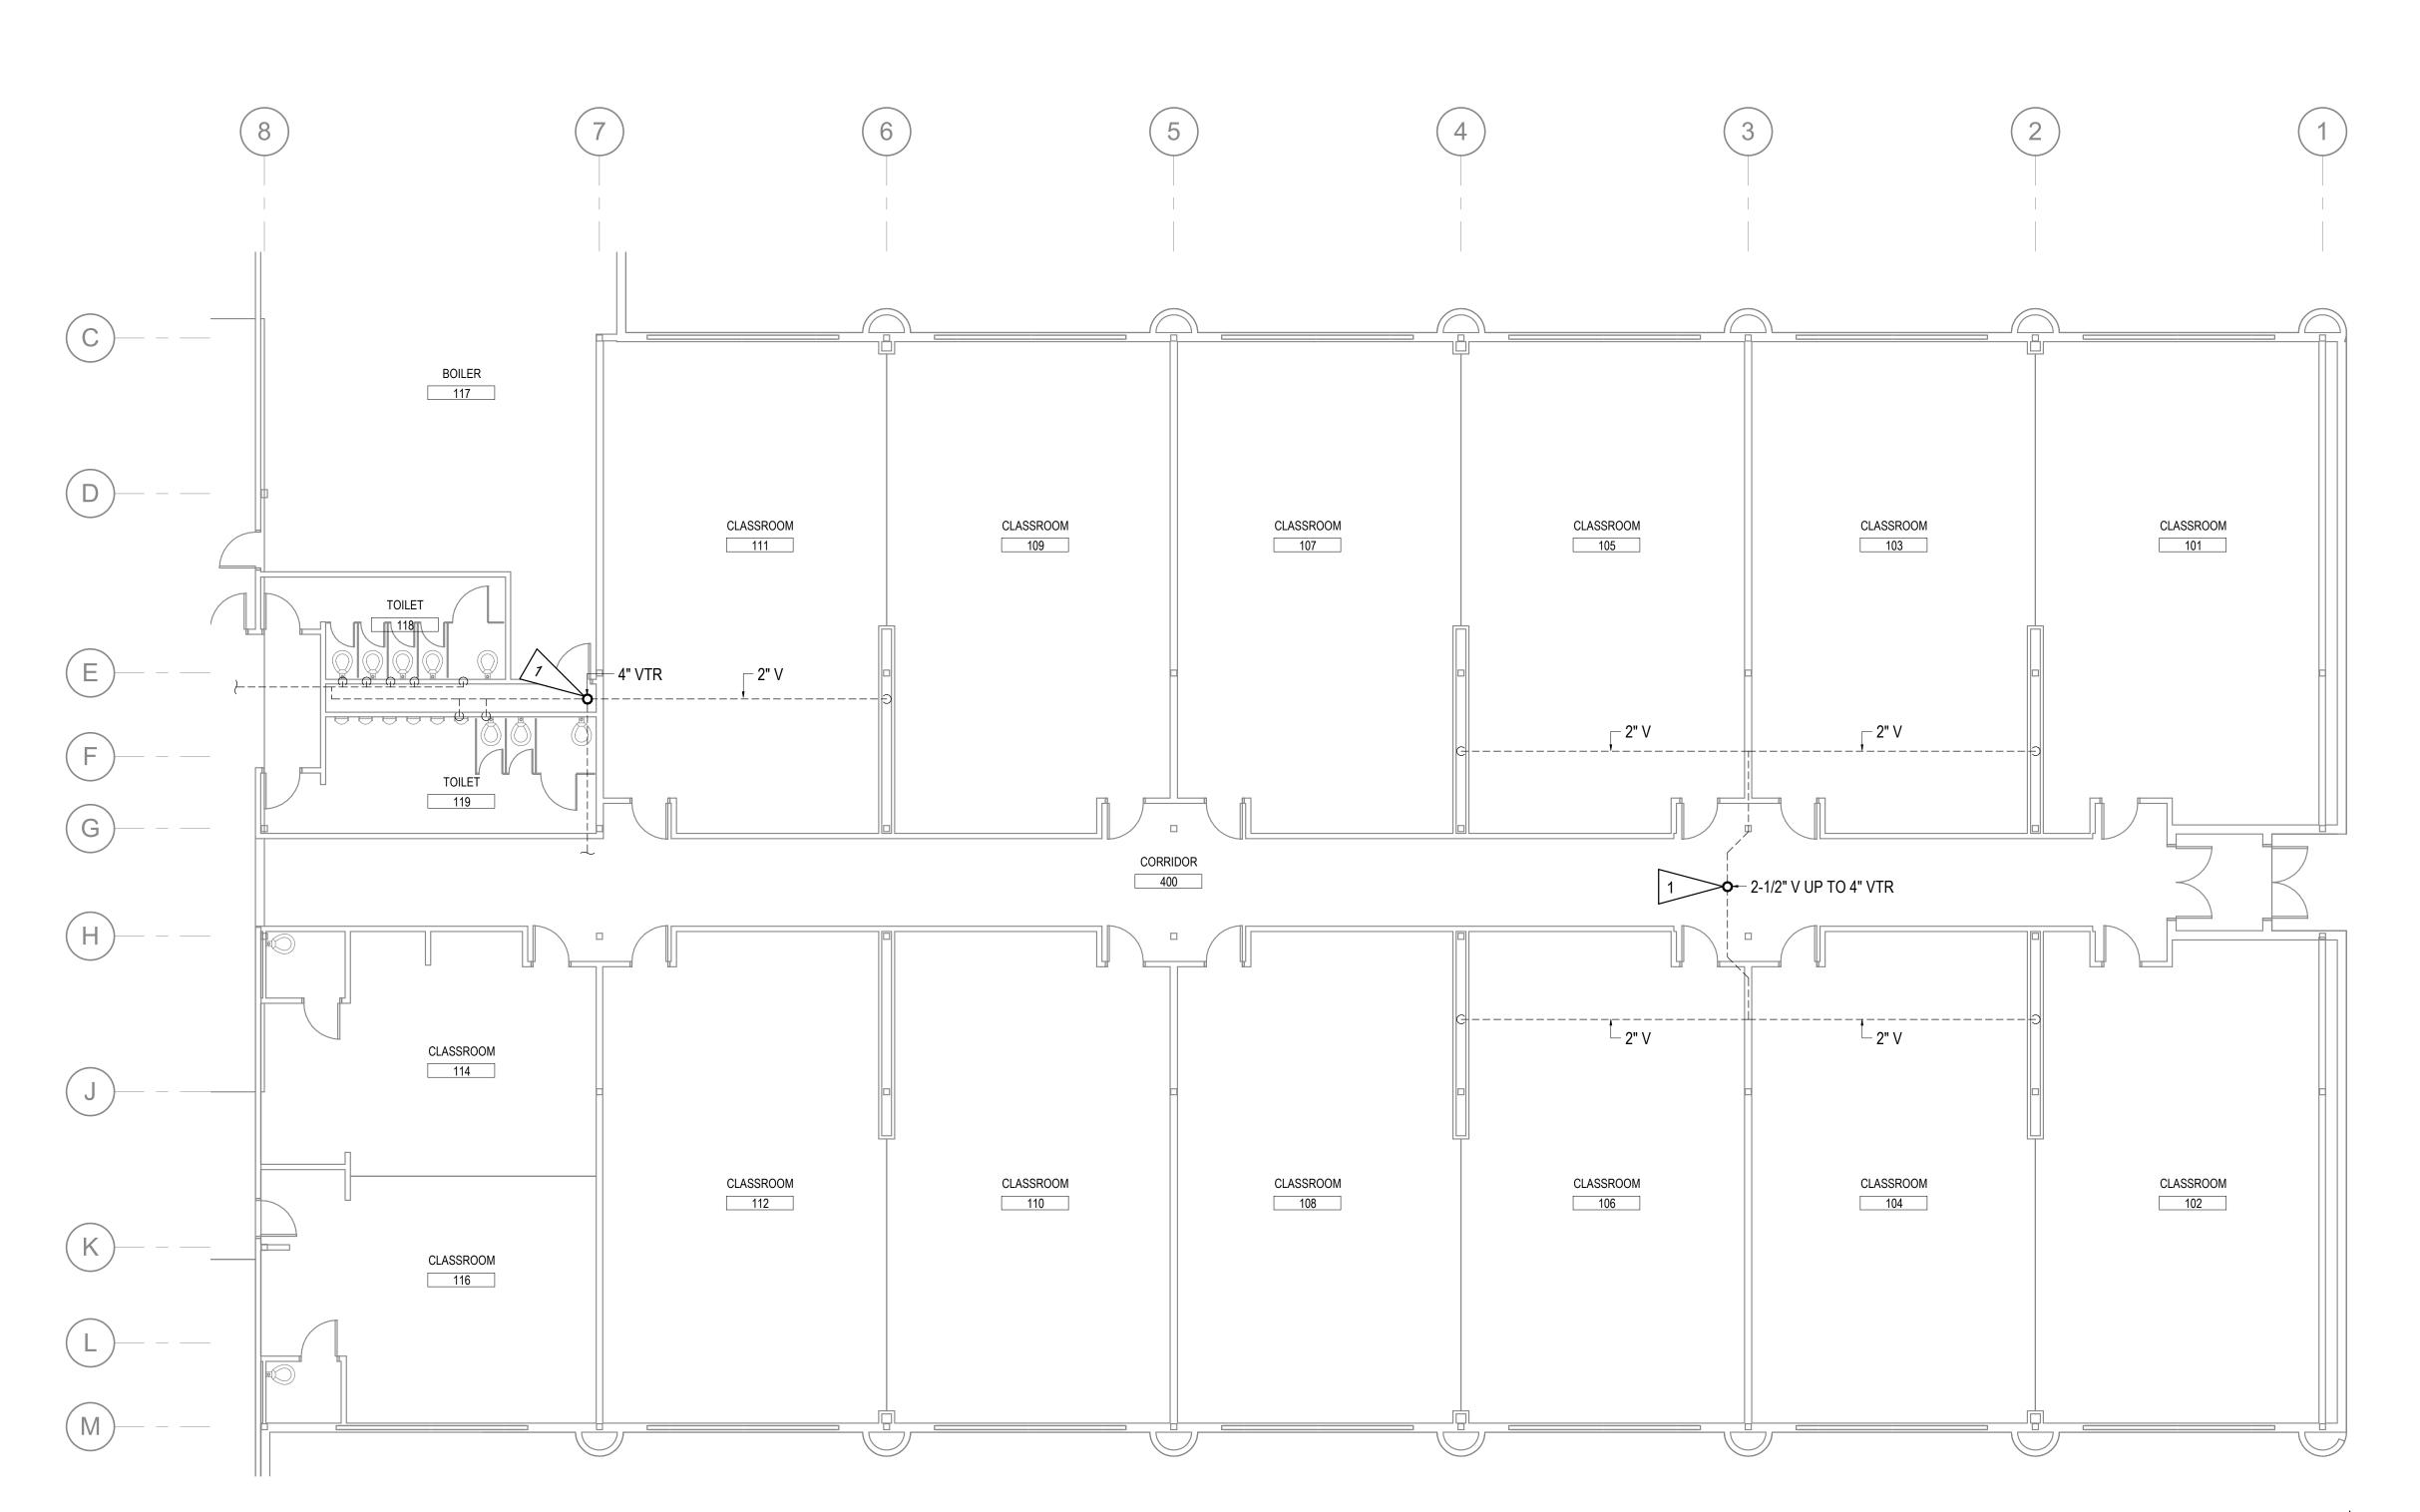

MECHANICAL DEMOLITION PLAN - AREA D

NOT TO SCALE

NOTIFICATION OF CHILD OCCUPIED FACILITY PORTIONS OF THIS BUILDING ARE CLASSIFIED AS A CHILD OCCUPIED FACILITY IN ACCORDANCE WITH 40 CFR 745 AND LEAD-BASED PAINTS MAY BE PRESENT ON COMPONENTS TO BE DISTURBED IN THOSE AREAS. PERSONNEL PERFORMING WORK IN THESE AREAS MUST COMPLY WITH THE REQUIREMENTS OF 40 CFR 745. INCLUDING TRAINING, WORK PRACTICES AND CLEANING OF THE WORK AREA. REFER TO SPECIFICATION DIVISIONS 0, 1 AND 2 FOR SPECIFIC INFORMATION CONCERNING DISTURBING, REMOVING AND DISPOSING OF LEAD MATERIALS AND THE INSTALLATION OF NEW MATERIALS OR COMPONENTS. THIS NOTIFICATION IS PROVIDED IN ACCORDANCE WITH EPA AND OSHA REQUIREMENTS.

PERMIT STAMP

M301


SHEET NOTES:

M301

- EXTEND PLUMBING VENT THROUGH ROOF MINIMUM 12" ABOVE NEW ROOF MEMBRANE. FOR TYPICAL DETAIL, SEE -
- PROVIDE NEW FUEL TANK VENT AND REVISE EXISTING FUEL VENT AS REQUIRED FOR RECONNECTION.
- INSTALL 24/24 KITCHEN EXHAUST HOOD RH-1 ON NEW ROOF CURB AND RE-CONNECT TO EXISTING TYPE II KITCHEN EXHAUST DUCTWORK BELOW. FOR TYPICAL DETAIL, SEE -
- CONNECT NEW GENERATOR EXHAUST PIPING TO EXISTING EXHAUST PIPING BELOW. PROVIDE NEW ROOF CURB.
- REINSTALL SALVAGED BOILER FLUE THROUGH NEW ROOF CURB.
- PROVIDE NEW 3"Ø WATER HEATER FLUE FROM WATER HEATER UP THROUGH NEW ROOF CURB. FOR DETAIL SEE -

LOUVER REMODEL ELEVATION #2

M301

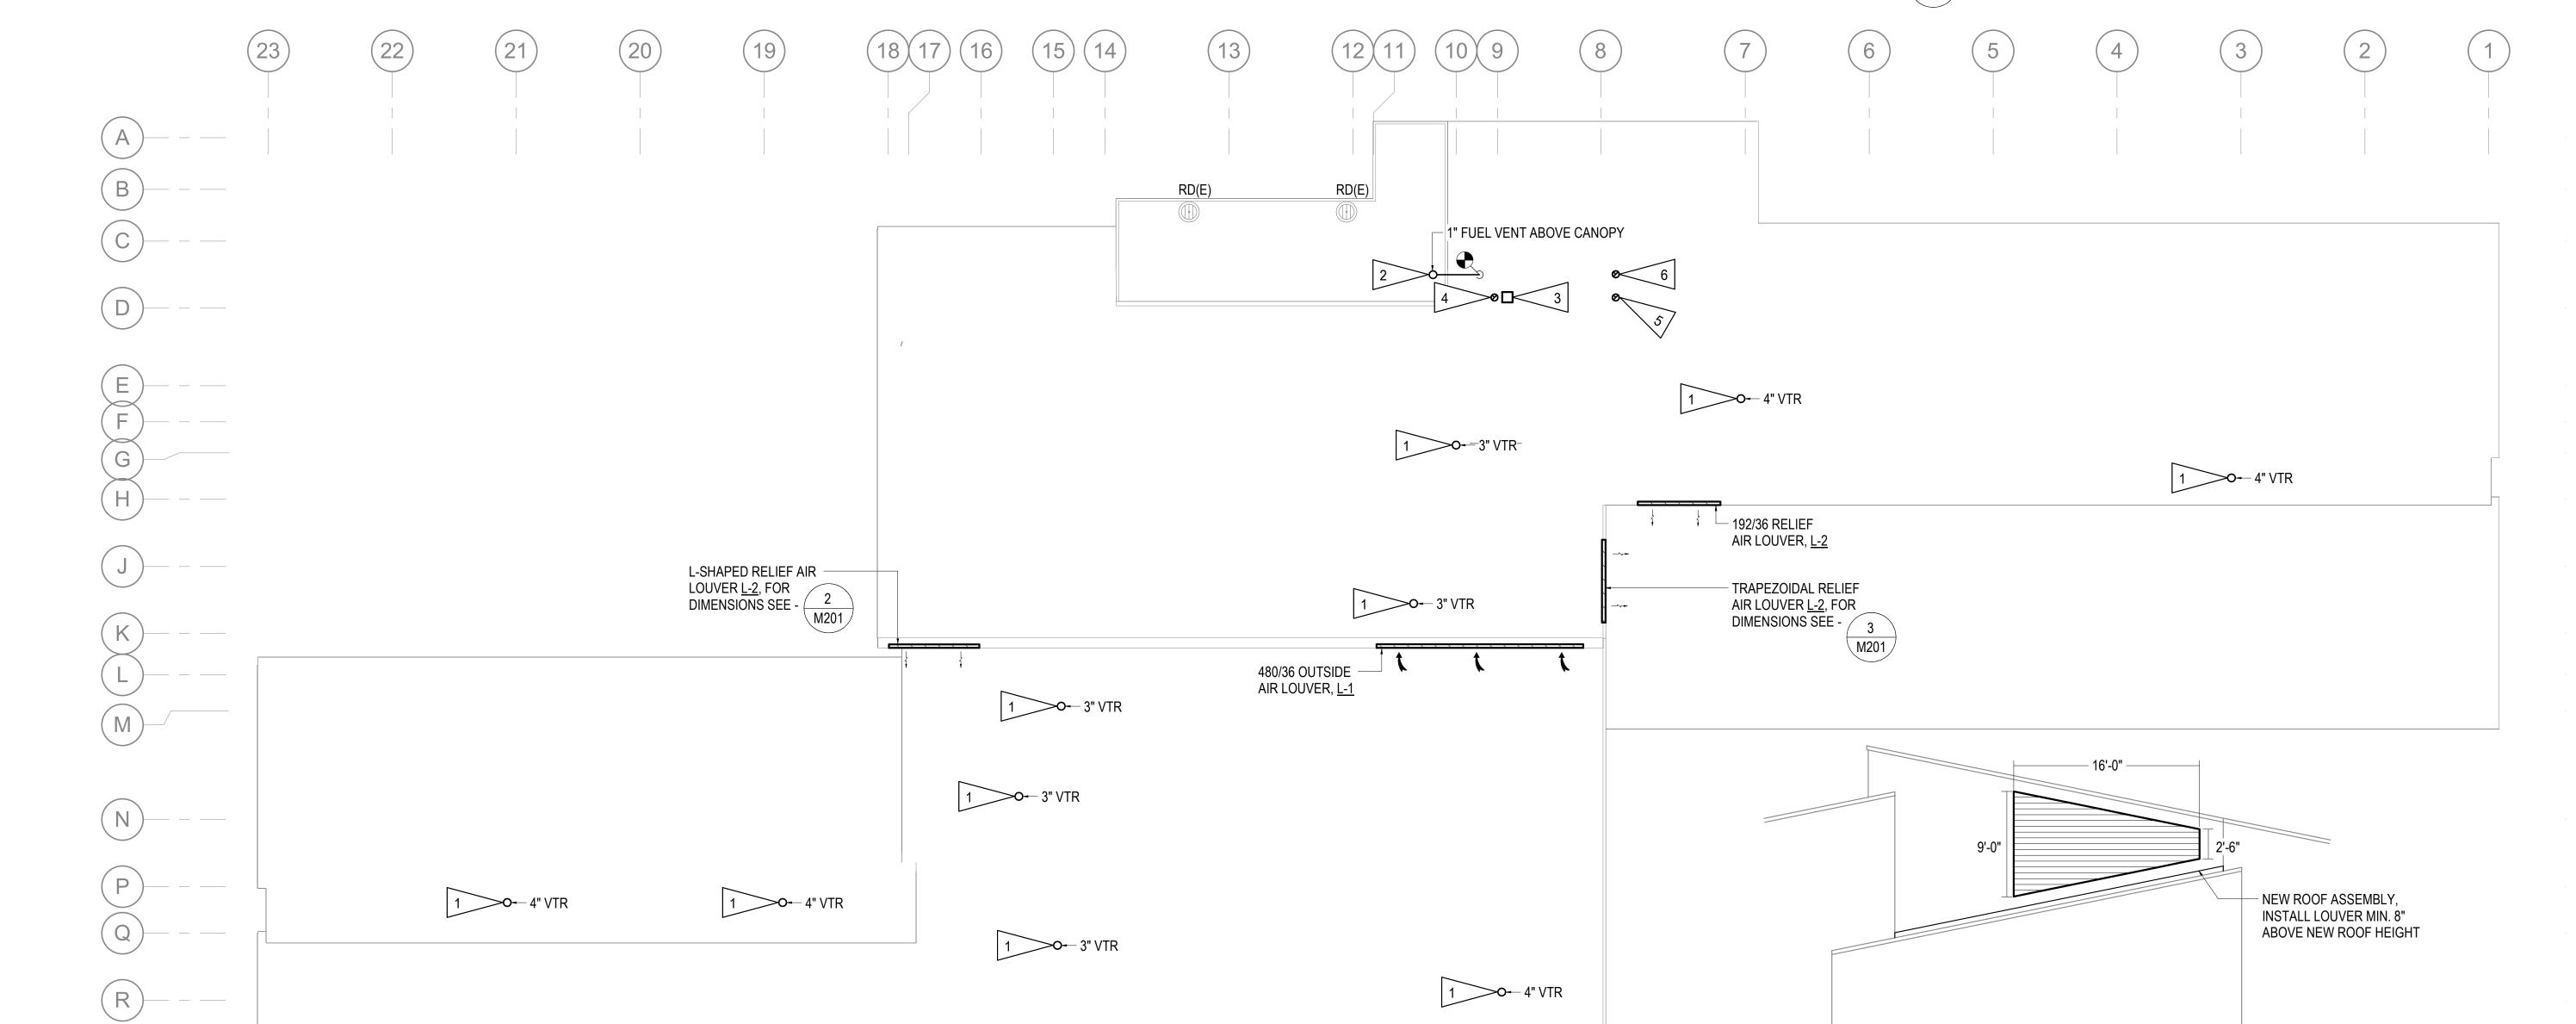

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FOR:

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ANCHORAGE SCHOOL DISTRICT

SPRING HILL ELEMENTARY SCHOOL ROOF REPLACEMENT

9911 LAKE OTIS PKWY ANCHORAGE, AK

100% PERMIT DOCUMENTS

JOB NO.	M3177
DATE:	02/14/2024
PROJ. MGR.:	MEM
DRAWN BY:	JMC
REVIEWED BY:	DRM
REVISIONS:	

MECHANICAL REMODEL **ROOF PLAN**

> SHEET NO. **M201**

MECHANICAL REMODEL ROOF PLAN

10'-0"

LOUVER REMODEL ELEVATION #1

5'-0"

NOT TO SCALE

''3'-6"⁻

10'-0"

INSTALL LOUVER <u>L-1</u>

MIN. 8" ABOVE NEW **ROOF ASSEMBLY**

10'-0"

1/16" = 1'-0"


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THIS NOTIFICATION IS PROVIDED IN ACCORDANCE WITH EPA
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PERMIT STAMP

SHEET NOTES:

CONNECT EXISTING VENT PIPING TO NEW VENT THROUGH ROOF. FOR VTR DETAIL,



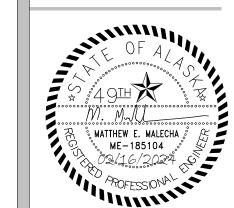

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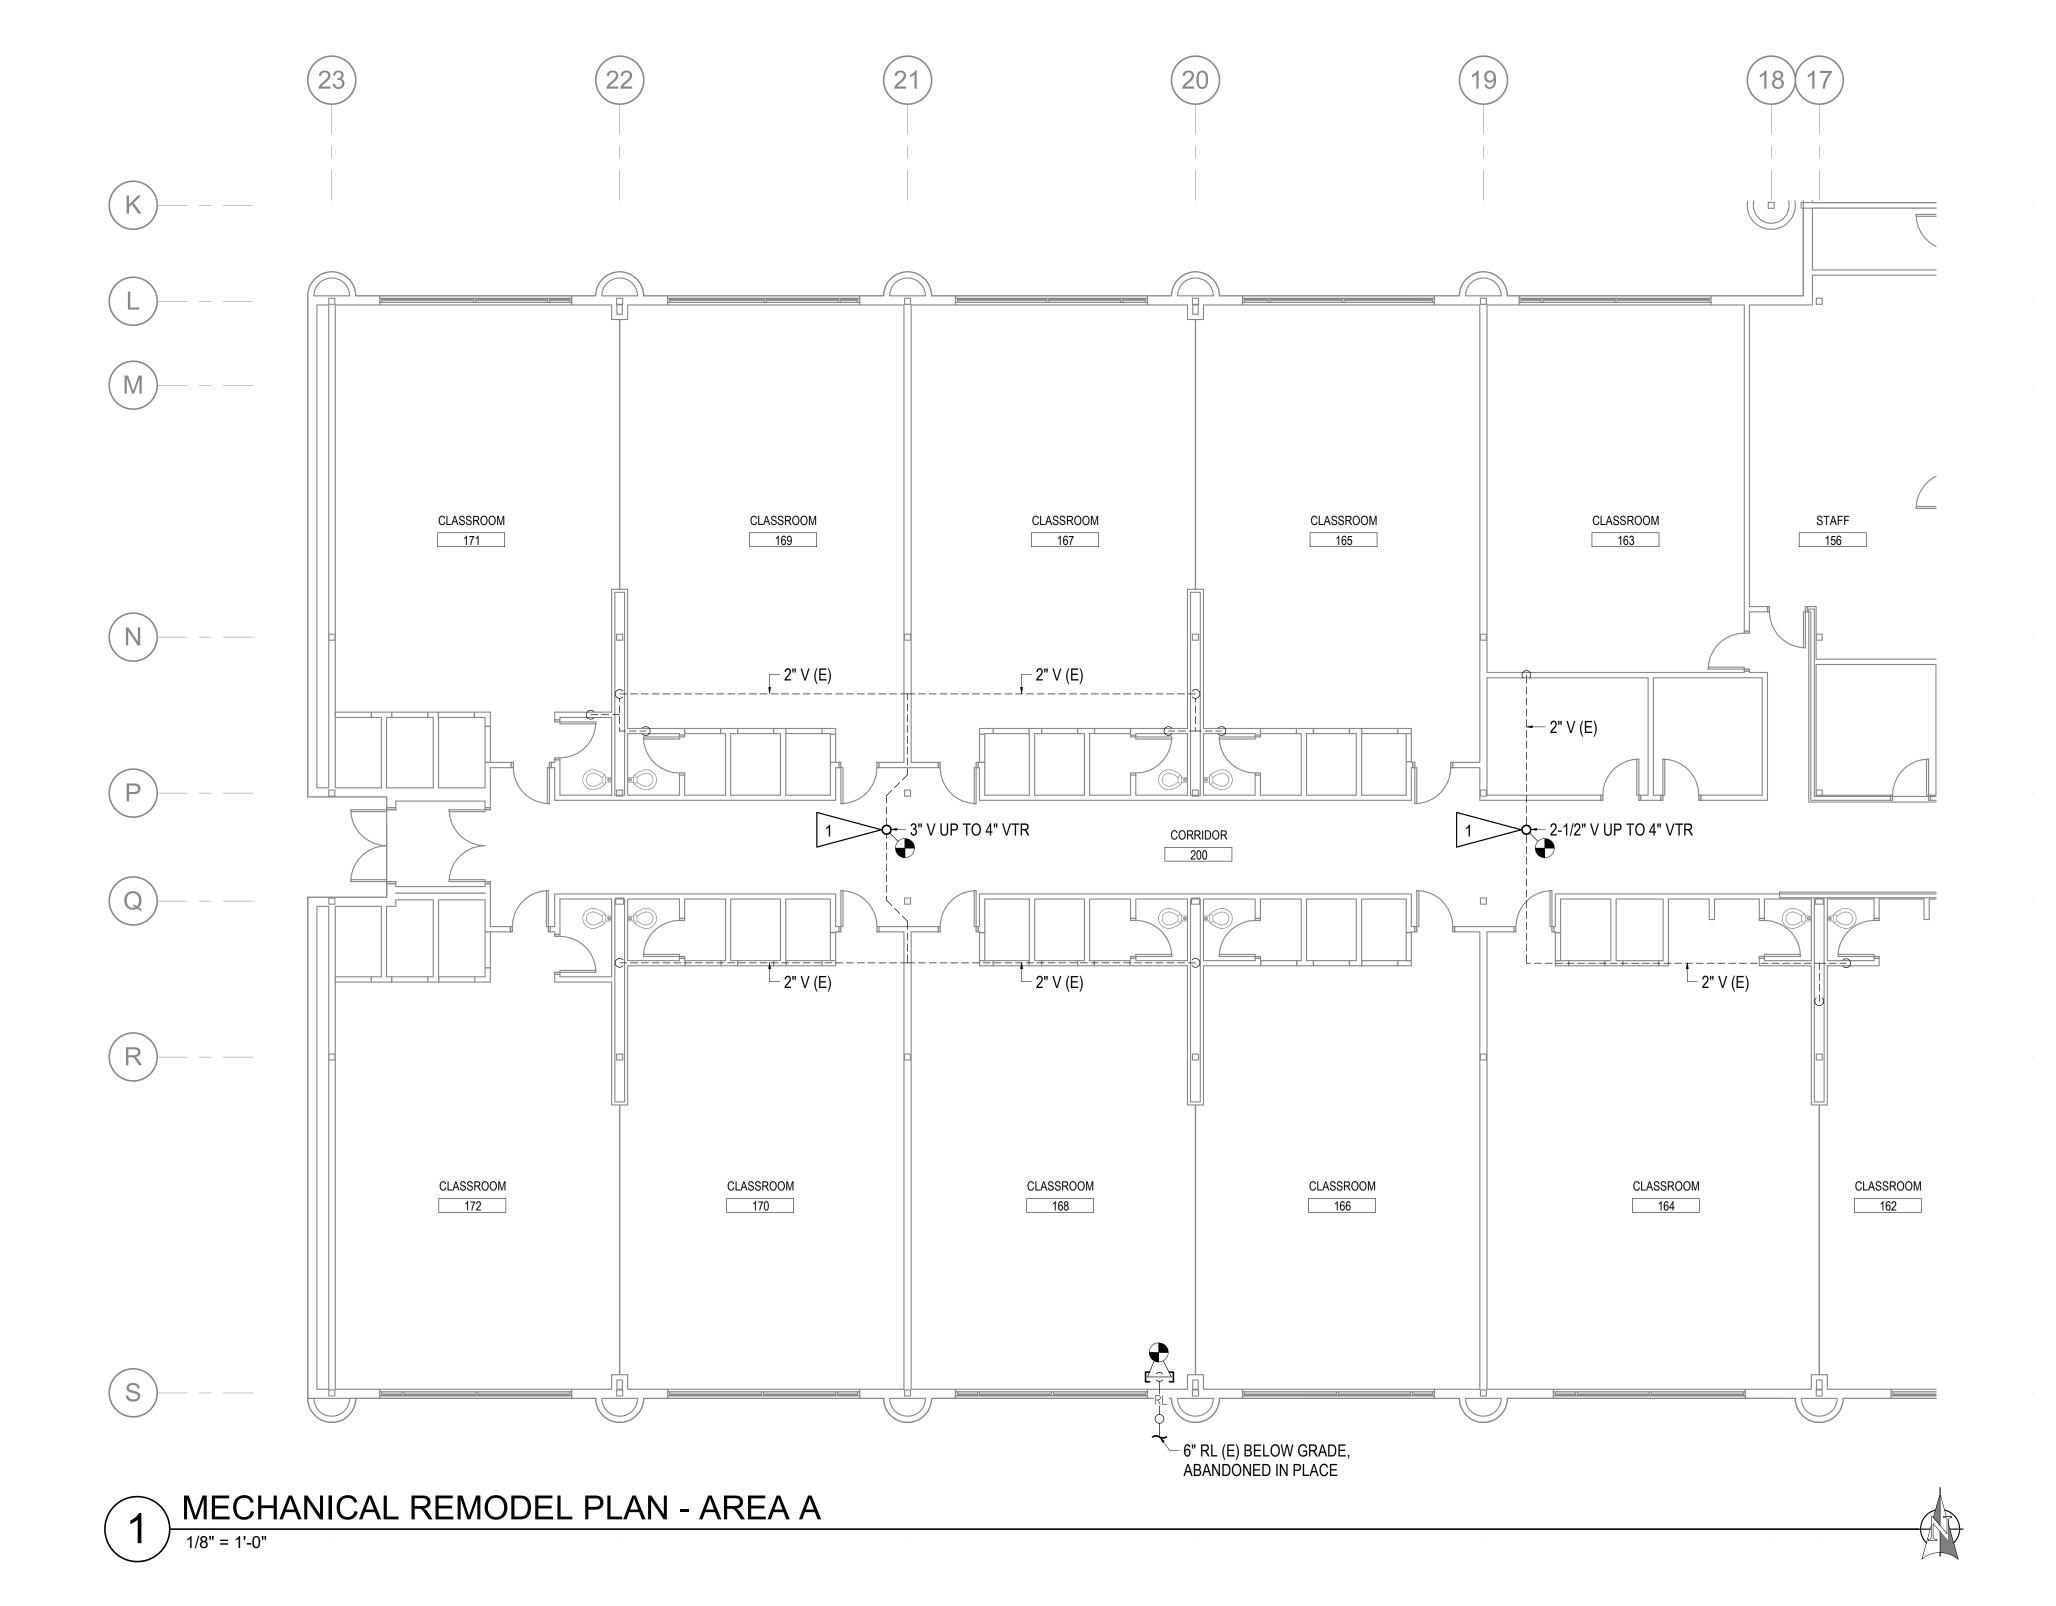
SPRING HILL ELEMENTARY SCHOOL ROOF REPLACEMENT


9911 LAKE OTIS PKWY ANCHORAGE, AK

100% PERMIT DOCUMENTS

JOB NO.	M3177
DATE:	02/14/2024
PROJ. MGR.:	MEM
DRAWN BY:	JMC
REVIEWED BY:	DRM
REVISIONS:	

MECHANICAL REMODEL ROOF PLAN -AREA A



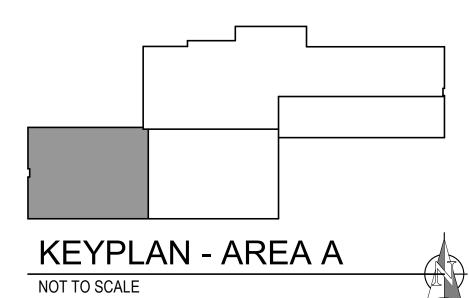

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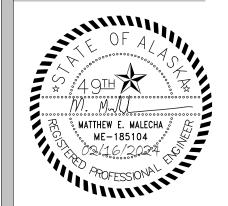
SHEET NOTES:

1. CONNECT EXISTING VENT PIPING TO NEW VENT THROUGH ROOF. FOR VTR DETAIL, SEE - 1

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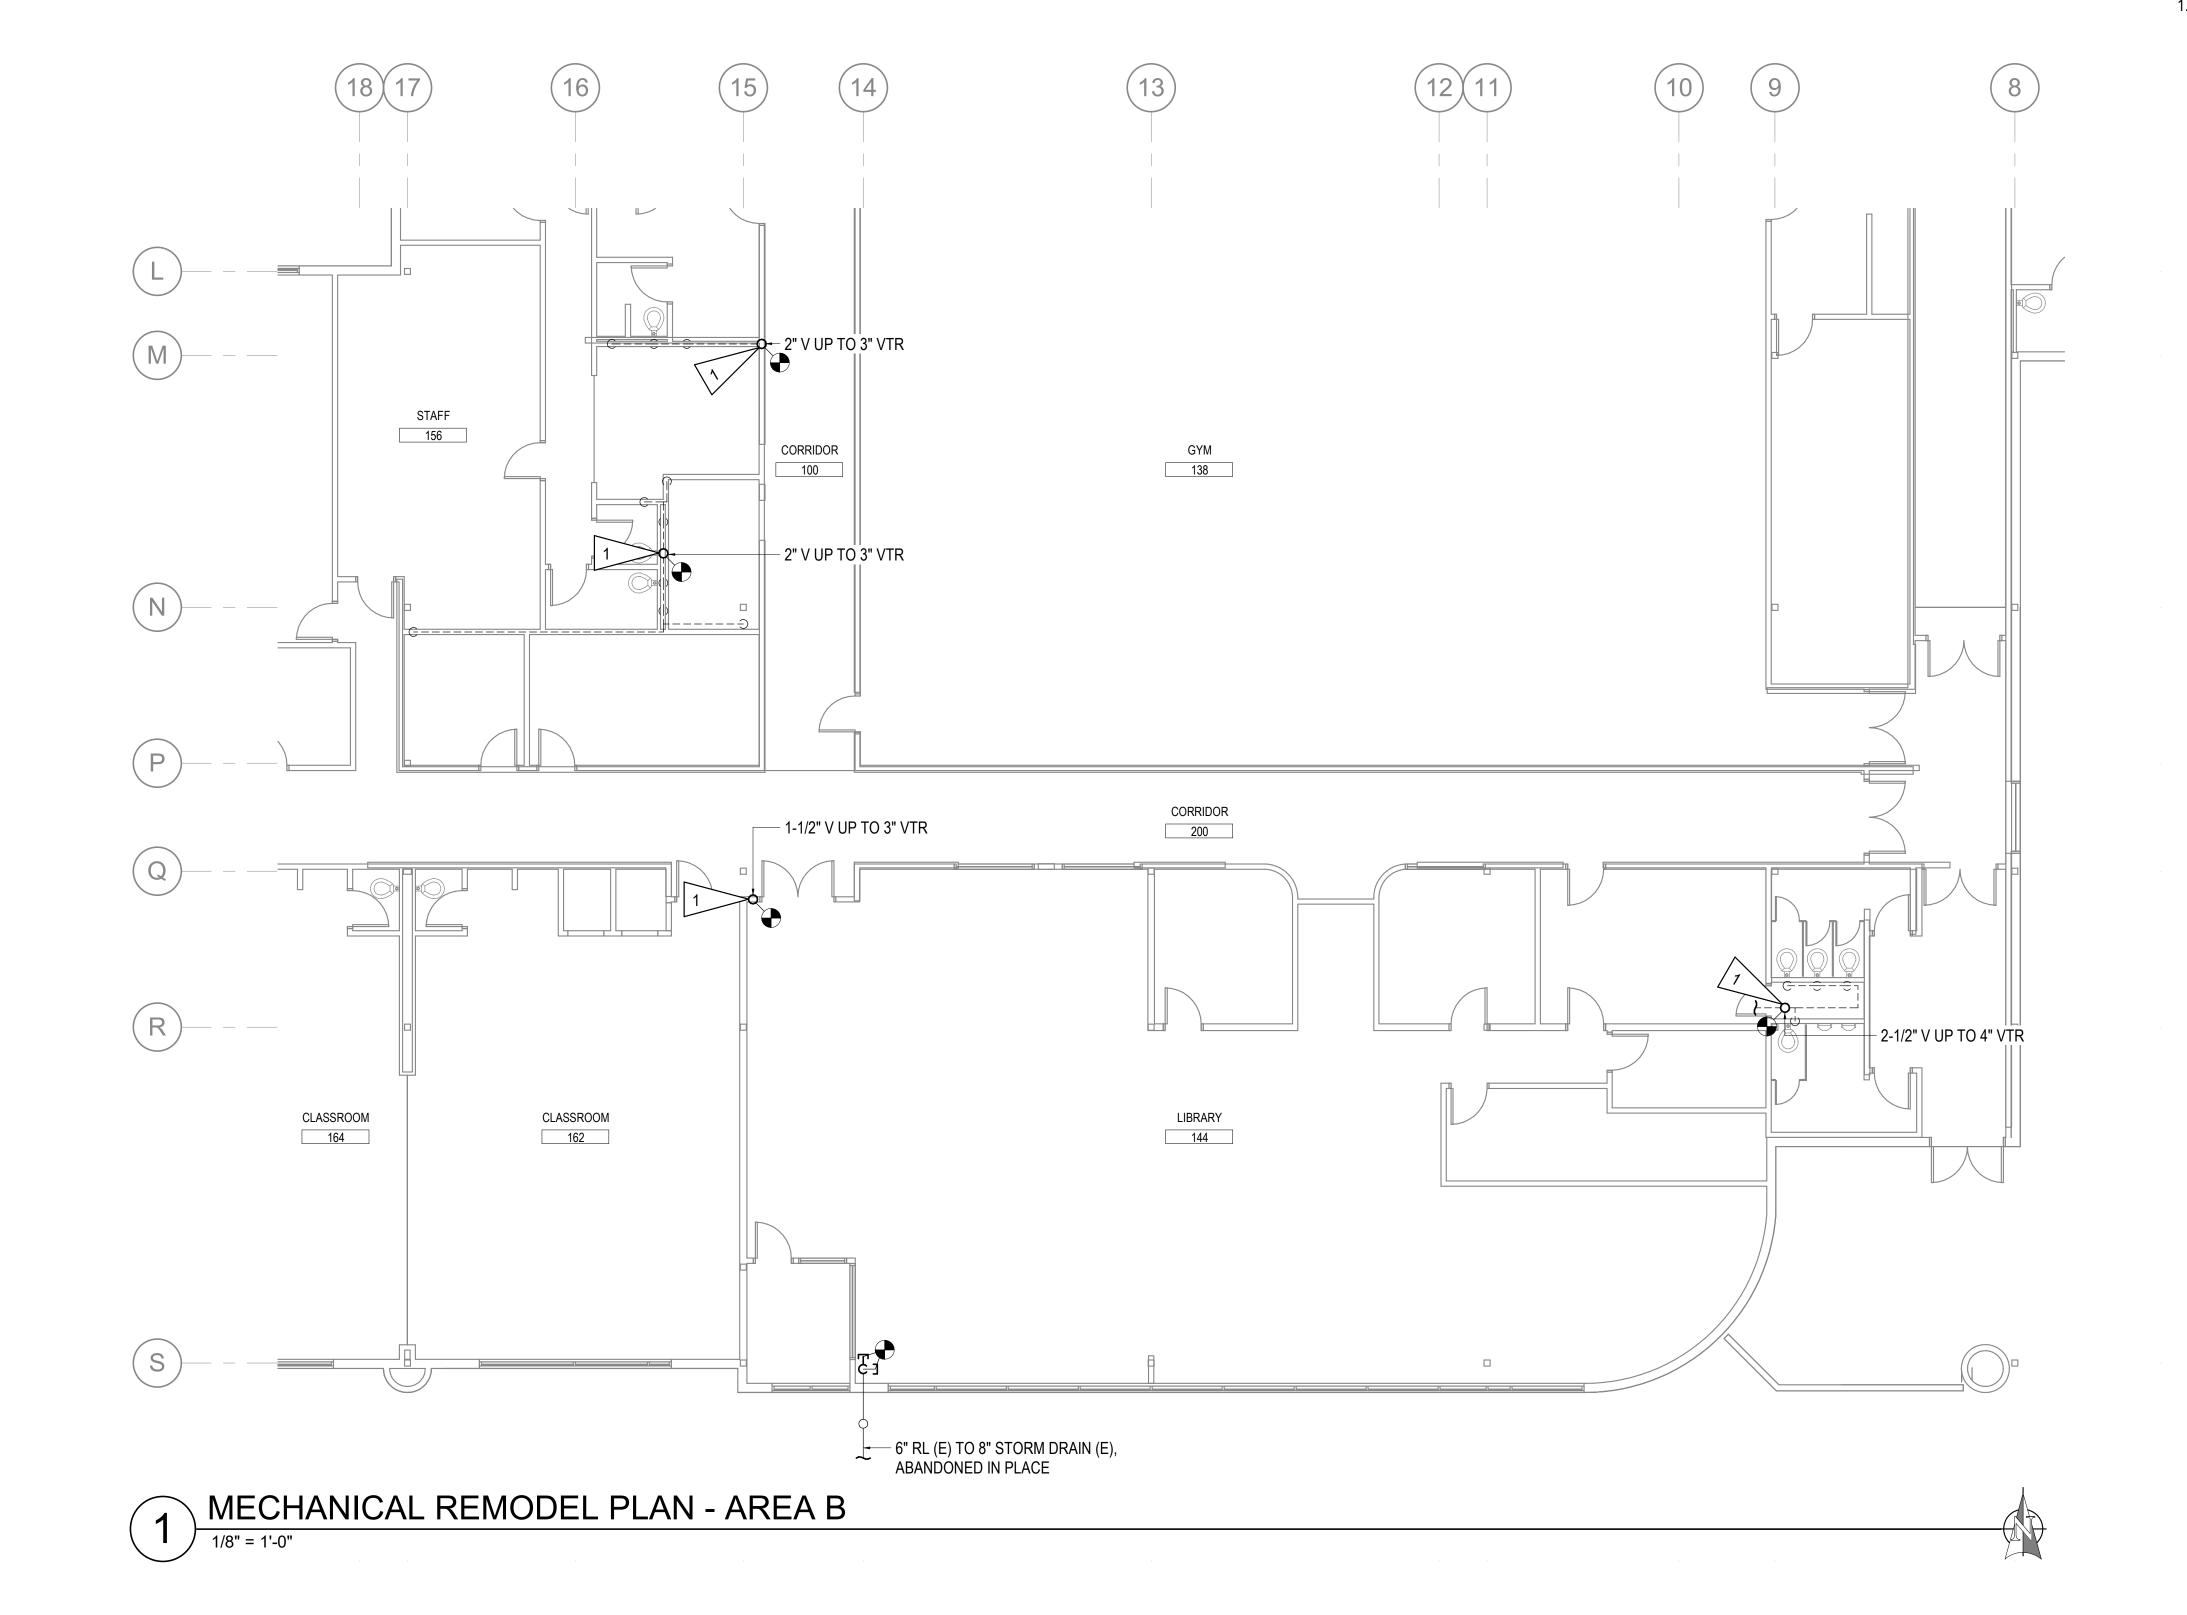
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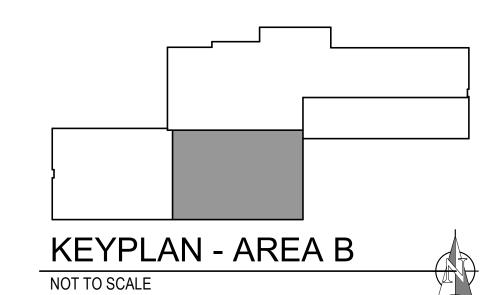
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EVISIONS:	

MECHANICAL REMODEL ROOF PLAN -AREA B





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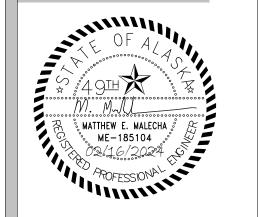
SHEET NOTES:



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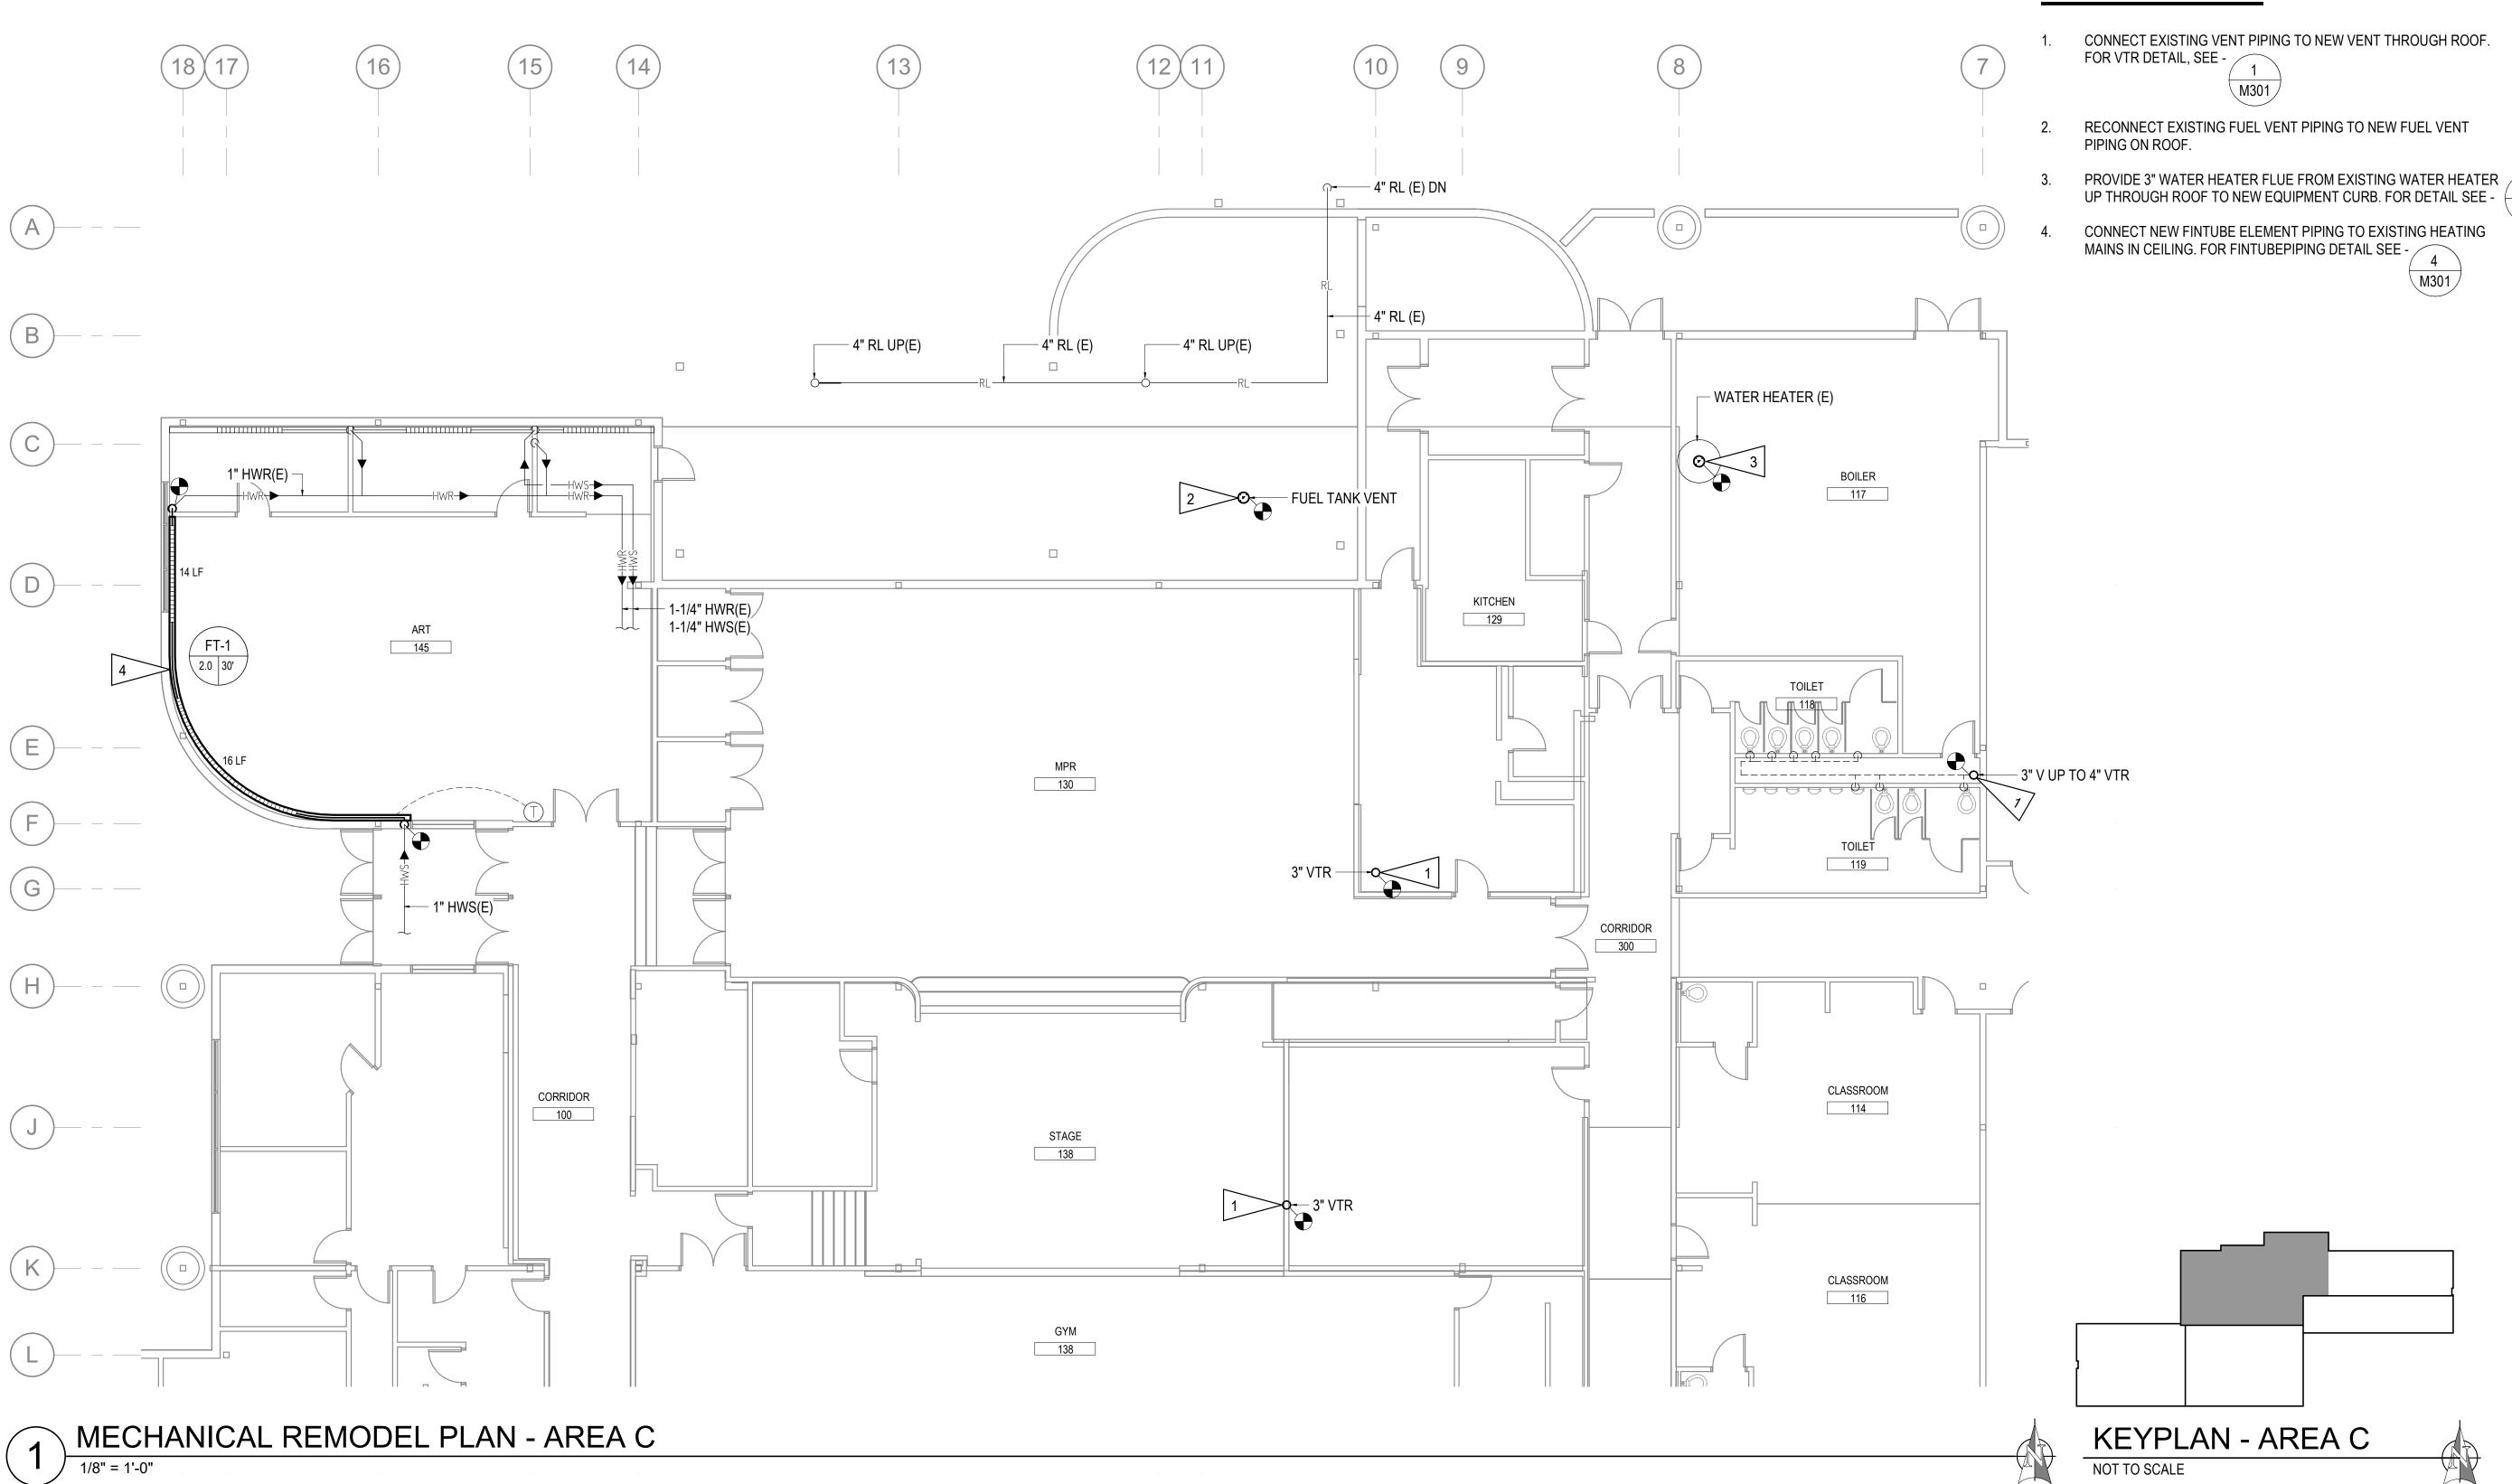
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MECHANICAL REMODEL ROOF PLAN -AREA C



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SHEET NOTES:

CONNECT EXISTING VENT PIPING TO NEW VENT THROUGH ROOF. FOR VTR DETAIL, SEE -

KEYPLAN - AREA A

NOT TO SCALE

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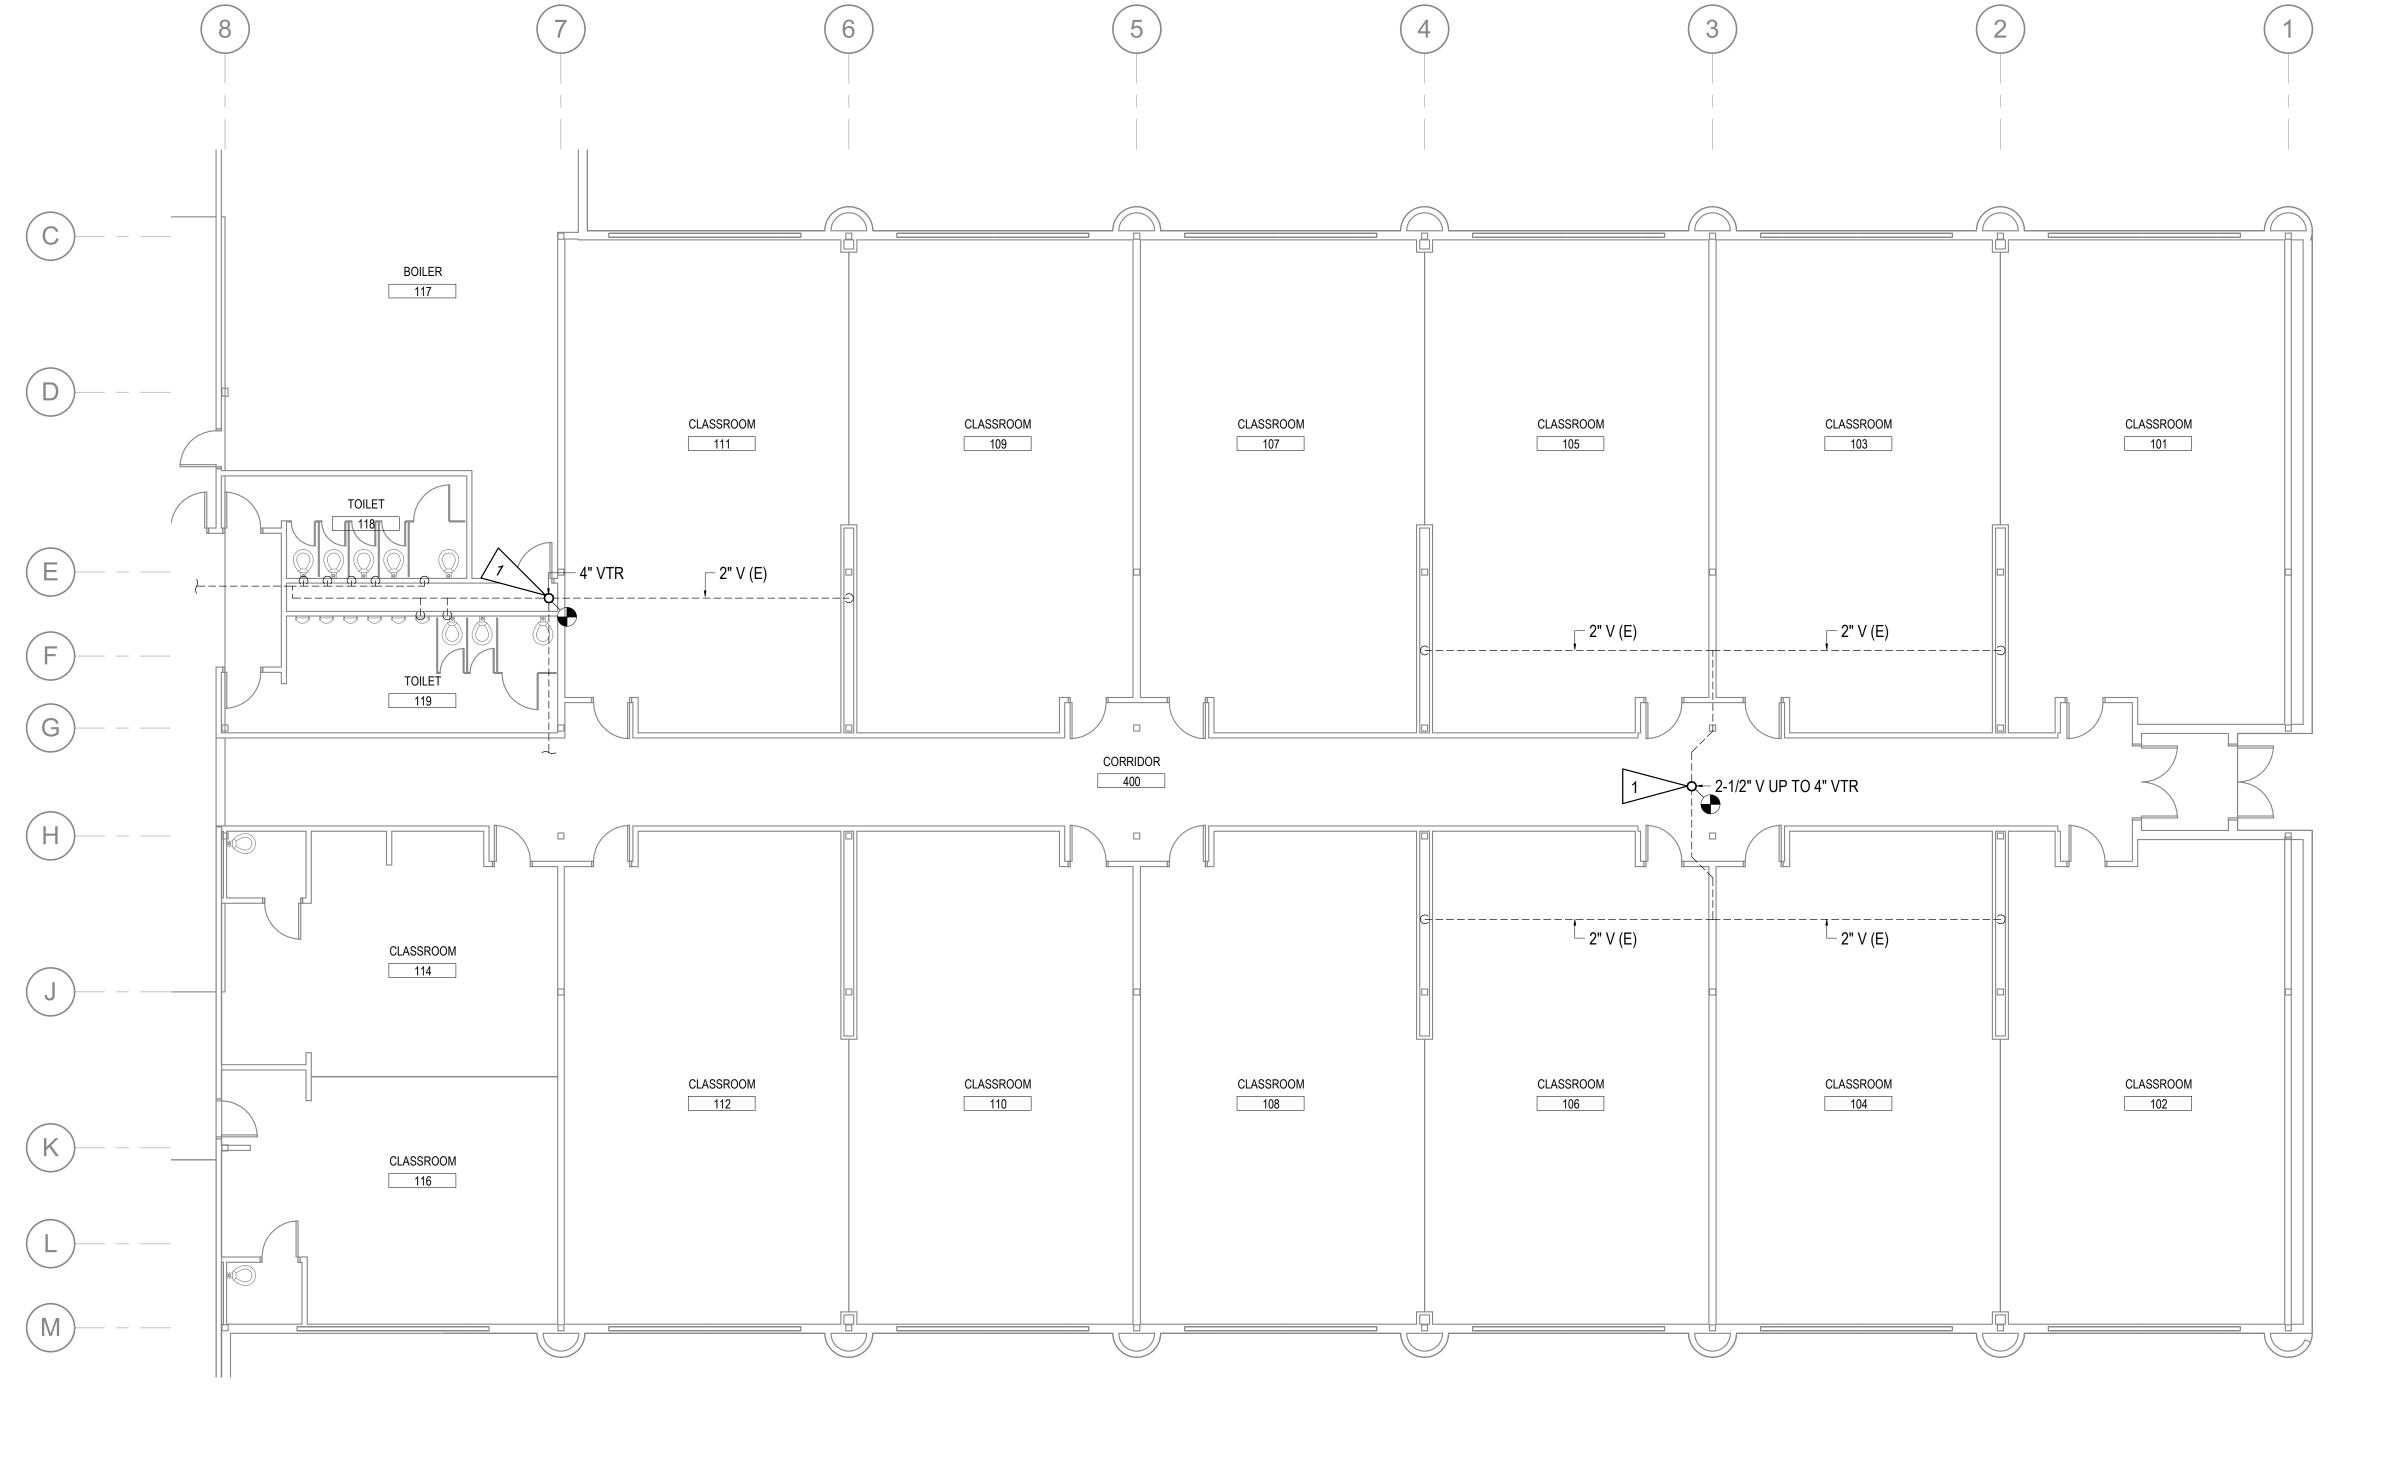
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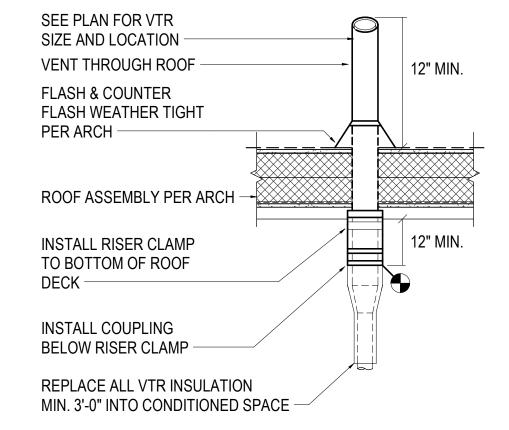
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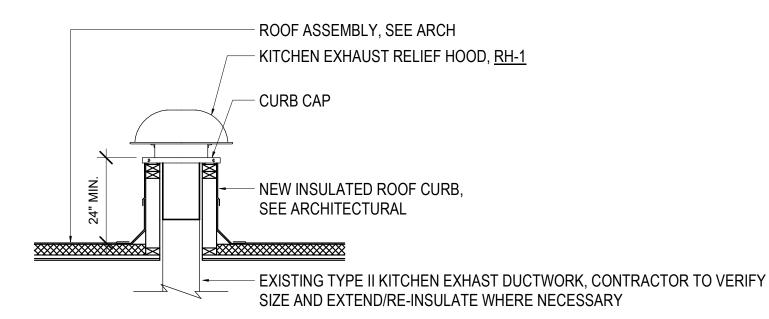
MECHANICAL REMODEL ROOF PLAN -AREA D






1 VENT THRU ROOF DETAIL

NOT TO SCALE




2 TYPE II KITCHEN HOOD ROOF CURB DETAIL
NOT TO SCALE

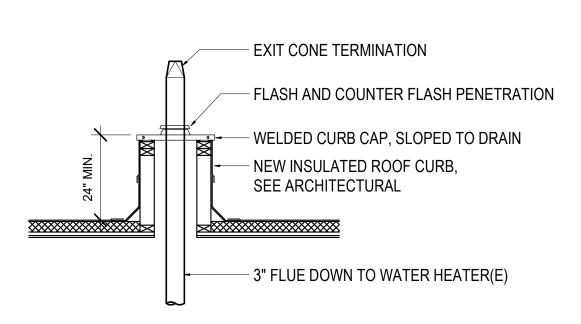

WATER HEATER FLUE DETAIL

NOT TO SCALE

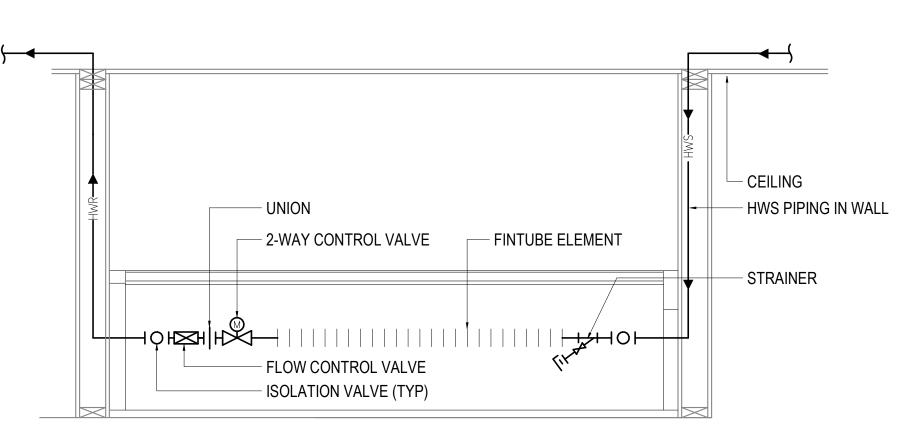

FINTUBE PIPING DETAIL

NOT TO SCALE

FOR:
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RSA

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Electrical Consulting
Engineers
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SPRING HILL ELEMENTARY SCHOOL ROOF REPLACEMENT

9911 LAKE OTIS PKWY ANCHORAGE, AK

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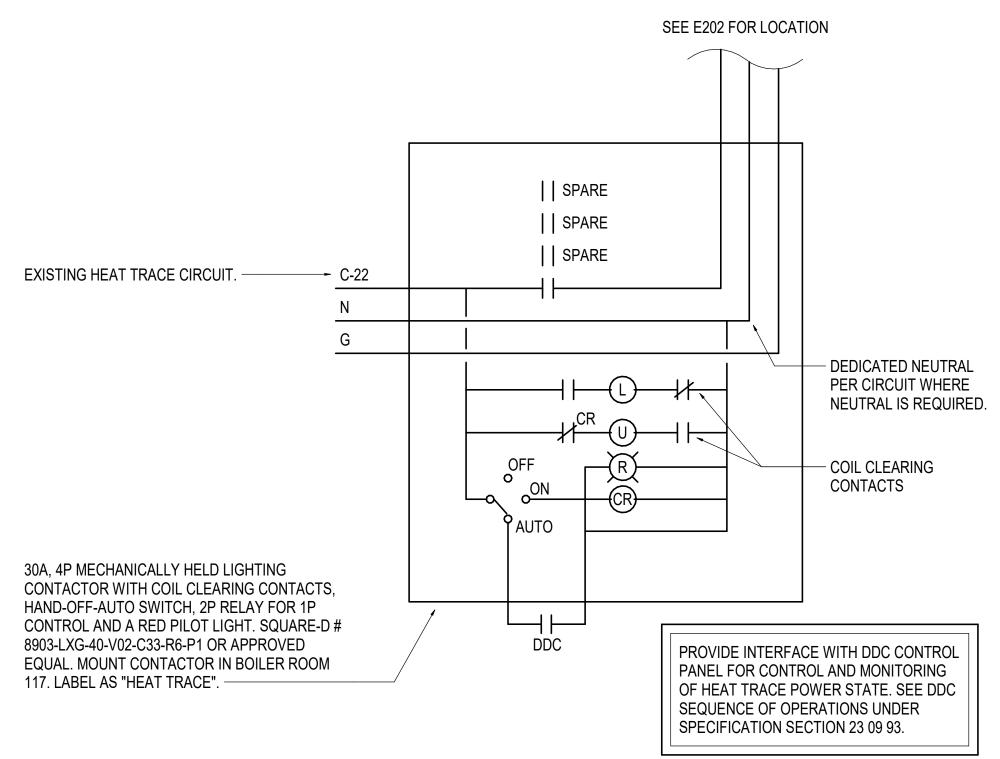
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MECHANICAL DETAILS

SHEET NO.

M301

	ELECTRICA	AL LEGE	IND
	CONDUIT, CONCEALED	AFF	ABOVE FINISHED FLOOR
#10	NUMBER AND SIZE OF WIRES (NO MARKS = 3 #12)	AFG	ABOVE FINISHED GRADE
A-2	HOMERUN TO PANEL (PANEL AND CIRCUIT No.)	С	CONDUIT
—-OH/E —	OVERHEAD ELECTRICAL LINE (12470/7200V UON)	СО	CONDUIT ONLY
SR	SURFACE RACEWAY	Е	DENOTES EXISITNG ITEM
	LINEAR LIGHT FIXTURE - PENDANT MTD	GRSC	GALVANIZED RIGID STEEL CONDUIT
ф	DUPLEX RECEPTACLE	MCB	MAIN CIRCUIT BREAKER
(JUNCTION BOX	MLO	MAIN LUGS ONLY
	FIXED VIDEO CAMERA, CEILING-MOUNTED	NEC	NATIONAL ELECTRICAL CODE
	FIXED VIDEO CAMERA, WALL-MOUNTED	NTS	NOT TO SCALE
Ю	SPEAKER	R	DENOTES EXISTING ITEM THAT HAS BEEN RELOCATED
(II)	DUPLEX RECEPTACLE TO BE REMOVED (DASHED OR DOTTED LINES INDICATE ITEMS TO BE REMOVED TYPICAL)	TYP	TYPICAL
1	NOTE TAG (No. INDICATES NOTE)	UON	UNLESS OTHERWISE NOTED



HEAT TRACE CONTROL DETAIL NOT TO SCALE

ELECTRICAL LOAD STATEMENT

NO LOADS ARE BEING ADDED TO EXISTING PANELS OR SERVICE. ALL EQUIPMENT AND DEVICES NOTED TO BE DEMOLISHED ARE BEING REPLACED ONE FOR ONE IN LIKE. SUBMITTAL PRICING

PERMIT STAMP

NOTIFICATION OF POTENTIAL HAZARDS

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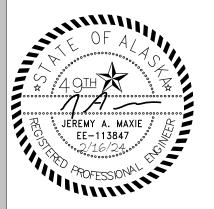
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Corporate No.: AECC542

Engineers



ANCHORAGE SCHOOL DISTRICT

SPRING HILL ELEMENTARY SCHOOL ROOF REPLACEMENT

9911 Lake Otis Pkwy, Anchorage, AK

100% PERMIT DOCUMENTS

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FWS,CZ	DRAWN BY:
JAM,RLW	REVIEWED BY:
	REVISIONS:

ELECTRICAL LEGEND

> SHEET NO. E001

GENERAL NOTES:

- A. THE INFORMATION SHOWN ON THIS DRAWING IS TAKEN FROM AS-BUILT DRAWINGS. THERE IS NO WARRANTY OR GUARANTEE AS TO THE ACCURACY OF THE INFORMATION SHOWN HERE-IN. THE CONTRACTOR SHALL FIELD VERIFY ALL ITEMS SCHEDULED FOR DEMOLITION PRIOR TO START OF WORK
- B. THE OWNER SHALL HAVE FIRST RIGHT OF REFUSAL ON ALL SALVAGEABLE MATERIALS. THE CONTRACTOR SHALL DELIVER SALVAGED MATERIALS TO A WAREHOUSE AS DIRECTED BY THE OWNER. THE CONTRACTOR SHALL DISPOSE OF, OFF SITE, ALL UNWANTED MATERIALS.
- C. DASHED OR DOTTED LINES INDICATE ITEMS TO BE REMOVED. SOLID LINES INDICATE EXISTING ITEMS TO REMAIN.

SHEET NOTES:

- 1. REMOVE AND SAVE FOR REINSTALLATION, DAVIS INSTRUMENTS WEATHER STATION.
- 2. DEMOLISH AERIAL CAT5 CABLING.
- 3. REMOVE ANALOG YAGI ANTENNAS AND TURN OVER TO ASD. DEMOLISH WOOD POLE.

PERMIT STAMP

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Electrical Consulting

670 West Fireweed Lane, Suite 200

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ANCHORAGE SCHOOL DISTRICT

SPRING HILL ELEMENTARY SCHOOL ROOF REPLACEMENT

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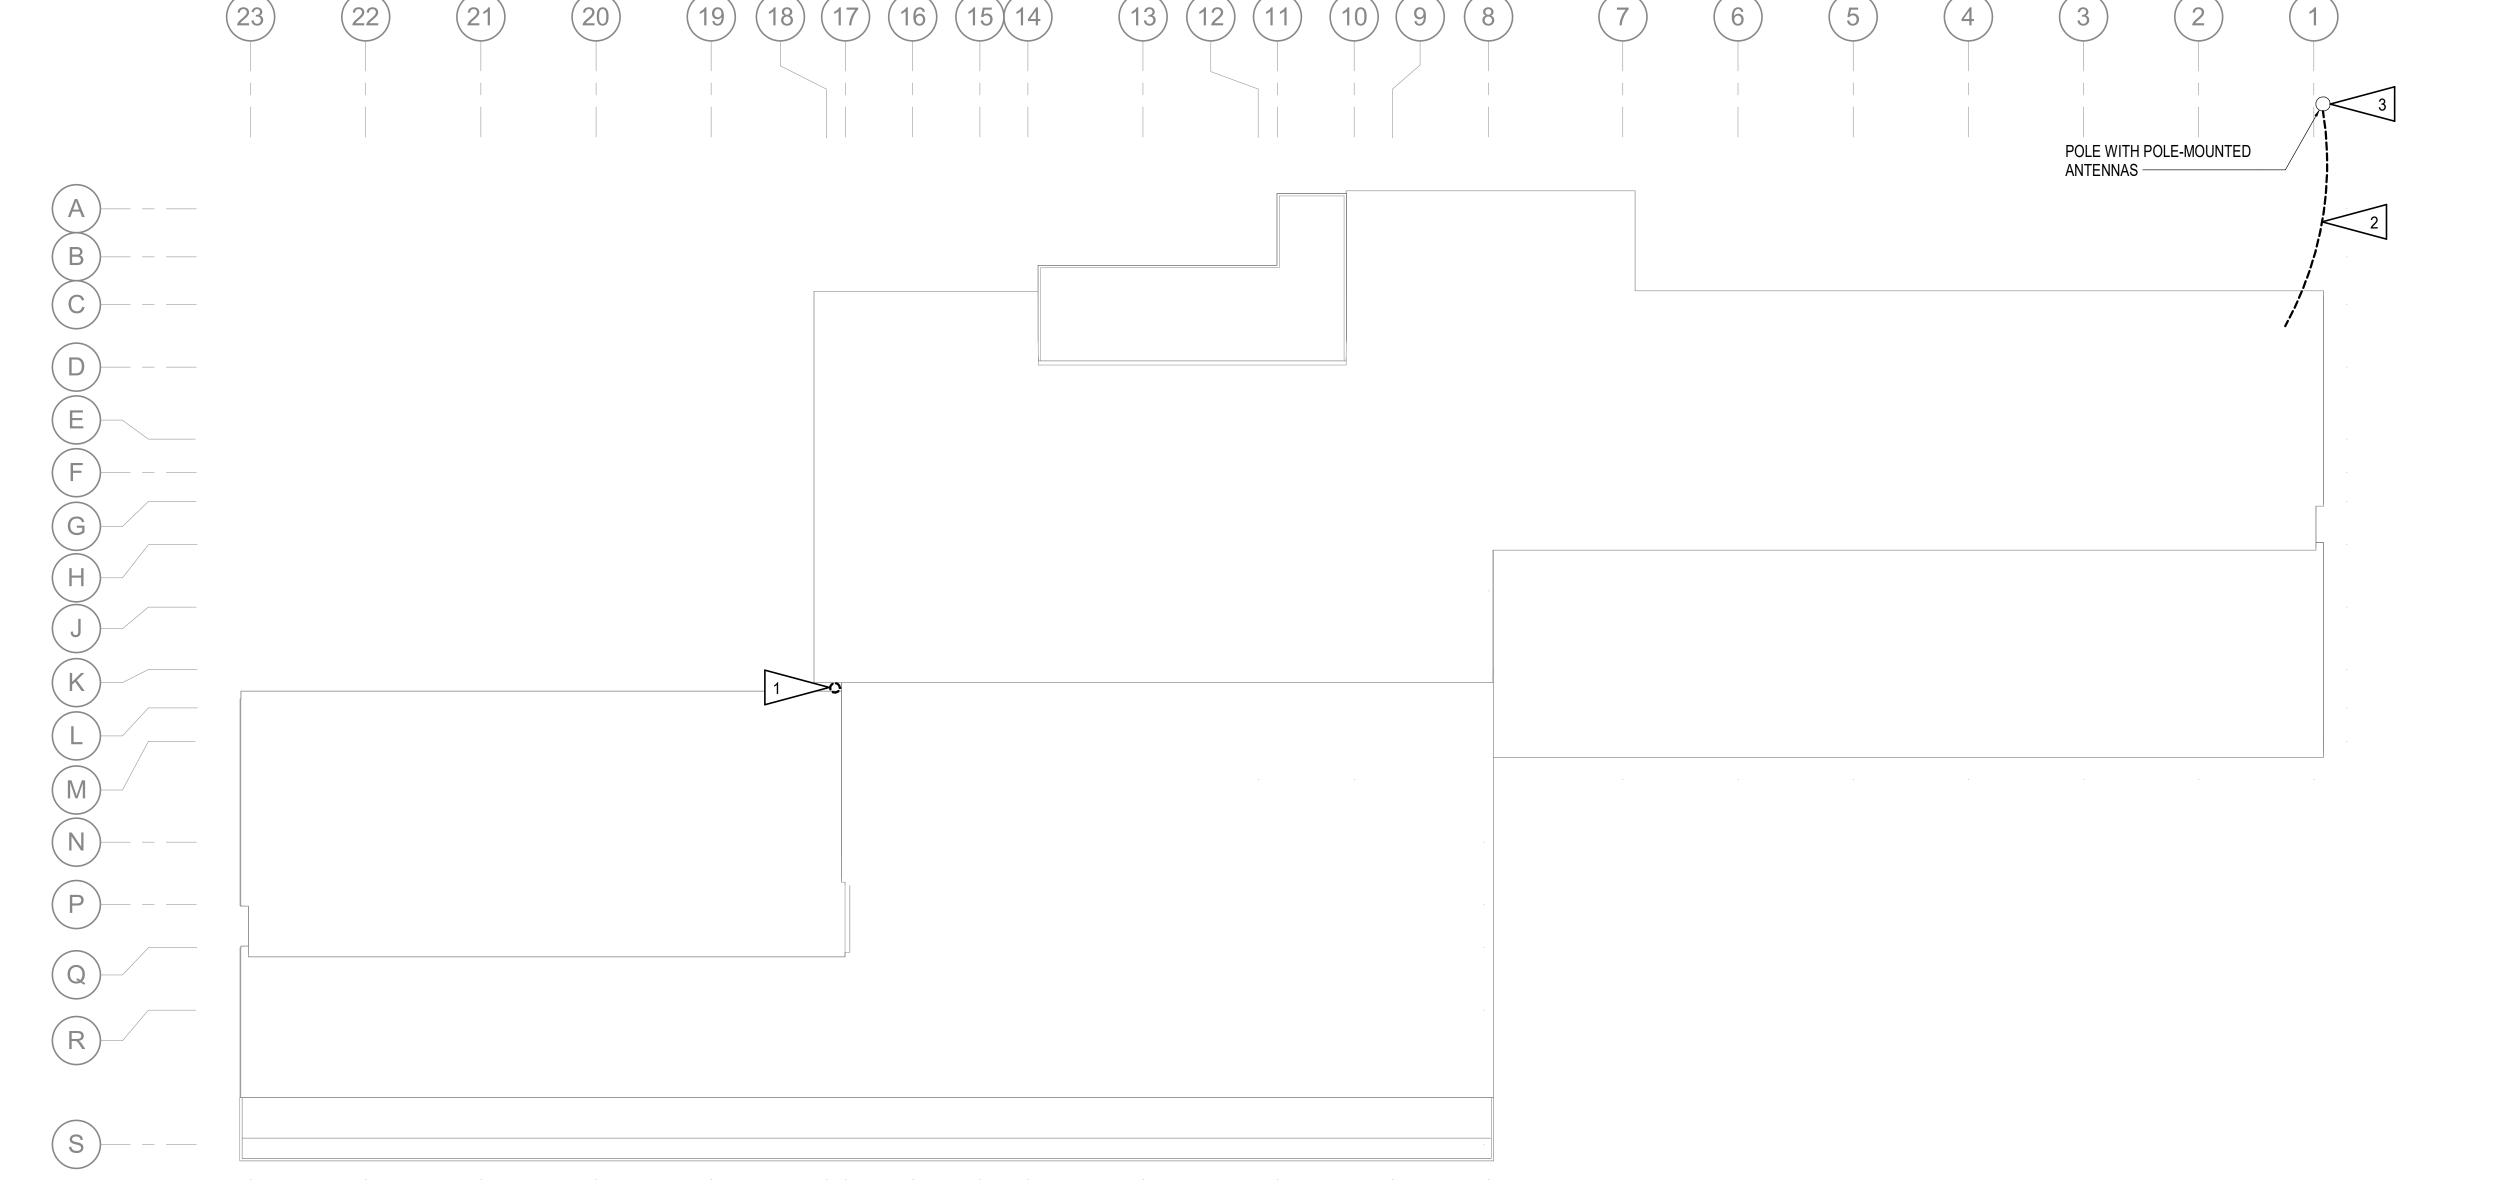
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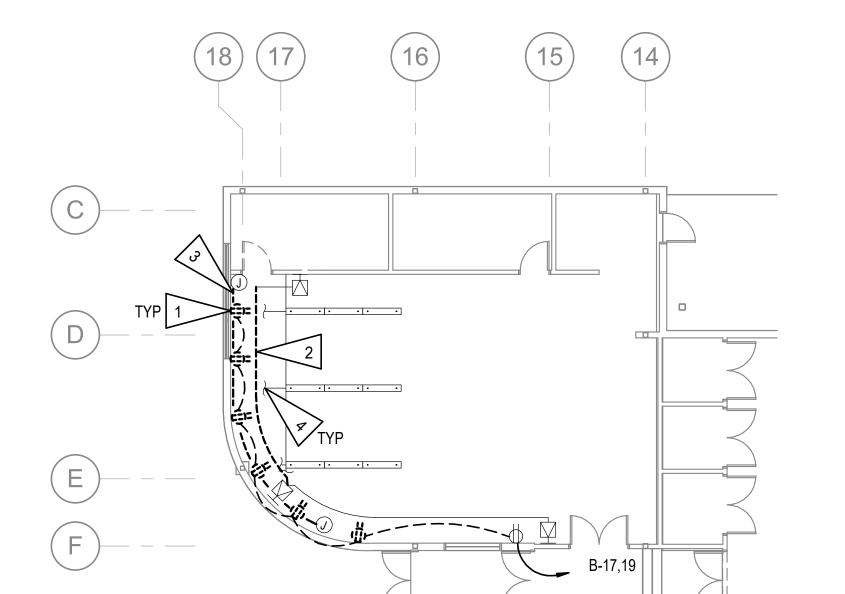
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JAM,RLW	REVIEWED BY:
	BEA1810MS:

ELECTRICAL DEMOLITION PLAN - ROOF

SHEET NO. **E101**





ENLARGED ELECTRICAL DEMO PLAN - ART 145

PANEL C HEAT TRACE CONTROL PILOT LIGHT SWITCH TO BE DEMOLISHED -**GFCI PROTECTION** PROVIDED BY EXTERNAL QO LOAD CENTER TO REMAIN -

GENERAL NOTES:

A. SEE E101 FOR GENERAL NOTES.

SHEET NOTES:

- DEMOLISH RECPTACLE AND BRANCH CIRCUIT IN FINTUBE ENCLOSURE BACK TO NEXT DEVICE TO REMAIN. CIRCUIT TO BE REUSED WITH NEW SURFACE MOUNTED RECEPTACLES AND RACEWAY. SEE E202.
- TEMPORARLY REMOVE AND RE-INSTALL SURFACE MOUNTED RACEWAY AND SPEAKER CABLING TO FACILITATE STRUCTURAL UPGRADES AND
- TEMPORARLY REMOVE AND RE-INSTALL SURFACE MOUNTED RACEWAY AND VIDEO SYSTEM CABLING TO FACILITATE STRUCTURAL UPGRADES
- SUPPORT CABLING ANCHORED TO WALL TO FACILITATE STRUCTURAL UPGRADES AND NEW CROSS BRACING.
- CONDUCTORS TO THE EXTENT POSSIBLE FOR NEW CONTACTOR IN NEW LOCATION. SEE REFERENCE PHOTO 3/E102.
- DEMOLISH EXISTING HEAT TRACE AND TERMINATION KIT. SAVE CIRCUIT FOR REUSE WITH NEW HEAT TRACE AT OR IN SAME LOCATION.
- DEMOLISH HEAT TRACE AND SAVE CIRCUIT FOR NEW HEAT TRACE IN SAME LOCATION.

PERMIT STAMP

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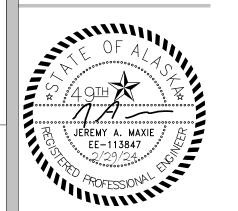
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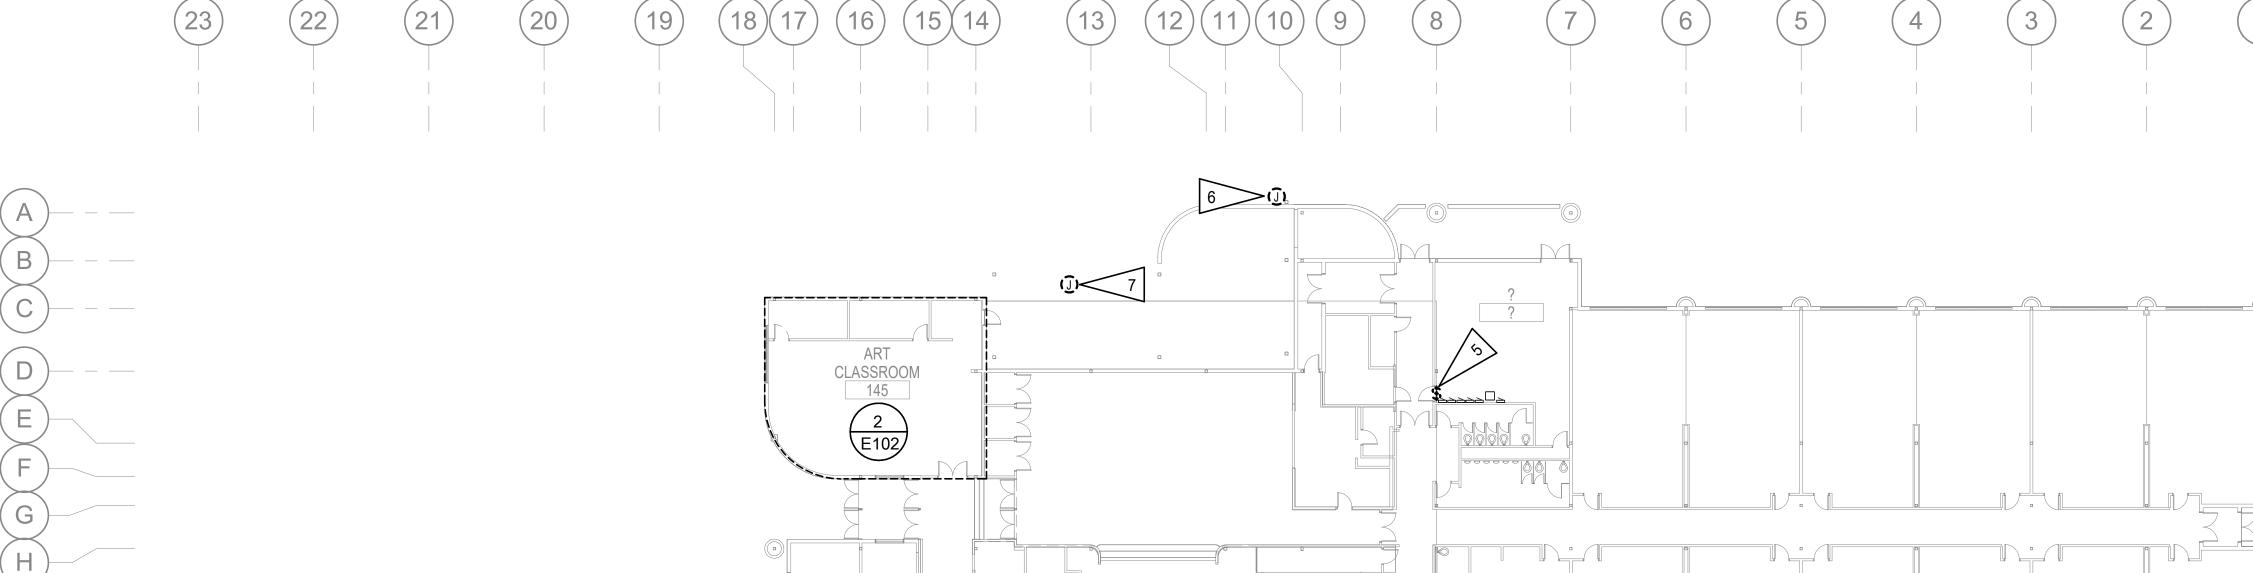
ELECTRICAL DEMOLITION PLANS - FIRST FLOOR

> SHEET NO. E102

ELECTRICAL DEMOLITION PLAN - FIRST FLOOR

NEW CROSS BRACING. AND NEW CROSS BRACING. TEMPORARLY REMOVE AND RE-INSTALL LIGHT FIXTURE SEISMIC DEMOLISH SWITCH FOR CONTROL OF HEAT TRACE. SAVE CONDUIT AND

HEAT TRACE CTRL REFERENCE PHOTO NO SCALE



GENERAL NOTES:

- A. SEE E101 FOR GENERAL NOTES.
- B. EXISTING CABLE TRAYS AND J-HOOK PATHWAYS ARE <u>NOT</u> SHOWN ON THE DRAWINGS BUT MAY BE USED FOR PART OF THE VIDEO CABLE PATHWAY. IF THE CONTRACTOR INTENDS TO RE-USE ANY EXISTING CABLE PATHWAY, THE EXACT LOCATION AND PATHWAY (CABLE TRAY OR J-HOOK) SHALL BE FIELD VERIFIED AND INDICATED ON THE SHOP DRAWINGS. ALL RE-USE OF EXISTING CABLE PATHWAYS SHALL BE IN ACCORDANCE WITH THE SPECIFICATIONS.
- C. SEE E303 FOR TELECOM ZONES, NEW CAMERA CABLING SHALL BE ROUTED TO THEIR DESIGNATED ZONES UNLESS PRIOR APPROVAL IS RECEIVED FROM ASD.

SHEET NOTES:

 DEMOLISH CAMERA. SALVAGE VIDEO OUTLET BOX AND UPSTREAM CABLING FOR REUSE.


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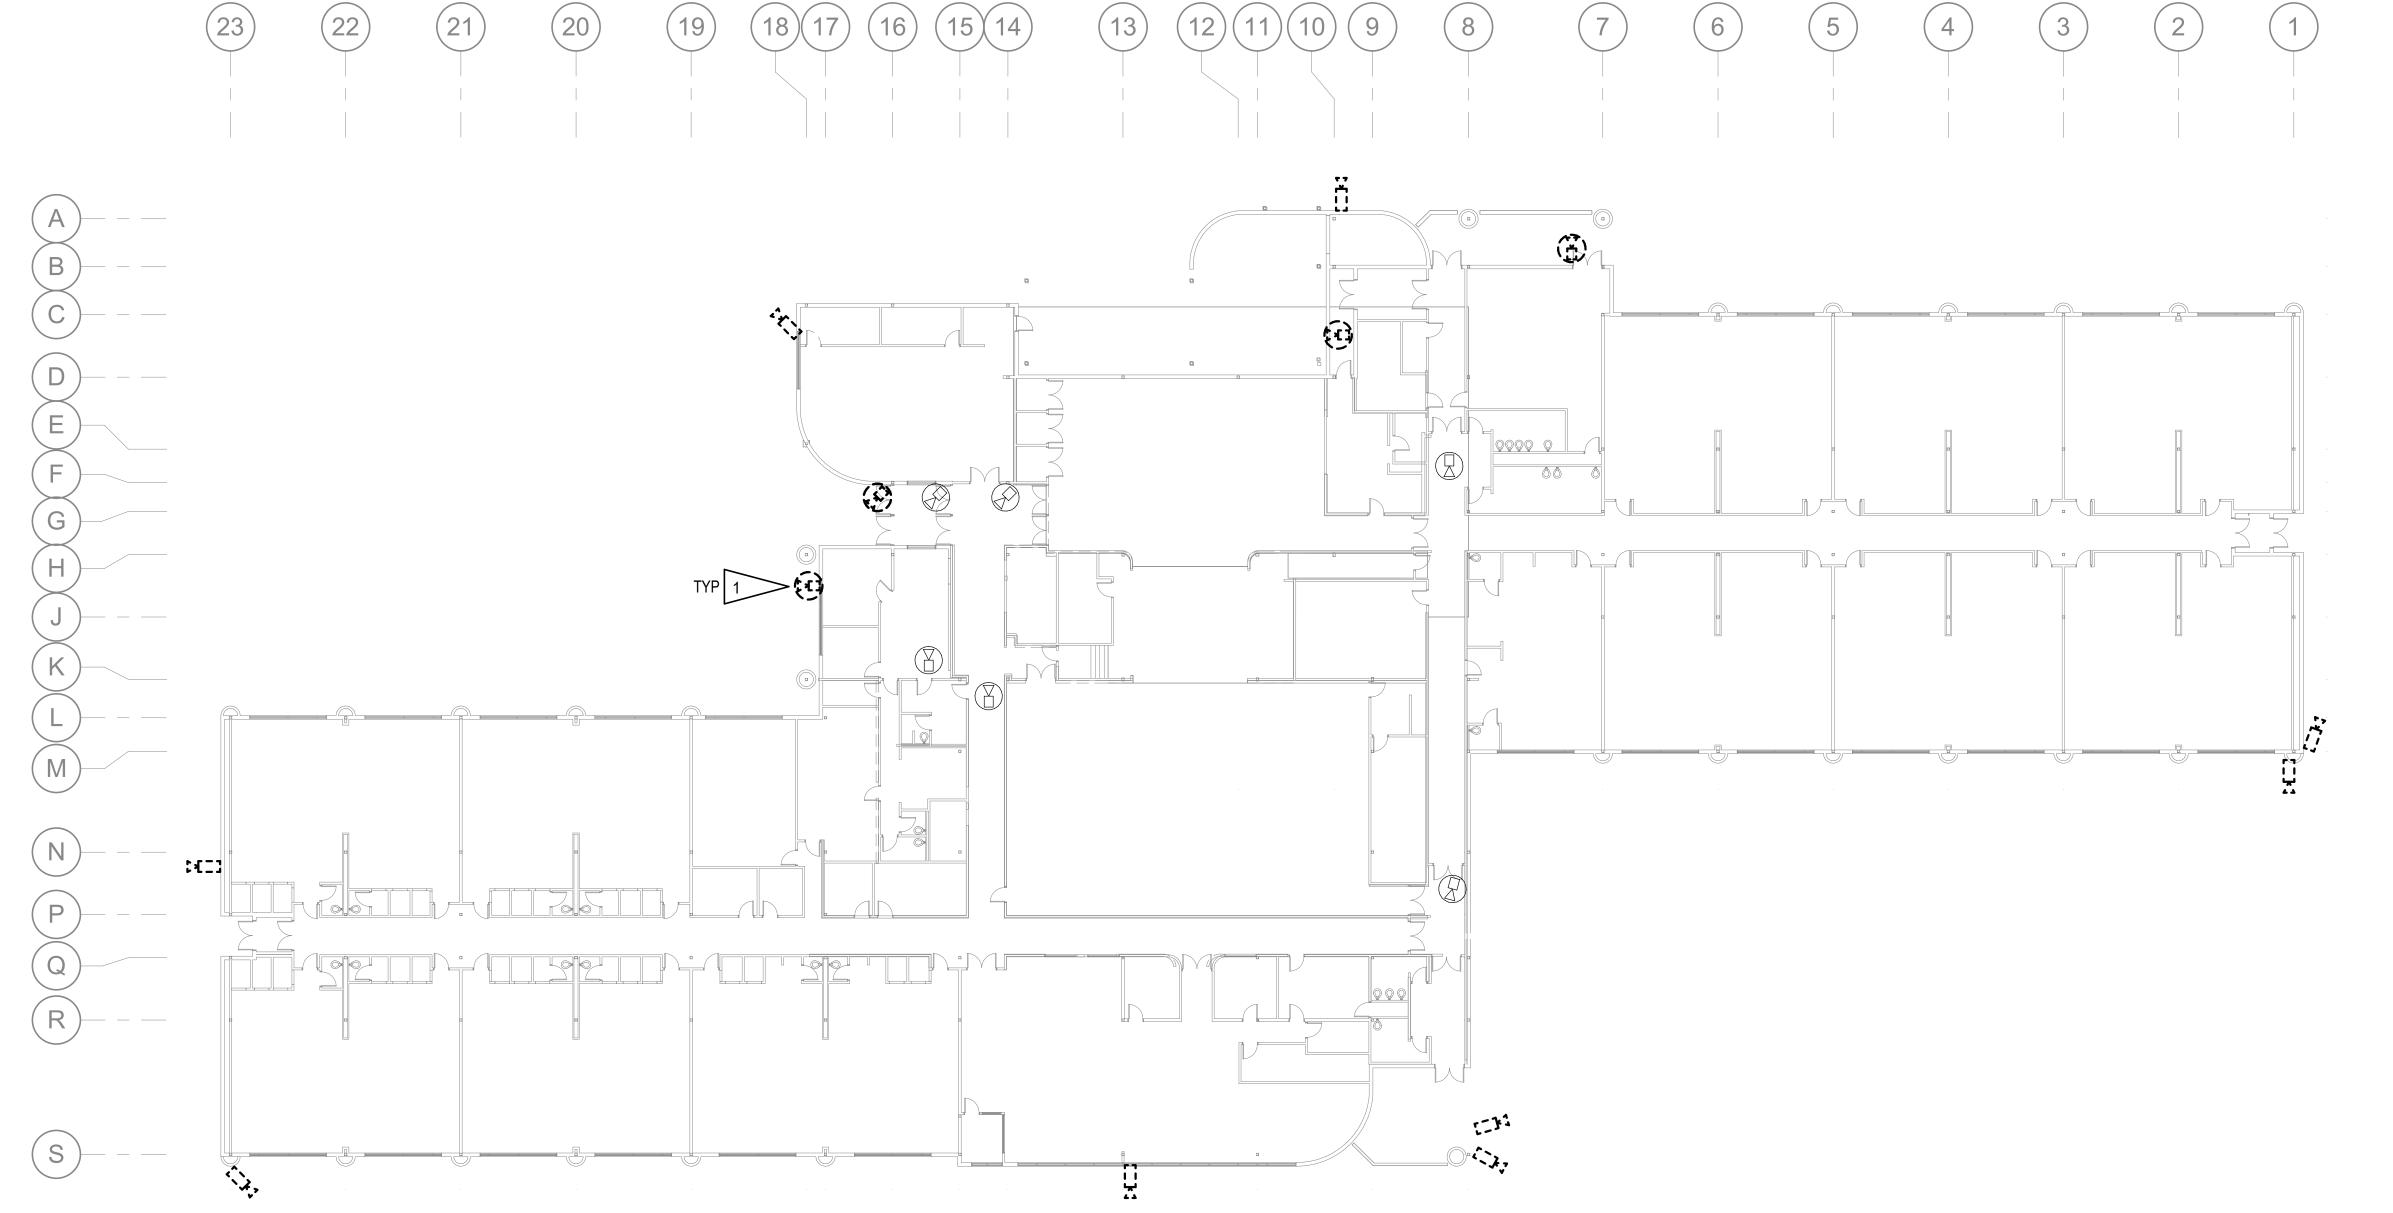
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JAM,RLW	REVIEWED BY:
	REVISIONS:

ADD ALT #1 VIDEO SYSTEM DEMOLITION PLAN

SHEET NO. **E103**



SHEET NOTES:

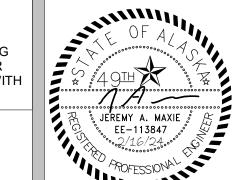1. REINSTALL WEATHER STATION ON NEW 1" GRS MAST. WEATHER STATION TO BE MOUNTED MINIMUM OF 5FT ABOVE ROOF. ORIENTATE STATION SUCH THAT SOLAR PANEL FACES SOUTH. REFERENCE ARCHITECTURAL PLANS FOR MAST ATTACHMENT DETAILS.

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FOR:

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PORTIONS OF THIS BUILDING ARE CLASSIFIED AS A CHILD OCCUPIED FACILITY IN ACCORDANCE WITH 40 CFR 745 AND LEAD-BASED PAINTS MAY BE PRESENT ON COMPONENTS TO BE DISTURBED IN THOSE AREAS. PERSONNEL PERFORMING WORK IN THESE AREAS MUST COMPLY WITH THE REQUIREMENTS OF 40 CFR 745, INCLUDING TRAINING, WORK PRACTICES AND CLEANING OF THE WORK AREA. REFER TO SPECIFICATION DIVISIONS 0, 1 AND 2 FOR SPECIFIC INFORMATION CONCERNING DISTURBING, REMOVING AND DISPOSING OF LEAD MATERIALS AND THE INSTALLATION OF NEW MATERIALS OR COMPONENTS. THIS NOTIFICATION IS PROVIDED IN ACCORDANCE WITH EPA AND OSHA REQUIREMENTS.

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ANCHORAGE SCHOOL DISTRICT

SPRING HILL ELEMENTARY SCHOOL ROOF REPLACEMENT


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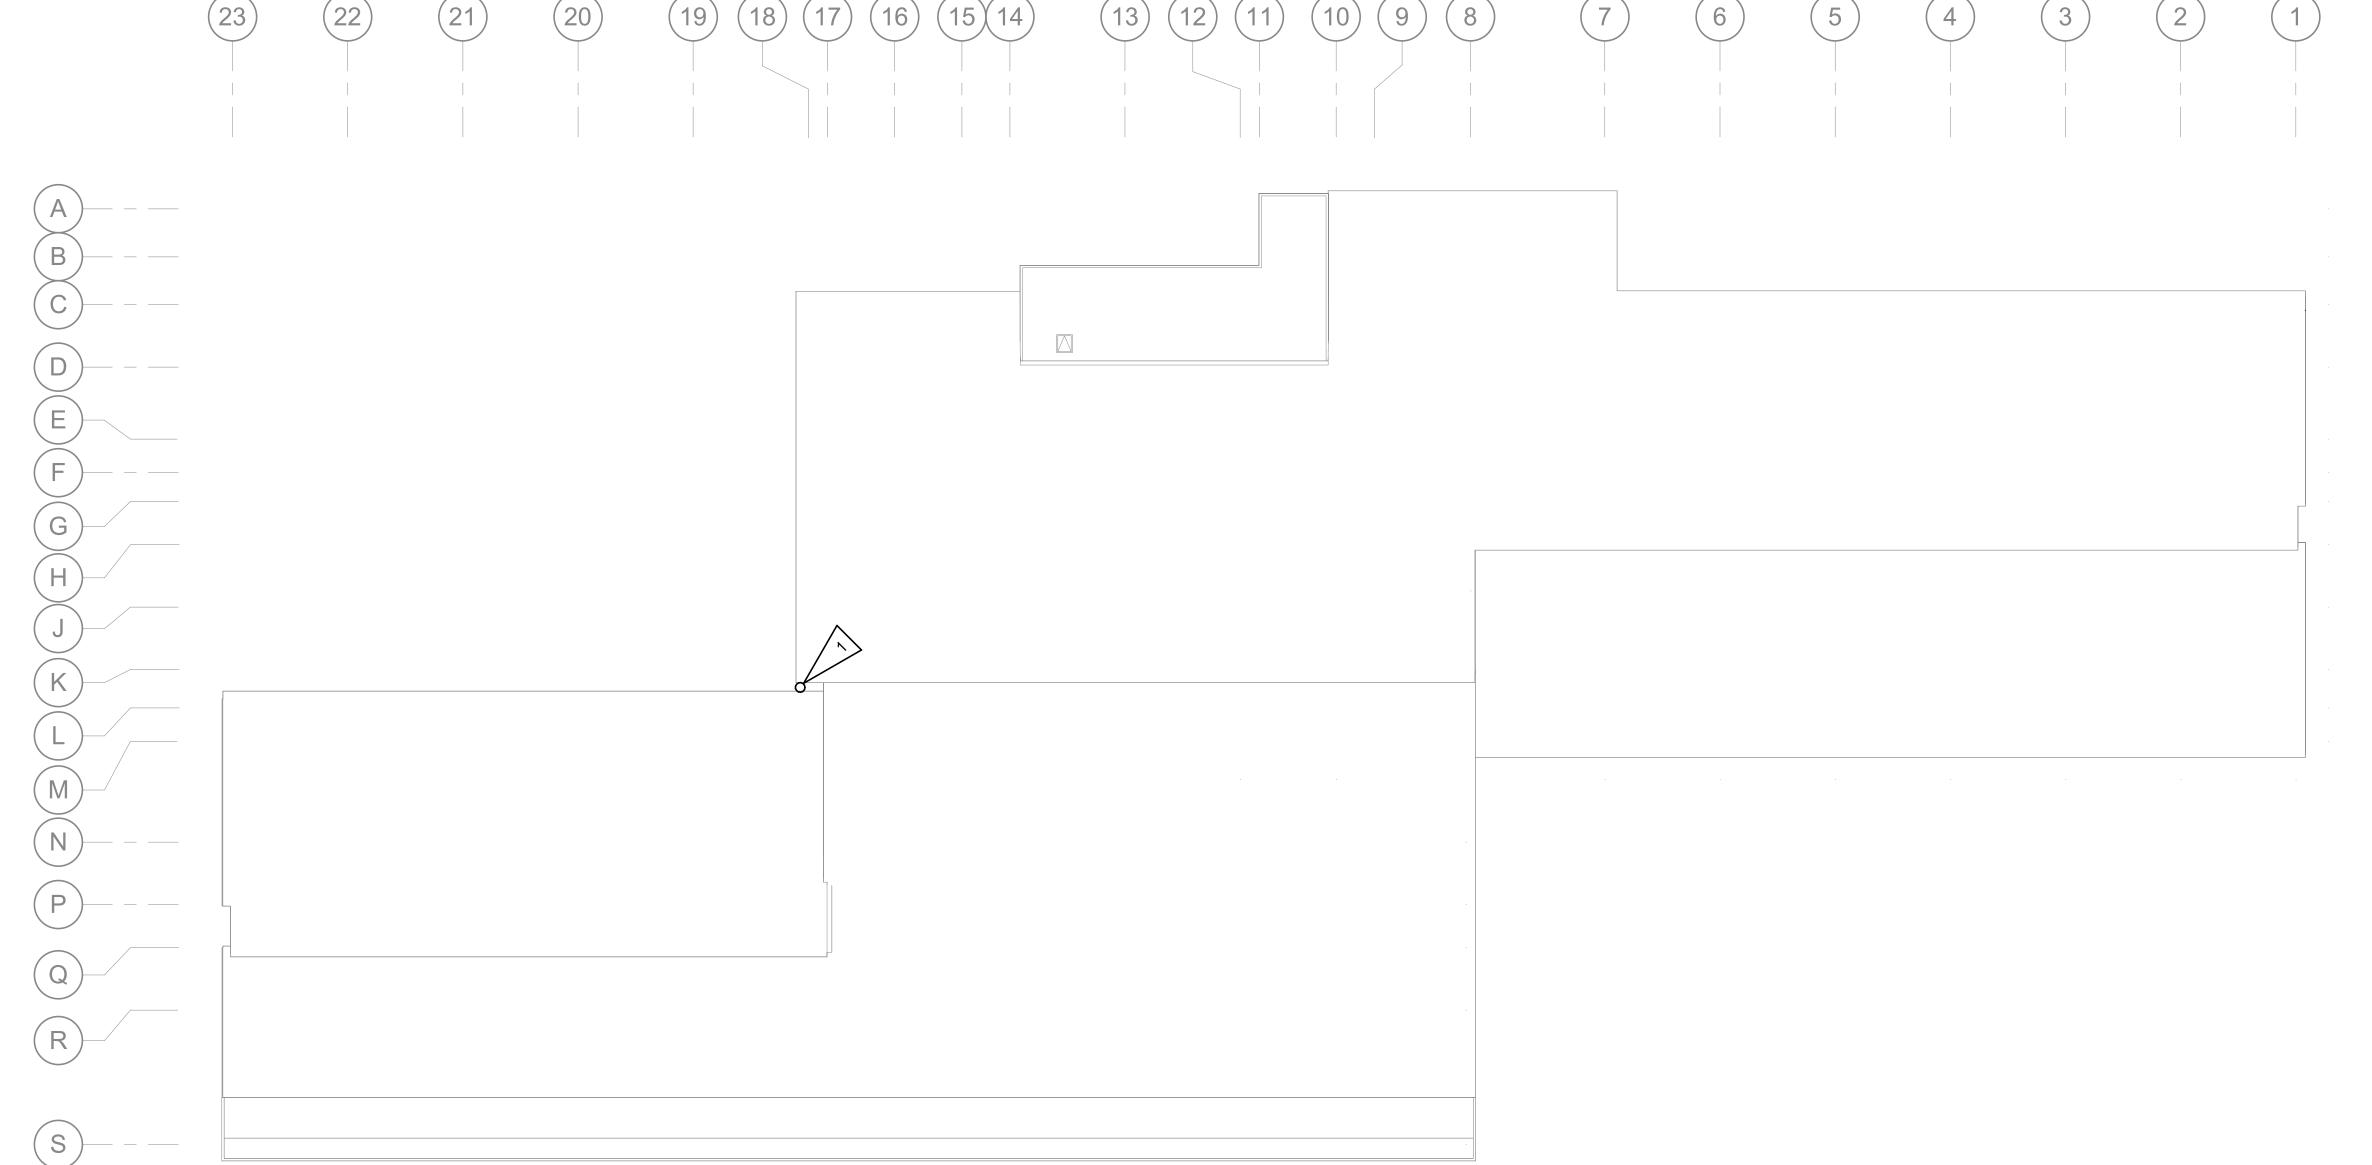
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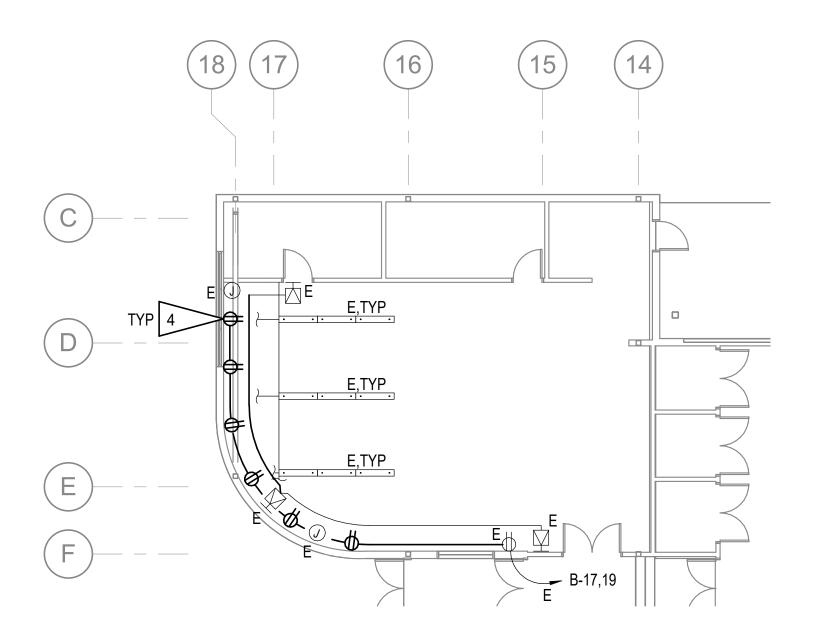
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JAM,RLW	REVIEWED BY:
	REVISIONS:

ELECTRICAL REMODEL PLAN - ROOF

> SHEET NO. **E201**





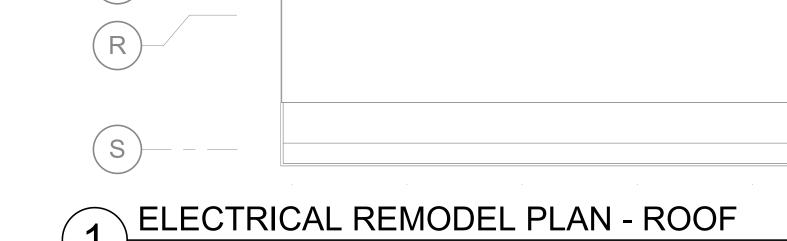

ENLARGED ELECTRICAL REMODEL PLAN - ART 145

SHEET NOTES:

- 1. NEW HEAT TRACE CONTACTOR, FIELD LOCATE. SEE 1/E001 FOR DETAIL. REROUTE EXISTING HEAT TRACE CIRCUIT TO NEW CONTACTOR.
- . INSTALL NEW HEAT TRACE IN EXISTING RAIN LEADER. PROVIDE 35FT OF HEAT TRACE. CONNECT TO EXISTING SAVED CIRCUIT.
- 3. INSTALL NEW HEAT TRACE IN EXISTING RAIN LEADER UP TO HEAT TRACE CONNECTION AT VERTICAL PIPE. CONNECT TO EXISTING SAVED CIRCUIT.
- 4. PROVIDE NEW SURFACE MOUNTED RECEPTACLES AND RACEWAY. MOUNT ABOVE NEW FINTUBE ENCLOSURE AT 30" AFF. CONNECT TO SAVED CIRCUIT, NEW CONDUCTORS SHALL BE MINIMUM #10 AWG.

PERMIT STAMP

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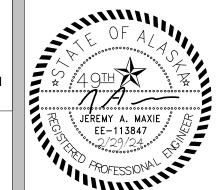
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ELECTRICAL REMODEL PLAN - FIRST FLOOR

SHEET NO. **E202**

(6)**HEAT TRACE** 12W/FT,120V BOILER ROOM 117 12W/FT,120V ART CLASSROOM 145 2 E202

ELECTRICAL REMODEL PLAN - FIRST FLOOR

1" = 20'-0"

GENERAL NOTES:

- A. APPROXIMATE LOCATIONS OF ALL CAMERAS ARE SHOWN ON THE DRAWINGS BUT EXACT LOCATIONS WILL BE DETERMINED BY ASD PRIOR TO START OF WORK. FOR BIDDING PURPOSES, CONTRACTOR SHALL ASSUME THAT ALL CAMERA LOCATIONS MAY CHANGE UP TO 20' IN ANY DIRECTION FROM THE SPECIFIED LOCATION.
- B. WHERE NEW CAMERAS ARE INSTALLED AT EXISTING LOCATIONS, THE MOUNTING HARDWARE MAY BE RE-USED IF COMPATIBLE WITH THE NEW CAMERAS.
- C. CAMERAS SHALL BE INSTALLED OUT OF THE DIRECT PATH OF SLIDING SNOW AND/OR ICE.
- D. NEW CAMERAS INSTALLED IN NEW LOCATIONS SHALL BE MOUNTED TO MATCH THE HEIGHT OF NEARBY DEMOLISHED CAMERAS. FINAL MOUNTING HEIGHTS OF ALL CAMERAS WILL BE DETERMINED BY ASD PRIOR TO THE START OF WORK.
- E. ALL CAMERA HORIZONTAL CABLING IS EXISTING TO REMAIN UNLESS OTHERWISE NOTED. CONTRACTOR SHALL PROVIDE NEW CAMERA FIELD PATCH CORDS AS REQUIRED TO CONNECT NEW CAMERAS TO EXISTING VIDEO OUTLET BOXES.
- F. SEE E302 FOR VIDEO SYSTEM GENERAL DETAILS.

SHEET NOTES:

- 1. NEW CAMERA AT EXISTING LOCATION.
- 2. NEW CAMERA AT NEW LOCATION WITHIN 10FT OF EXISTING LOCATION. RE-USE FIELD CABLING, PROVIDE NEW PATCH CORD.
- 3. NEW CAMERA AT NEW LOCATION. PROVIDE NEW CAT6 CABLING TO TELECOM RACK, TERMINATE AND TEST.

PERMIT STAMP

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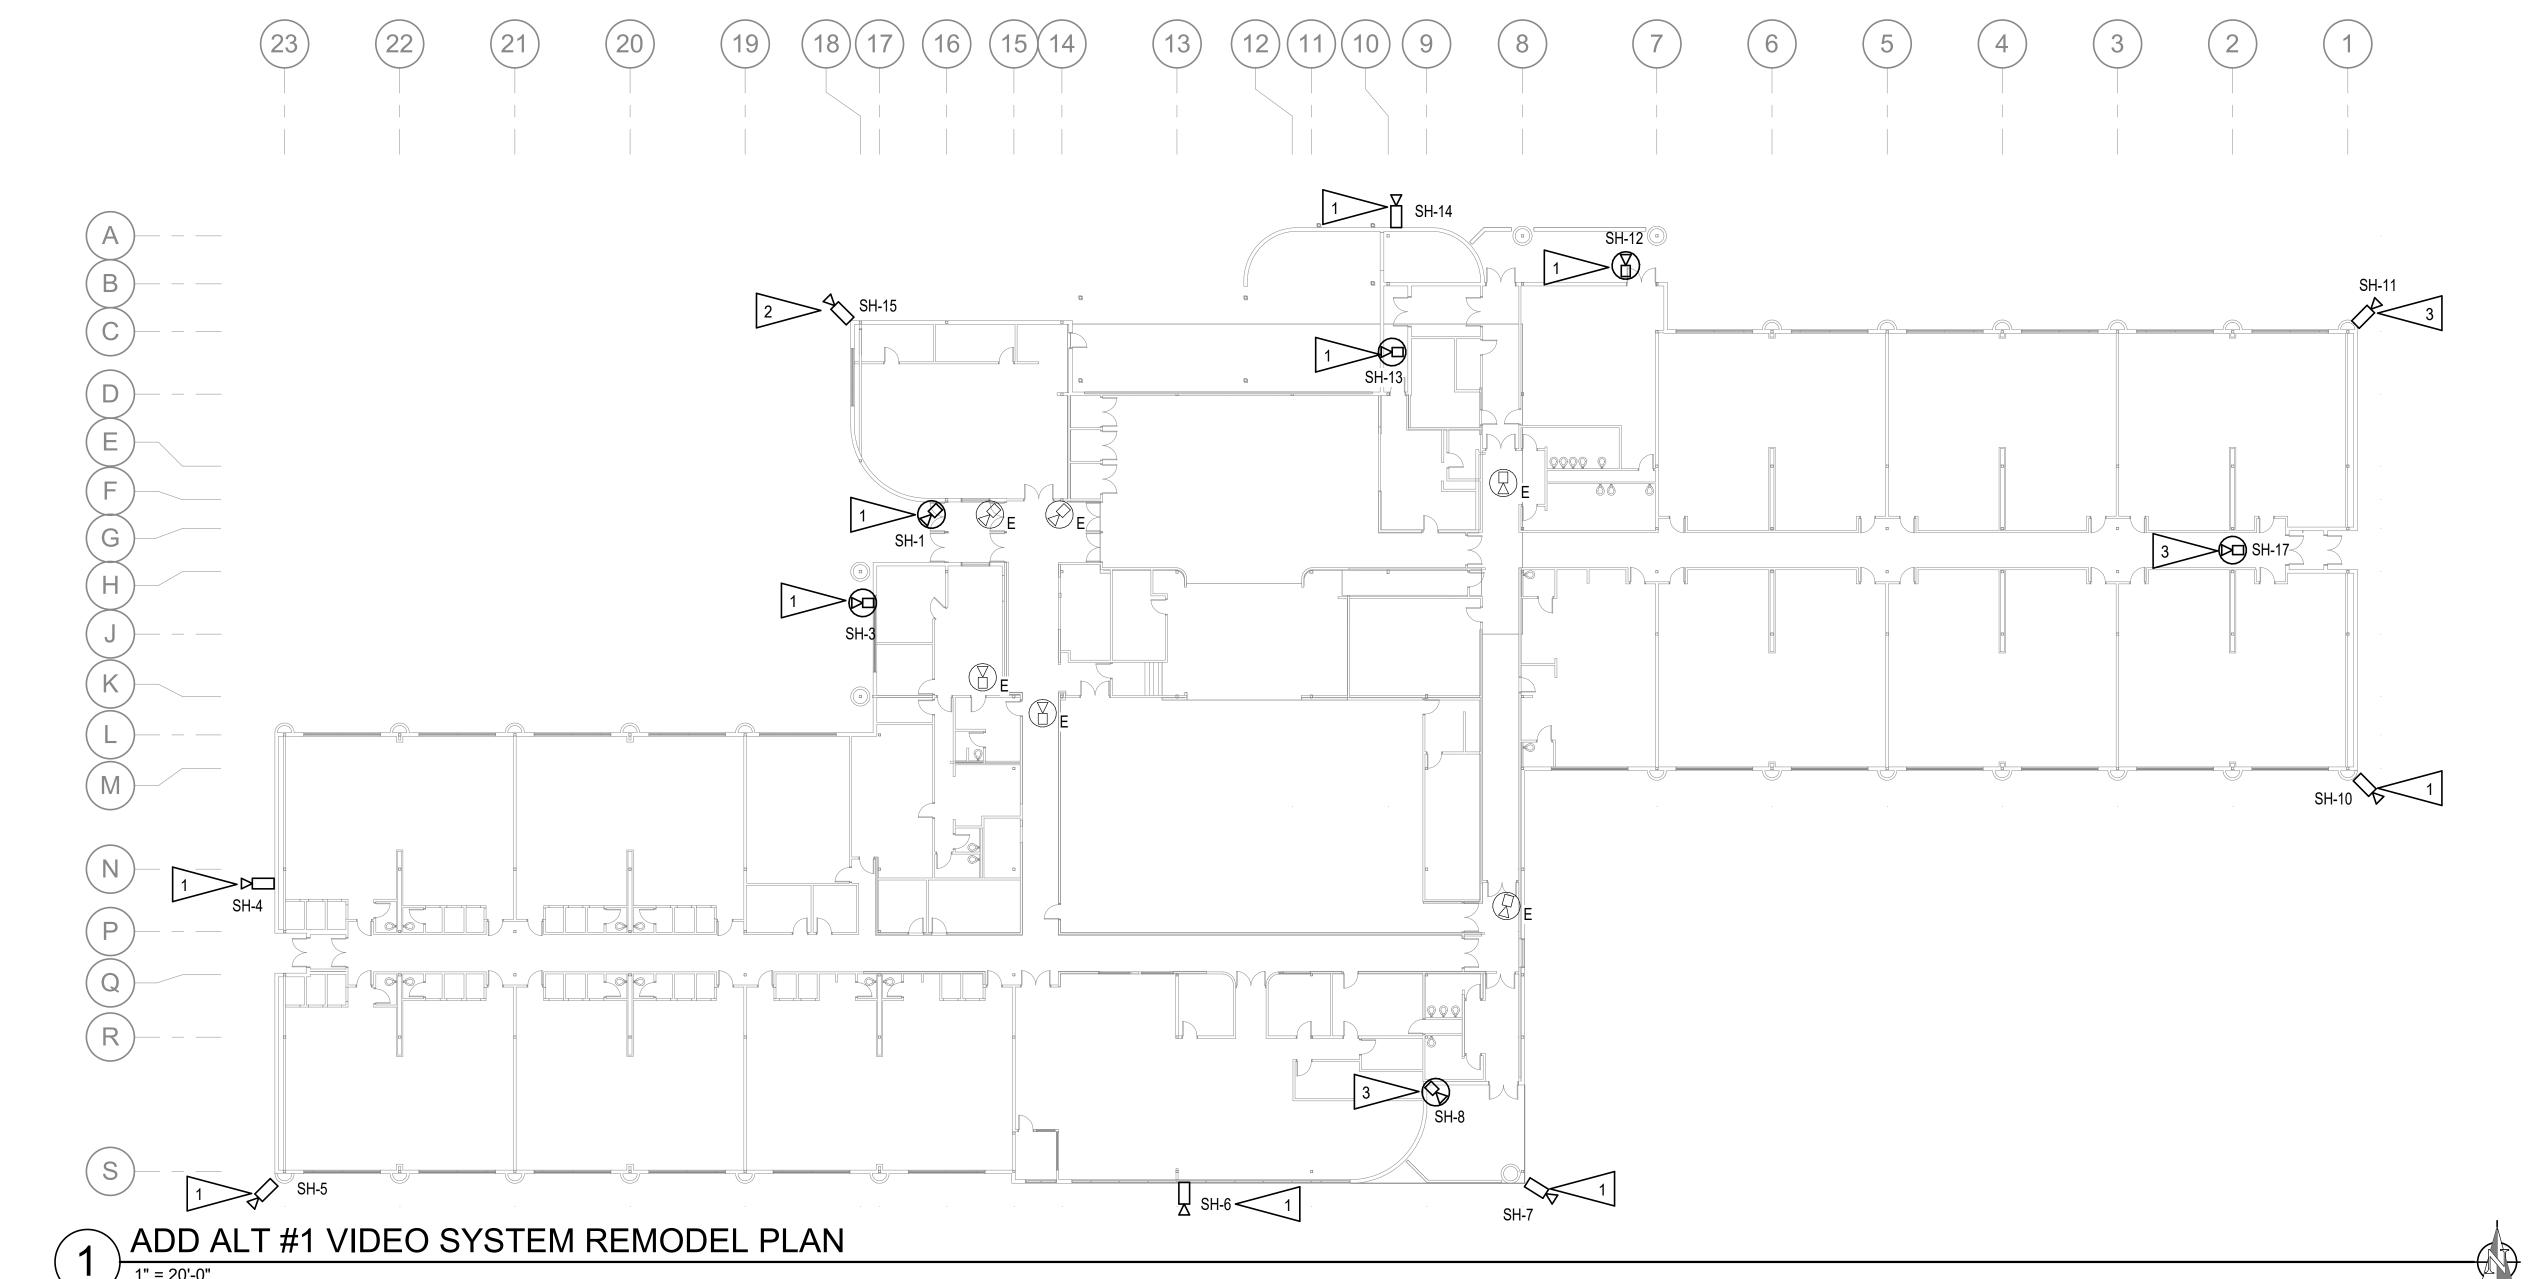
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ADD ALT #1 VIDEO SYSTEM REMODEL PLAN

SHEET NO. **E203**



- TELECOM

OUTLET

TELECOM RACK 'TR2'

DETAIL NOTES:

- . EXISTING POE NETWORK SWITCHES IN EXISTING TELECOM RACKS SHALL BE UTILIZED FOR CAMERA SYSTEM.
- 2. TERMINATE HORIZONTAL CABLE ON EXISTING PATCH PANEL IN EXISTING RACK IN TELECOM CLOSET, TYPICAL.
- 3. MAINTAIN CONNECTION TO ASD WAN.
- 4. EXISTING RJ-45 VIDEO JACK IN CAMERA BACKBOX. TYPICAL OF ALL JACKS AT EXISTING FIELD CAMERAS.
- 5. NEW CAMERA AT NEW/EXISTING LOCATION. PROVIDE CONNECTION TO EXISTING RJ-45 JACK IN NEAREST EXISTING VIDEO OUTLET BOX. SEE PLANS FOR CAMERA LOCATIONS.

IP VID	(ALL CABLES SPECIFIED IN SECTION 27 10 00)
CABLE NUMBER	DESCRIPTION
$\langle 1 \rangle$	EXISTING CAMERA PoE CABLE, CAT 6 UTP
2	NEW CAMERA FIELD PATCH CORD, CAT 6 UTP, LENGTH AS REQUIRED.
3>	EXISTING GIGABIT ETHERNET UPLINK PATCH CORD, CAT 6 UTP
4	EXISTING CROSS-CONNECT PATCH CORD, CAT 6 UTP
\$	EXISTING GIGABIT FIBER BACKBONE.
6	EXISTING NETWORK HORIZONTAL CABLE, CAT 6 UTP
7>	EXISTING MONITOR CABLE, DIGITAL CABLE.
8	EXISTING NETWORK CONNECTION
9>	NEW CAMERA PoE CABLE, CAT 6 UTP

PERMIT STAMP

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VIDEO SYSTEM ONE-LINE DIAGRAM

SHEET NO. **E301**

IP VIDEO SYSTEM CAMERA SCHEDULE SEE 1/E504 FOR ONE-LINE DIAGRAM CAMERA LOCATION INTENDED COVERAGE BASIS OF DESIGN MOUNTING TYPE **TELECOM** DESIGNATION RACK (SEE 1/E201) AREA MODEL# ZONE EXTERIOR VESTIBULE 100A. AXIS ENTRY/EXIT VESTIBULE 100A. CEILING-MOUNTED SH-1 VARI-FOCAL #P3265-LVE EXTERIOR PRINCIPAL'S OFFICE 149. GENERAL COVERAGE OF AXIS CEILING-MOUNTED APPROACH TO VESTIBULE 100A. VARI-FOCAL #P3267-LVE SW EXTERIOR CORNER-ROOM 171. GENERAL COVERAGE OF WALL-MOUNTED, ARM SH-4 MULTI-SENSOR #PNM-8082VT APPROACH TO WEST ENTRY. SW EXTERIOR CORNER-ROOM 172. GENERAL COVERAGE OF (4) 4MP AXIS CORNER-MOUNTED SH-5 MULTI-SENSOR #P3737-PLE PLAYGROUND. WEST EXTERIOR WALL-ROOM 149. GENERAL COVERAGE OF FIELD WALL-MOUNTED, ARM SH-6 AND PLAYGROUNDS. VARI-FOCAL #P3267-LVE SE CORNER AT CORNER-SOUTH GENERAL COVERAGE OF CORNER-MOUNTED SH-7 PLAYGROUNDS. |MULTI-SENSOR |#PNM-8082V1 SE CORNER EXTERIOR CANOPY ENTRY/EXIT CORRIDOR 300B. CEILING-MOUNTED SH-8 VARI-FOCAL #P3265-LVE CORNER-MOUNTED SE EXTERIOR CORNER-ROOM 102. GENERAL COVERAGE OF FIELD, (3) 2MP HANWHA **SH-10** EAST ENTRY AND GATE. MULTI-SENSOR #PNM-8082VT NE EXTERIOR CORNER-ROOM 101. GENERAL COVERAGE NE OF CORNER-MOUNTED MULTI-SENSOR #PNM-8082VT BUILDNIG AND EAST ENTRY. CANOPY EXTERIOR BOILER ROOM 117. | GENERAL COVERAGE OF NORTH | 2MP CEILING-MOUNTED **SH-12** VARI-FOCAL OF BUILDING. #P3265-LVE CANOPY EXTERIOR GENERATOR ROOM | GENERAL COVERAGE OF THE AXIS CEILING-MOUNTED **SH-13** VARI-FOCAL LOADING DOCK. #P3267-LVE GENERAL COVERAGE OF NORTH 5MP AXIS NORTH EXTERIOR WALL OUTSIDE WALL-MOUNTED, ARM PARKING LOT AND DRIVE LANE. VARI-FOCAL #P3267-LVE NW EXTERIOR CORNER-ROOM 145A. GENERAL COVERAGE OF TRAFFIC (3) 2MP HANWHA CORNER-MOUNTED NORTHEAST OF BUILDING. MULTI-SENSOR #PNM-8082V7 CORRIDOR 400. CORRIDOR TRAFFIC AND VEST. DUAL SENSOR CEILING-MOUNTED **SH-17** 400A ENTRY/EXIT. #PNM-7082RVD


VIDEO SYSTEM ONE-LINE DIAGRAM

NOT TO SCALE

PROVIDE ALL SUPPORT OF ELECTRICAL WORK INDEPENDENT OF THE CEILING AND CEILING SUPPORT SYSTEM.

C. TELECOM OUTLETS SHALL BE PROVIDED FOR EACH CAMERA. NO FIELD-TERMINATED PLUGS SHALL BE USED UNLESS PRIOR APPROVAL IS RECEIVED FROM ASD.

RECESSED CAMERA SUPPORT DETAIL-ACCESSIBLE GRID CEILINGS

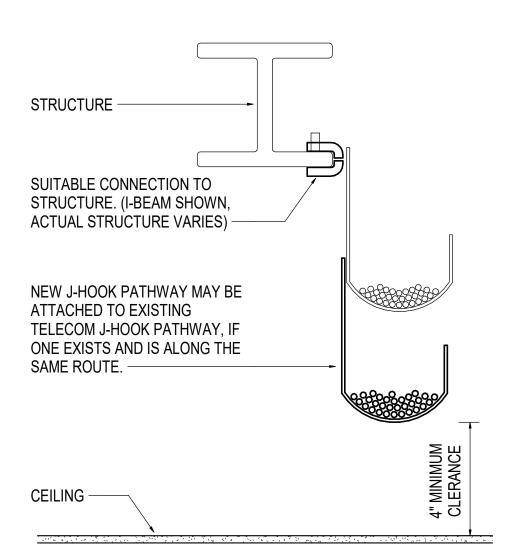


DETAIL NOTES:

- PROVIDE CONTINUOUS J-HOOK SUPPORT FOR ALL CABLING NOT REQUIRED TO BE INSTALLED IN CONDUIT AND WHERE CABLE TRAY OR RACEWAYS ARE NOT PROVIDED.
- SEE THE SPECIFICATIONS FOR J-HOOK RATINGS, SPACING CRITERIA AND SPARE CAPACITY REQUIREMENTS.
- PROVIDE ADDITIONAL SEPARATE J-HOOK PATHWAYS FOR EACH SYSTEM. CABLES SHALL NOT BE INTERMIXED BUT J-HOOKS FOR MULTIPLE SYSTEMS MAY BE CONNECTED TO THE SAME SUPPORT STRUCTURE.
- PROVIDE SPECIFIC MOUNTING HARDWARE FOR SUPPORT TO STRUCTURE TYPES AS NECESSARY. J-HOOKS MUST BE INSTALLED VERTICALLY AS

J-HOOK DETAIL - LOW-VOLTAGE CABLING

NOT TO SCALE

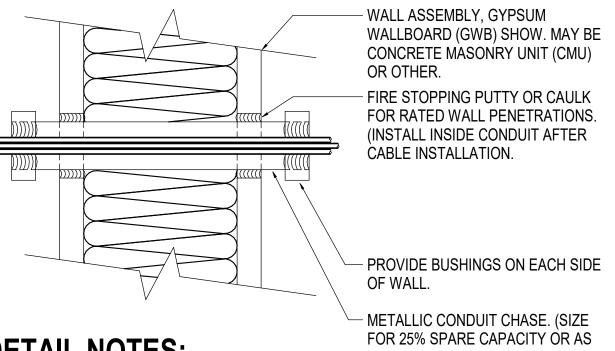

- A. THE PENETRATION SHALL BE A LISTED FIRE RATED SYSTEM AS REQUIRED BY THE RATING AND CONSTRUCTION TYPE OF THE WALL.
- B. PROVIDE UL LISTED FIRE STOPPING PER MANUFACTURER'S RECOMMENDATIONS AT ALL FIRE WALLS WHICH ARE PENETRATED.

4'-0" MAX

SPACING

CLOSET

RACK

EXISTING VIDEO

EQUIPMENT

PoE NETWORK SWITCH

CEILING -

FIELD CABLE

J-HOOKS MOUNTED ABOVE

CAMERA POWER/VIDEO/DATA


CONDUITS ON WALL. BRACE

NEW ASD SUPPLIED

EXISTING IN RACK.

SWITCHES AS NEEDED OR

WITH UNISTRUT AS REQUIRED.

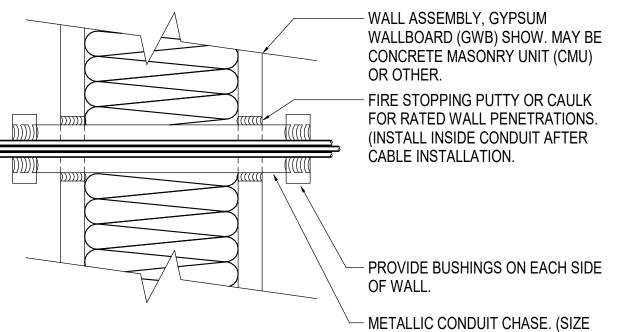

PERMIT STAMP

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NOTIFICATION OF CHILD OCCUPIED FACILITY

— GRID CEILING

RJ-45 JACK INSIDE

ALL EQUIPMENT.

DETAIL IS DIAGRAMMATIC AND IS MEANT TO

CAMERA TO DESIGNED CLOSET. SEE PLANS

FOR EXACT LOCATIONS AND QUANTITIES OF

SHOW THE TYPICAL CABLE ROUTE FROM

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- CAMERA FIELD

PATCH CABLE

TO VIDEO

CAMERA

, JEREMY A. MAXIE ,

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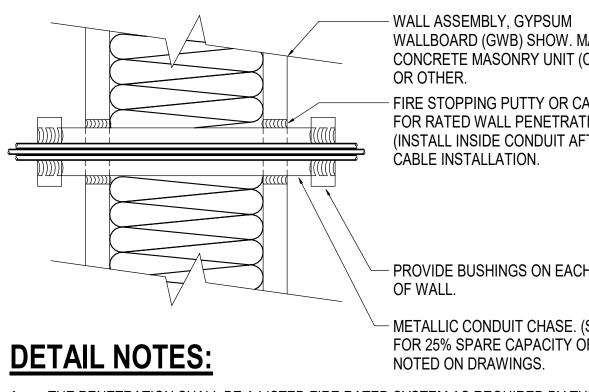
VIDEO FIELD CABLE ROUTING DETAIL NOT TO SCALE

SHEET NO.

VIDEO SYSTEM

DETAILS

E302



C. PENETRATIONS IN NON-RATED WALLS SHALL BE SEALED WITH SILICONE OR SIMILAR. TYPICAL WALL PENETRATION DETAIL



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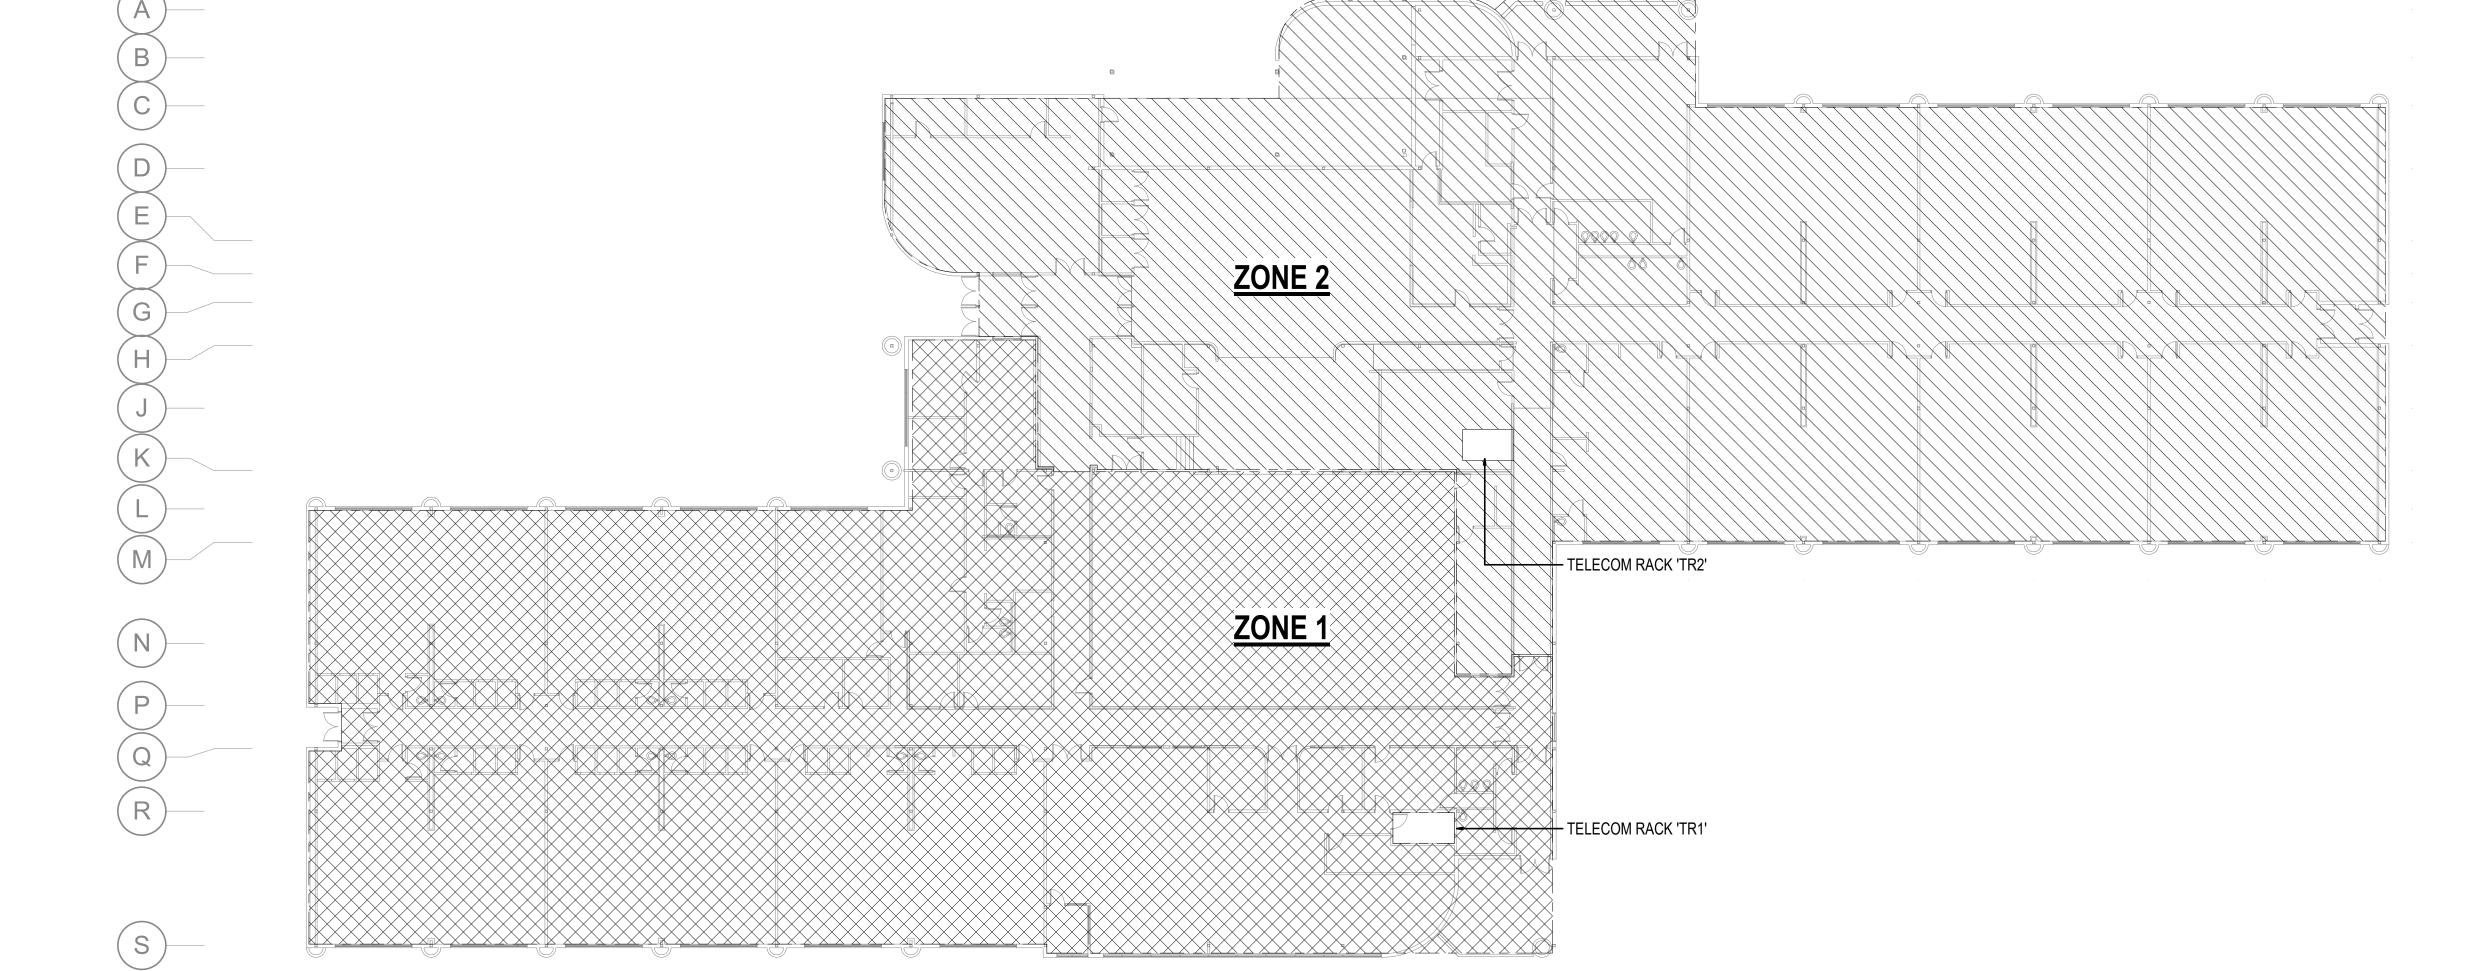
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VIDEO SYSTEM ZONE PLAN

SHEET NO. **E303**



(6)

VIDEO SYSTEM ZONE PLAN

1) $\frac{\sqrt{10L}}{1'' = 20'-6}$